WILTON	PLAN	NNING	AND
ZONINO	CON	<b>AMISS</b>	ION

#### SITE DEVELOPMENT PLAN

SDP#

ZONING DISTRICT

**SITE DEVELOPMENT PLAN:** Cite specific section(s) of the Zoning Regulations and provide a detailed description of the proposed development. Attach additional sheets as required.

detailed descr	detailed description of the proposed development. Attach additional sheets as required.		
Section 29 -  This development proposes to convert an existing building, from a mix use property into a 17 unit apartment building, at 2 Hollyhock Road, Wilton CT under the State's 8-30g regulation. The proposed conversion will consist of three floors and a basement with 6 Studio apartments, 6 one- bedroom apartments, and 5 two-bedroom apartments.			
			Clark Holdings, LLC 2 Hollyhock Road,
APPLICANT	I'S NAME	ADDRESS	
Clark Holdir	ngs, LLC	2 Hollyhock Road, Wilton, CT	
OWNER'S N	NAME	ADDRESS	
2 Hollyhock	Road, Wilton, CT 06897	DE5	

528 68 30 .49

WLR VOLUME PAGE TAX MAP # LOT # ACREAGE

#### THE FOLLOWING MATERIALS SHALL BE ATTACHED:

- \* Fifteen (15) complete COLLATED/FOLDED sets are required.
- \* All plans shall be equal in sheet size, collated into sets (either stapled or clipped), with maps folded, not rolled.
- \* All submitted plans and documents shall bear an original signature, seal, and license number of the professional responsible for preparing each item.
- X VICINITY SKETCH at a scale of 1"=100' or 1"=200'. Said map shall show all existing zone boundaries, existing buildings and parcels, labeled by their corresponding Tax Map and Lot Number, within 500' of the subject property.
  - X CLASS A-2 SURVEY MAP of the subject property.
- X SITE DEVELOPMENT PLAN pursuant to Section 29-11 of the Zoning Regulations.
- X FORM B ZONING DATA.

PROPERTY LOCATION

- X LIST OF PROJECT PROFESSIONALS including name, firm, address and telephone.
- X LETTER OF TITLE certifying owner of record as of date of the application.
- X PROOF OF APPLICANT'S LEGAL INTEREST in property.
- X ANY OTHER PLAN OR DOCUMENT as required by Zoning Regulations.
- X ELECTRONIC SUBMISSION of all application materials (e.g. Flash drive, PDF email)
- X \$360 FILING FEE + \$50/Unit or \$50/2000 sq. ft. payable to: Town of Wilton.

#### **ASBUILT PLAN**

OF PROPERTY PREPARED FOR

## ARTIFACT DESIGN GROUP

#2 HOLLYHOCK ROAD, WILTON, CONNECTICUT

SCALE: 1" = 20'

DATE: JAN. 20, 2004

BY "ARCAMONE LAND SURVEYORS"

REFER TO ZONING BOARD OF APPEALS VARIANCE #03-09-31, 03-09-32 & RESOLUTION #1203-8Z

		REQUIR	ED/ALLOV	WED	FOUNDATION	ASBUILT
	FRONT SETBACK	* 31' APPROVED	100'	MIN.	31.4'	31.0'+
	REAR		50'	MIN.	87.5'±	87.4'±
	SIDE	* 17' APPROVED	50'	MIN.	17.7'±	17.7'±
ALL	SIDE TO HOLLYHOCK RD	* 24' APPROVED	50'		24.4'±	24.0'
PLANS	AGGREGATE SIDE		N/A	MIN.		
	LOT FRONTAGE		150'	MIN.	104'	104'
	LOT AREA		21,780sf	MIN.	21,173sf	21,173sf
	HEIGHT		39'	MAX.	-	33.9'±
	# OF STORIES		3	MAX		3
	LOT COVERAGE: BUILDING	* 21% APPROVED	20%	MAX	nem to fin	21%
		* 56.6% APPROVED	50%	MAX		56.5%**

\*\* BLUESTONE/COBBLE ON STONE DUST WALKWAY NOT INCLUDED IN COVERAGE

THIS SURVEY MEETS THE STANDARD OF A CLASS "A-2" SURVEY.

SURVEY TYPE: ZONING LOCATION SURVEY

BOUNDARY DETERMINATION : DEPENDENT RESURVEY

THIS SURVEY AND MAP WERE PREPARED IN ACCORDANCE WITH THE "RECOMMENDED STANDARDS FOR SURVEYS AND MAPS IN THE STATE OF CONNECTICUT". SEC. 20-300b-1 to 20-300b-20. EFFECTIVE; JUNE 21,1996 AS ADOPTED BY THE CONNECTICUT ASSOCIATION OF LAND SURVEYORS INC., SEPTEMBER 26, 1996

THE CERTIFICATION SHOWN ABOVE RUNS TO THE PERSON(S) FOR WHOM THE SURVEY WAS PREPARED AND ANY GOVERNMENTAL AGENCY, TITLE INSURANCE CO., OR LENDING INSTITUTION WHOSE NAME APPEARS ABOVE. CERTIFICATION IS NOT TRANSFERABLE.

UNDERGROUND IMPROVEMENTS OR ENCROACHMENTS IF ANY, ARE NOT SHOWN.

THIS MAP IS INVALID WITHOUT A LIVE SIGNATURE AND EMBOSSED SEAL.

REFERENCES TO THE ABOVE PROPERTY ARE MADE TO MAP(S) No. 528, 5278 W.L.R. &

TAX MAP 68 & TAX LOT(S) 30


PROPERTY IS LOCATED IN ZONE : "DE-5"

MAP OF PROPERTY PREPARED FOR MAP OF PROPERTY PREPARED FOR ARTIFACT DESIGN GROUP, GREG & ELIZABETH CLARK 66 DANBURY RD WILTON, CT 1" = 20' 8/15/03 LAST REV. 9/3/03 BY ROLAND H. GARDNER

DISTANCES SHOWN +/- FROM BUILDINGS TO PROPERTY LINES ARE NOT TO BE USED TO ESTABLISH BOUNDARIES.

"TO MY KNOWLEDGE AND BERIEF, THIS MAP IS SUBSTANTIALLY CORRECT AS NOTED HEREON"

CONNECTICUT REG # 15773 Com mon WAYNE I ARCAMONE, LAND SURVEYOR, NORWALK, CONN.

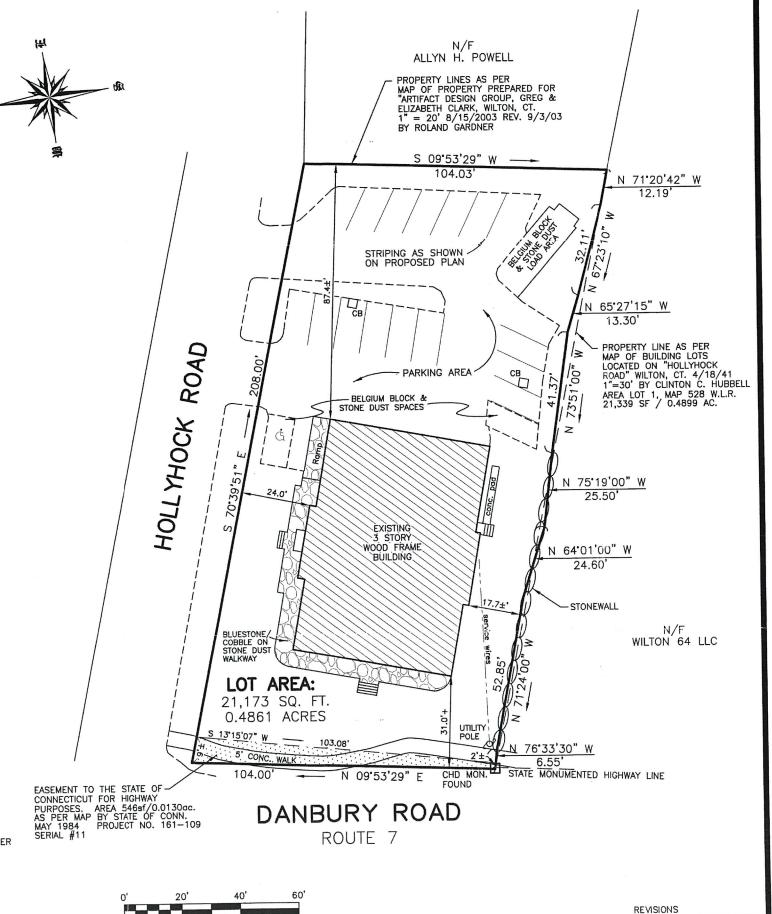

GRAPHIC SCALE

RY

AAT

AAT

JAD


DESCRIPTION

DATE


3/10/04 OFFSETS


12/01/04 COVERAGE ASBUILT

9/23/04 ASBUILT

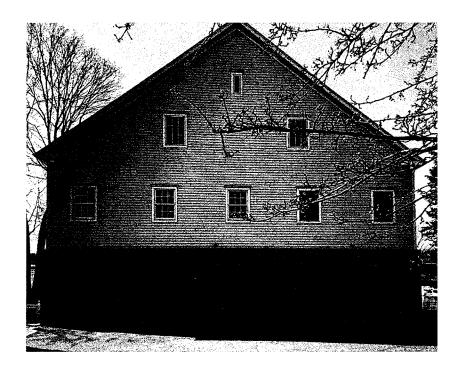



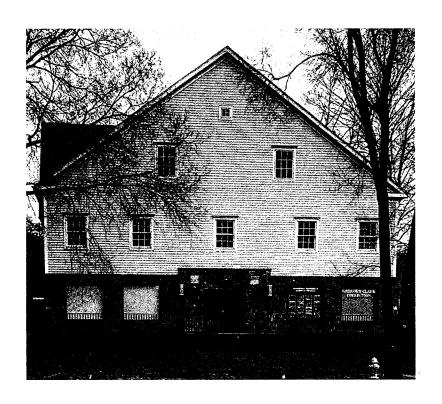

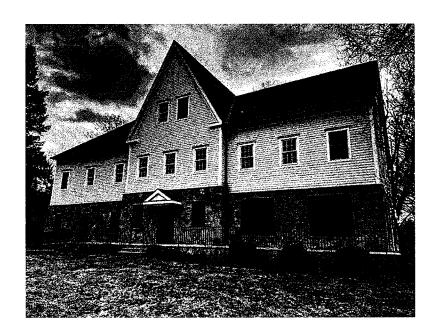

Project PROPOSED 8-30g AFFORDABLE RESIDENTIAL UNITS

# **CLARK HOLDINGS, LLC**

2 HOLLYHOCK ROAD, WILTON CT

Douglas Cutler Architect, AIA - Code Consultant

(203)761-9561

Gregory Clark Designer, Industrial Designer, RISD

(203)515-1122

Drawing Title

# **ART HOUSE**

2 HOLLYHOCK ROAD, WILTON CT

Date Prepared 3/20/2020

Date Revised 11/10/2020

Drawing No.

# **Existing Elevations** As- Built

Gregory Clark Collection
Interior/Exterior Design, General Contractor
2 Hollyhock Road Wilton, CT 06987
(203) 515-1122


Architectural Plans & Code Consultant Code/Engineering/Architectural Design Douglas Cutler Architects A.I.A. 221 Danbury Road, Wilton. CT 06897 (203)761-9561

P.W.Scott Engineering and Architecture, P.C. Traffic Study & Parking Study 3871 Danbury Road Brewster, NY 10509 (845) 278-2110

Jim Murphy Gregory & Adams, P. C. Legal Counsel 190 Old Ridgefeild Road, Wilton, CT 06897 (203) 762-9000

Wayne Arcamone, Land Surveyors 4 Taft Street, Norwalk, CT 06854 (203) 866-2058 David Seymour, P.E. PMB#350 Original Engineer 1771 Post Road East, Westport CT 06880 (203) 259-8911

Atlantic Engineering 525 John Street, Bridgeport CT, 06604 (203) 336-4422

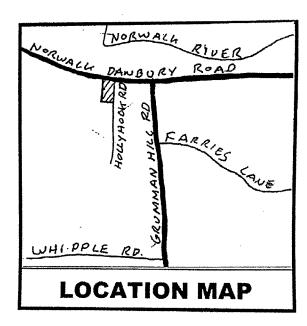

Project PROPOSED 8-30g AFFORDABLE RESIDENTIAL UNITS		Drawing Title	
CLARK HOLDINGS, LLC		ART HOUSE	
2 HOLLYHOCK ROAD, WILTON CT			YHOCK ROAD, WILTON CT
Douglas Cutler Architect, AIA - Code Consultant	(203)761-9561	Date Prepared 3/20/2020	Date Revised 11/10/2020
Gregory Clark Designer, Industrial Designer, RISD	(203)515-1122		

Drawing No.

# PROJECT PROFESSIONALS

### PROPOSED AFFORDABLE 8-30G HOUSING CONVERSION

2 HOLLYHOCK LANE, WILTON, CT

	EGRESS REQUIREMENTS	6. EXIT PASSAGEWAYS (1020.2) 44" MINIMUM WIDTH
CODE ANALYSIS:	I. OCCUPANCY CALCULATIONS	1. EXIT DOORS
APPLICABLE CODES:	A. MAXIMUM SQ. FT. PER OCCUPANT (TABLE 1006.1)	A. DOOR LEAF (SECTION 1008.1.1)  MIN. MIDTH 34" ( 32" CLEAR), MAX.  MIDTH: 48" DOOR OPENINGS TO  BE MIN. 80" HIGH
2015 INTERNATIONAL BUILDING CODE (IBC) 2015 INTERNATIONAL EXEGRY CONSERVATION CODE (IECC) 2015 INTERNATIONAL MECHANICAL CODE (IMC) 2015 INTERNATIONAL PLUMBING CODE (IPC) 2017 INTERNATIONAL FLUMBING CODE (IECC) 2018 INTERNATIONAL FIRE CODE (IEC) 2018 INTERNATIONAL FIRE CODE (IEC)	RESIDENTIAL 200 GROSS SQUARE FEET PER OCCUPANT  B. MAXIMM 92. FT. PER OCCUPANT (TABLE 1000.1)  BUILDING CALCULATED	B. DOOR SAINS IN DIRECTION OF TRAYEL FOR OCCUPANT LOAD OF 50 OR MOTR (1008.1.2)
USE GROUP CLASSIFICATION:	FISRT FLOOR 1439.] SQ FT 🛕 SECOND FLOOR 1439.] SQ FT	
BUILDING I		8. STAIRWAYS (SECTION 1009.0).
I. BUILDING USE HOUSING	2. EGRESS MIDTH	A. MINIMUM EGRESS WIDTH: 36 INCHES WHEN SERVING AN OCCUPANCY LOAD OF 50 OR LESS B. MINIMUM LANDING WIDTH WOT LESS THAN REQUIRED STAIR WIDTH, NEED
2. USE GROUP (SECTION 302.1) R-2	EGRESS WIDTH PER OCCUPANT WHEN SPRINKLERED 3 INCHES AT STAIRWAYS 2 INCHES AT DOORS, RAMPS, AND CORRIDORS CORRIDORS	NOT ECCED 4"-0" WHEN STAIR HAS STRAIGHT RUN
3. OCCUPANY SEPARATION   HR	EGRESS WIDTH (FOR TOTAL OCCUP. EGR. WIDTH EGR. WIDTH	D. VERTICAL RISE PER RUN: 12" MAXIMUM
BETWEEN USE GROUPS N/A HRS WSPRINKLERS (TABLE 3023.2)	STAIRS) REQUIRED PROVIDED	E. RISER HEIGHT: 6 1/2" MAIMM 4" MINIMM  F. TREAD DEPTH: 9" MINIMM  6. DIMENSIONAL VARIATION: 9/6" MAXIMM IN PLIGHT OF STAIRS
CONSTRUCTION CLASSIFICATION PROPOSED:	SECOND FLOOR 20 6" 36"	H. HANDRAILS AND QUARDRAILS: SEE SECTION 9 & 10 BELON  1. EGRESS DOORS: SE "MIN GOVERNS PER ADA 48" MAX DOOR  LEAF WIDTH NOT TO ENCROACH EGRESS WIDTH
I. TYPE OF CONSTRUCTION COMBUSTIBLE	EGRESS WIDTH: (FOR TOTAL OCCUP. EGR. WIDTH EGR. WIDTH PROVIDED, PROVIDED,	MORE THAN ONE-HALF WHEN OPENING T " MAX, PROJECTION INTO EGRESS MIDTH WHEN FULLY OPEN
NEA CONSTRUCTION (SECTION 602)  TYP VB	FIRST FLOOR 20 4" 36" 3 SECOND FLOOR 20 4" 36" 4	J. ROOF ACCESS STAIR (1009.12)  REQUIRED IN BUILDINGS GREATER THAN 3 STORIES IN HEIGHT
FIRE SEPERATIONS:		9. HANDRAILS (SECTION 1009.12)
BUILDINGS 1, 2, 3 TYP VB COMBUSTILE, EQUIPPED WITH WITH AUTOMATIC FIRE SUPPRESSION SYSTEM BUILDING ELEMENTS (TABLE 601)	3. NIMBER OF EXITS REQUIRED: OCCUPANCY LOAD  TABLE IOIA! OR LESS TABLE IOIB! TO 500 501 - 1000 OVER 1000	A. MAXIMM HANDRAIL PROJECTION: 4 I/2"  B. HANDRAIL HEIGHT: 34" - 36"  C. STAIRMAY HANDRAIL GRIP: I I/4" DIAMETER MINIMUM  2" DIAMETER MAXIMUM
A. STRUCT, FRAME (COLUMNS, GIRDERS, TRUSSES) O HRS BI. EXTERIOR BEARING MALLS O HRS BIZ. INTERIOR DEARING MALLS O HRS CC. INTERIOR NONBEARING MALLS O HRS CC. INTERIOR NONBEARING MALLS O HRS D. FLOOR CONSTRUCT (INC. BEAMS AND JOISTS) O HRS E. ROOF CONSTRUCT (INC. BEAMS AND JOISTS) O HRS	MAXIM LENGTH OF EXIT ACCESS TRAVEL TABLE IOIS.1  250' WHEN SPRINKLERED MINIMUM EXIT SEPARATION DISTANCE MINIMUM ONE-THIRD OF THE	IO. SUARDRAILS (IO21.0) A. HEIGHT: B. OPENING LIMITS: 42° MINIMUM TO TOP OF RAIL 44° SPHERE NOT TO PASS THRU ANY OPENING UP TO A HEIGHT OF 54° (34'-42'',0') 6° SPHERE NOT TO PASS THRU TRIANGLIAR OPENING AT STAIR RISER, TREAD AND BOTTOM RAIL.
MISCELLANCUS ELEMENTS  F. DEMISE WALLS  I HR	TABLE 1014.2.1 MAXIMM OVERALL DIAGONAL DIMENSION OF AREA SERVED, WHEN SPRINCLERED	— (3) DETAIL INDICATOR
6. SMOKE BARRIERS (SECTION 104.3) I HRS H. SMOKE PARTITIONS (SECTION 110.5) O HRS	DEAD END CORRIDOR     MAXIMUM DEAD-END CORRIDOR LENGTH 20 FT. OR 2.5 TIMES THE	_
FLAME SPREAD CLASSIFICATION	(1016.3) MIDTH OF THE CORRIDOR, OR 50 FT, IN GROUPS B WHEN SPRINKLERED (NPPA 18)	
GROUP SPRINKLERED  INTERIOR BUT STAIRWAYS  1 RAPES 1 BUT PASSAGENAYS  ROOMS 1 BIKLOSED SPACES  1 RAPES 1 BUT PASSAGENAYS  ROOMS 1 BIKLOSED SPACES  1 RAPES 1 BUT PASSAGENAYS		WINDOW NUMBER     DOOR NUMBER
R-2 C C C	MIN. EGRESS PASSAGE WIDTH OCCUPANCY LOAD (SECTION 1016.2) 44 "	LINE ABOVE
	ABREVATIONS:	CENTER LINE
A. HEIGHT CRITERIA  1. TABLE 503.  B. FLOOR AREA CRITERIA  TABLIAR AREA TABLE 503.  5'RRET PRONTAGE INCREASE  (SECTION 506.2)  IF = 100 INCREASED FRONTAGE  F = 200 FERIMITER LIN FT FRONTAGE  P = 460 TOTAL PERIMITER  W = 25 WIDTH OF PUBLIC WAY (MIN 20')  ALLOWABLE INCREASE  INCREASE (SECTION 506.3)  200% FOR MULTI 5'TORY BUILDING  WFR   3  ALCOWABLE AREA FER FLOOR  AA = AT (AT IFI/00) + (AT 15 /100)  C. ACTUAL FLOOR AREA  FIRST FLOOR  1434.1 50 FT  SECOND FLOOR 7434.1 50 FT  SECOND FLOOR 7434.1 50 FT	A.CT. ACOUSTIC TILE A.F.F. ABOVE FINISH FLOOR ASPH. ASPHALT BLK. BLOCK BLK'G BLOCKING C.H. CEILING HEIGHT C.J. CONTROL JOINTS CLG. CEILING CONC. CONCRETE CONT. CONTINUOUS C.T. CERAMIC TILE DIA. DIAMETER DN. DOWN DWG. DRAWING EL. ELEVATION ELEC. ELECTRICAL EXIST. EXISTING EXP. JT EXPANTION JOINT F.P. FIRE PROOF	GA. GAUGE GALV. GALVANIZED GL. GLASS GYP. BD. GYPSUM BOARD HB. HOSE BIBB HC. HANDICAPPED HM. HOLLOW METAL H.P. HIGH POINT HR. HOUR H.V.A.C HEATING VENTILATING AIR-CONDITIONING JT. JOINT L.P. LOW POINT MAX. MAXIMUM MIN. MINIMUM MIN. MINIMUM MIN. MINIMUM MTL. METAL MO. MASONRY OPENING N.I.C. NOT IN CONTRACT N.T.S. NOT TO SCALE GYPSUM BOARD REQ'ID REQUIRED ROOM ROOM ROOM ROOM ROOM ROOM ROOM ROO
	FIN. FINISHED FL. FLOOR	O.C. ON CENTER W WITH O.H. OPPOSITE HAND WD WOOD OPN'G OPENING & CENTER LINE

FIRE RESISTANCE RATING OF STRUCTURAL MEMBERS (SECTION 714.1);

114.1 REQUIREMENTS: THE FIRE RESISTANCE RATING OF STRUCTURAL MEMBERS AND

ASSEMBLIES SHALL NOT BE LESS THAN THE RATING FOR THE ASSEMBLIES SUPPORTED

1142 PROTECTION OF STRUCTURAL MEMBERS; COLUMNS, BEAMS OR OTHER STUCTURAL MEMBERS HAICH ARE REQUIRED TO HAVE A FIVE RESISTIVE RATING AND SUPPORT MORE THAN TWO FLOORS SHALL BE INDIVIDUALLY PROTECTED ON ALL SIDES FOR THE FILL LENSTH AND HEIGHT WITH MATERIALS HAVING THE REQUIRED FIRE RESISTANCE RATING. ALL OTHER STRUCTURAL MEMBERS SHALL BE PROTECTED BY INDIVIDUALENCASEMENTS, OR BY MEMBRANEOR CEILING PROTECTION.

REVISIONS
DATE DESCRIPTION
ISSUED FOR FERMIT

Douglas Cutter

Douglas Cutter

Architects AIA
221 Danbury Road, Wilton, CT 06897

Architects AIA
221 Danbury Road, Wilton, CT 06897

Architects AIA
221 Danbury Road, Wilton, CT 06897

Architects AIA
223 Danbury Road, Wilton, CT 06897

Architects AIA
224 Danbury Road, Wilton, CT 06897

Architects AIA
225 Danbury Road, Wilton, CT 06897


Architects AIA
226 Drawn By

Scale
1/4" = 1'-0"

T1

### AFFORDABLE 8-30G RESIDENTIAL **CLARK HOLDINGS LLC** BELGIAN BLOCK

2 HOLLYHOCK ROAD, WILTON, CT

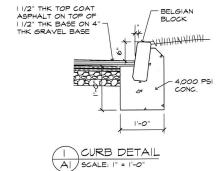

#### LEGEND

BUILDING - STRUCTURE NON-PERMEABLE SURFACE NEW NON-PERMEABLE SURFACE

EXIST. PERMEABLE SURFACE

NEW BELGIUM BLOCK WITH STONE DUST (PERMEABLE)





NEW SHRUBS (SEE PLANT LIST)

MAP 68 / LOT #30 CONFIRMED BY SURVEY MAP BY WAYNE ARCAMONE- SURVEYOR REG #15973

BASEMENT	2744 SF
FIRST FLOOR	4254 SF
SECOND FLOOR	4262 SF
THIRD FLOOR	3723 SF
TOTAL:	14983 SF

FLOOR AREA IS CALCULATED FROM INSIDE FACE OF EXTERIOR PERIMETER WALL AND INCLUDES ALL FLOOR SPACE WITHIN.

#### ZONING TABULATION (MINIMUM)

LOT MAP 68 / #30 AREA .48 ACS. / 21,173 SF

ZONED DE-5

FRONTAGE 150' MIN 104' EXIST APPROVED

SETBACKS FRONT

SIDE 50 17' APPRO SIDE (HOLLYHOCK RD)50' 24' APPR

LOT COVEAGE

BLDG. HEIGHT

BUILDING

SITE

ALLOWABLE EXISTING

TOP OF ROOT BALL SHALL BE LEVEL WITH FINISHED GRADE-

FORM SAUCER WITH 3" CONTINUOUS RIM -BACKFILL MIXTURE: 3:1 TOPSOIL ORGANIC HUMUS — BOTTOM LAYER OF
BACKFILL SHALL BE
LIGHTLY TAMPED AND
SETTED WITH WATER
PRIOR TO PLACEMENT
OF PLANT DEGRADABLE BURLAP SHALL BE REMOVED OR ROLLED UNDER BALL AFTER PLACEMENT OF PLANT

PROVIDE DRAINAGE IN PLANTING PIT AS NECESSARY

#### SHRUB PLANTING STAKE DETAIL

PLAN-	T LIS	Τ:		
SYMBO	aty.	BOTANICAL NAME	COMMON NAME	SIZE
AL	7	JUNIPERUS CHINENSIS 'ARMSTRONG'	ARMSTRONG JUNIPER	30"
JC	10	JUNIPERUS CHINENSIS PFITZER COMPACTUS	COMPACT PFITZER JUNIPER	18"

DRA	NING INDEX	
PAGE	DRAWING DESCRIPTION	
CS	COVER SHEET	
TI	TITLE PAGE	
Al	FOUNDATION PLAN	
A2	FIRST FLOOR PLAN	
A3	SECOND FLOOR PLAN	
A4	THIRD FLOOR PLAN	

	LATES
	DAT

	REVISIONS	Project	
DATE	DESCRIPTION	PROPOSED AFFORDABLE 8-30G RESIDENTIAL C	
			GS LLC
		2 HOLLY HOCK ROAD, WILTON, CT	
		Douglas Cutler	Ar
		bougids cutier	

# COVER SHEET / SITE PLAN

Architects A.I.A

1/4" = 1'-0"




,000 P51 ONC.	2 HOLL I IIC	CK KOAD, WILTON,	CI	
	DRIVEWAY DAVIS CORP.	EXIST CATCH BASIN CB-02 H-20 CAPACITY WITH GRATE RIM ELEVATION +33" B"-0" DIA. X 6"-0" DEEP REF. DETAIL	EXIST 6" DIA SCHEDULE 40 ROOF DRAIN LINE TO EXIST DRY WELL  -6" INVERT ELEVATION	2" //
+54"	70"		+6" -0"	-2
+60"	+36" +30" +30"	+24"	+1/2"	
			CLEANOUT TO GRADE WATERTIGHT SHUT-OFF	
+66"			WATERTIGHT SHUT-OFF VALVES	TELEPHONE POLE
	11 12	STONEWALL	WATER	SERVICE -0"
ACE	2	14	L7	DANBURY ROAD ROUTE 7
			+24"	KOOTE /
ST)	0	+42"		+6"
	## TO THE TOTAL	30-		65-00/ C-3
2 C-3	5	**************************************	51 Ad 25 00 0 0 0 0 0 0 0 0 0 0	ELECTRIC LINE
2744 SF	+54 +54 +54 +54 +54 +54 +54 +54 +54 +54	STORY OR AND THE STORY OF THE S		25:33/8
4254 SF 4262 SF	Z P 9 / set distributed	ATTION SHOOT WITH THE PARTY OF		0+61
3723 SF 14983 SF	+402	CROWN TO BUY	//////////////////////////////////////	
NSIDE FACE OF	10 +42	CROWN TO OI HOLD IN NAME OF THE OWNERS OF TH	/// WOOD FRAME////////////////////////////////////	FIRE HYDRANT
UDES ALL FLOOR	10 TOTAL E SPOTS SPOTS SPOTS E S	16   BX		
	A SANAGE	+34'	<u> </u>	5 C EXISTING STORM DRAIN
(MINIMUM)	+ 150' 11 88 W	CARDEN WITH		
	+42-	180., [1]		SIGNAGE BOLLARD LIGHTS
	12 +44	18 21-0"		⊙ +12"\ <del>-</del>
APPROVED	16-15/16"	21-0"		
100' 31' APPROVED	13	19		
50'   17' APPROVED	110	+32'		
50' 104'	14	20		
21% APPROVED 56.6% APPROVED	+46:	+30"		RAIN FOREST RETINION BASIN
	15 15 15 15	200 100	1 1 1 1 1 1 1 1 1 1 1 1 1 1 1 1 1 1 1 1	1 C-3
39' MAX./3 STYS. 33.9'	CROWN +48"	SUCR SRAW IN HITH HITH		OPERAN FOREST TO RAIN
		CROWN +36" (700 TO 100		32255 +6"
~~~	Current Hard To	# \ \ \ \ \ \ \ \ \ \ \ \ \ \ \ \ \ \ \	N 70°39'51" W 208 00'	
PRUNE TO REMOVE DEAD OR BROKEN BRANCHES		Į į		2" - 2"
MULCH 2" MIN. AWAY FROM	+60" +54" +48"	+42" +36" +30"	+24" +18" +12"	6" 0" -2" -2"
2"-3" SHREDDED HARDWOOD	BARK CITE DI ANI	NEW CATCH BASIN CB-01 H-20 CAPACITY WITH GRATE	HOLLYHOCK ROAD  EMIST DRY WELL DW-01 WITH CLEAN-OUT  "OLLY VE. OF DEED	
CUT & REMOVE BURLAP FROM	SITE PLAN	RIM ELEVATION +27" 8'-0' DIA, X 6'-0" DEEP REF. DETAIL	8'-0" DIA, X 6'-0" DEEP DRYWELL REF. DETAIL	6" DIA SCHEDULE 40 ROOF DRAIN LINE TO NEW DRY WELL
TOP 1/3 OF ROOT BALL, NON- DEGRADABLE BURLAP SHALL	66 41 = 1"-10"			-6" INVERT ELEVATION

#### AFFORDABLE 8-30G RESIDENTIAL

# CLARK HOLDINGS LLC

#### 2 HOLLYHOCK ROAD, WILTON, CT

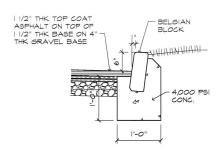



#### **LEGEND**



NEW NON-PERMEABLE SURFACE



NEW SHRUBS (SEE PLANT LIST)

MAP 68 / LOT #30 CONFIRMED BY SURVEY MAP BY WAYNE ARCAMONE— SURVEYOR

BASEMENT	2744 SF
FIRST FLOOR	4254 SF
SECOND FLOOR	4262 SF
THIRD FLOOR	3723 SF
TOTAL:	14983 SF

FLOOR AREA IS CALCULATED FROM INSIDE FACE OF EXTERIOR PERIMETER WALL AND INCLUDES ALL FLOOR

#### ZONING TABULATION (MINIMUM)

LOT MAP 68 / #30 AREA .48 ACS. / 21,173 SF ZONED DF-5

FRONTAGE 150' MIN 104' EXIST APPROVED

SETBACKS FRONT

100' 50'

SIDE SIDE (HOLLYHOCK RD)50' REAR 50'

LOT COVEAGE

BUILDING SITE

21% APPROVED 56.6% APPROVED

33.91

BLDG. HEIGHT

TOP OF ROOT BALL

FORM SAUCER WITH 3" CONTINUOUS RIM

BACKFILL MIXTURE: 3:1 TOPSOIL ORGANIC HUMUS -

ALLOWABLE EXISTING

PROVIDE DRAINAGE IN

## BOTTOM LAYER OF BACKFILL SHALL BE LIGHTLY TAMPED AND SETTED WITH WATER PRIOR TO PLACEMENT OF PLANT SHRUB PLANTING STAKE DETAIL

PLANT LIST:				
SYMBO	QTY.	BOTANICAL NAME	COMMON NAME	SIZE
AL	7	JUNIPERUS CHINENSIS 'ARMSTRONG'	ARMSTRONG JUNIPER	30"
JC	10	JUNIPERUS CHINENSIS PFITZER COMPACTUS	COMPACT PFITZER JUNIPER	18"

٦	DRA	NING INDEX	
-	PAGE	DRAWING DESCRIPTION	
	CS	COVER SHEET	
	TI	TITLE PAGE	
1	Al	FOUNDATION PLAN	
	A2	FIRST FLOOR PLAN	
_	A3	SECOND FLOOR PLAN	
	A4	THIRD FLOOR PLAN	

	LATEST F	REVISION: XX/XX/XX	
4		REVISIONS	Project
_	DATE	DESCRIPTION	PROPOSED AFFORDABLE 8-30G RESIDENTIAL CO
	12-2-20	BEE PLONATOR PLANTING AND ISSUED FOR PERMI	CLARK HOLDING
4			2 HOLLY HOCK ROAD, WILTON, CT
4			
			Douglas Cutler
			221 Danbury Road, Wilton, CT 06897


٦	Project
	PROPOSED AFFORDABLE 8-30G RESIDENTIAL CONVERSION FOR CLARK HOLDINGS LLC
1	2 HOLLY HOCK ROAD, WILTON, CT

(203) 761-956

# COVER SHEET / SITE PLAN

3/29/20 1/4" = 1'-0'



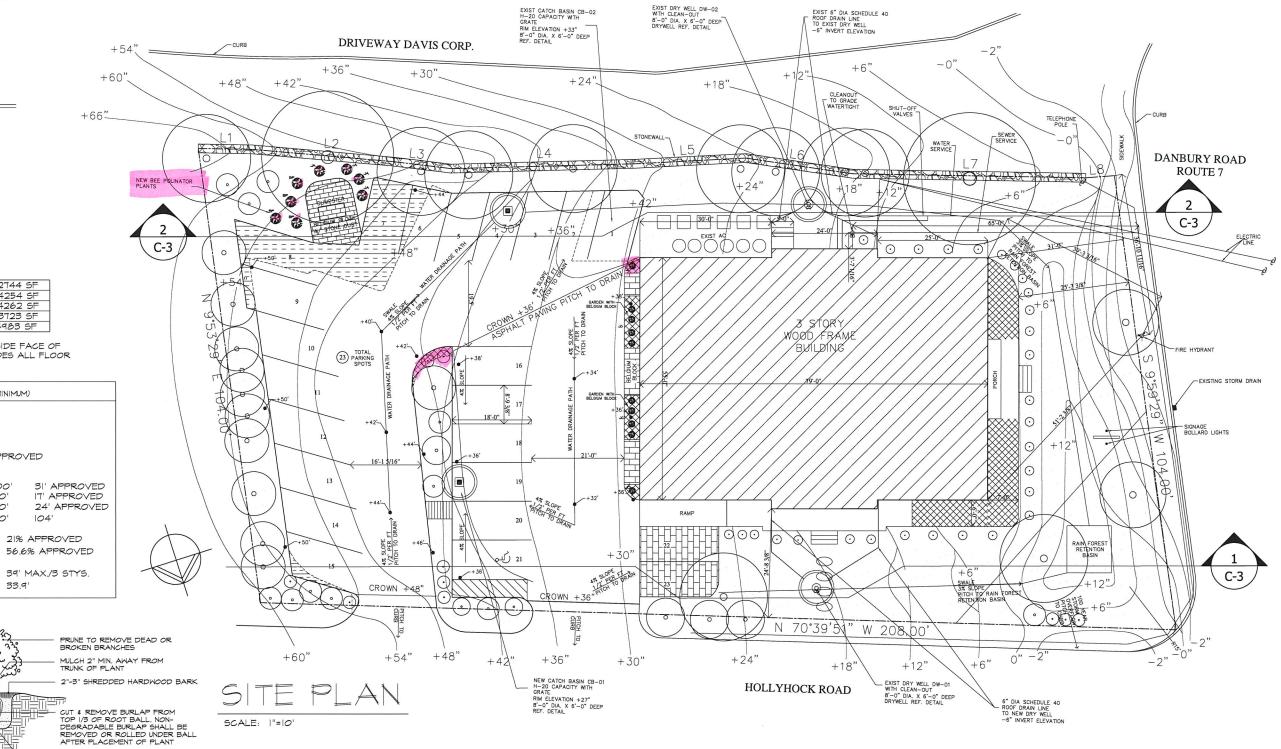



- 1. Second and Third floor windows added, denoted with white dot:
  - Six new windows.
  - Trim to match existing.
  - Faux grilles to match existing
- 2. Lower doors have been substituted for Egress purposes.
- 3. Lower terrace front door replaced with sliding doors
  - Framed in mahogany to match existing finishes
- 4. Two lower terrace windows replaced with sliding doors
  - Framed in mahogany to match existing finishes
- 5. Eliminate stairs and replace with terrace and railing
- 6. Add signage over door

Project
PROPOSED 8-30g AFFORDABLE RESIDENTIAL UNITS

# **CLARK HOLDINGS, LLC**

2 HOLLYHOCK ROAD, WILTON CT

Douglas Cutler Architect, AIA - Code Consultant

Gregory Clark Designer, Industrial Designer,

(203)761-9561

(203)515-1122

**Drawing Title** 

**Date Prepared** 

5./20/2020

# **ART HOUSE**

2 HOLLYHOCK ROAD, WILTON CT

Date Revised 11/10/2020 Drawing No.

GC -1



**FRONT** 



- 1. Second and Third floor windows added, denoted with white dot:
  - Six new windows.
  - Trim to match existing
  - Faux grilles to match existing
- 2. Ground level doors have been modified replacing lower wood panels with glass.
- 3. Two new custom windows added at ground level
  - Framed in mahogany to match existing finishes. Made by original manufacturer
- 4. New Belgium block borders added with terrace platforms and adjacent gardens outside garage doors

Project

PROPOSED 8-30g AFFORDABLE RESIDENTIAL UNITS

# **CLARK HOLDINGS, LLC**

2 HOLLYHOCK ROAD, WILTON CT

Douglas Cutler Architect, AIA - Code Consultant

Gregory Clark Designer, Industrial Designer, RISD

(203)761-9561

(203)515-1122

**Date Prepared** 5/20/2020

**Drawing Title** 

# **ART HOUSE**

2 HOLLYHOCK ROAD, WILTON CT

Drawing No.

GC -2

Date Revised



REAR



- 1. Second floor windows added, denoted with white dot:
  - One new window.
  - Trim to match existing.
- Faux grilles to match existing
- 2. First floor custom sliding window added denoted with white dot.
  - Framed in mahogany to match existing finishes
- 3. Shrubs added at foundation

Project	_
PROPOSED 8-30g AFFORDABLE RESIDENTIAL UNITS	

**CLARK HOLDINGS, LLC** 

2 HOLLYHOCK ROAD, WILTON CT

Douglas Cutler Architect, AIA - Code Consultant

(203)761-9561

Gregory Clark Designer, Industrial Designer, RISD

Drawing Title

**ART HOUSE** 

2 HOLLYHOCK ROAD, WILTON CT

**Date Prepared** 3/20/2020

(203)515-1122

**Date Revised** 11/10/2020

Drawing No.

GC -3



SOUTH



- **1.** Two Showroom Windows customized to receive Sliding System for Air Flow and Egress
- 2. Add Side Entrance roof support detail

PROPOSED 8-30g AFFORDABLE RESIDENTIAL UNITS

# **CLARK HOLDINGS, LLC**

2 HOLLYHOCK ROAD, WILTON CT

Douglas Cutler Architect, AIA - Code Consultant Gregory Clark Designer, Industrial Designer,

(203)761-9561 (203)515-1122 **Drawing Title** 

**Date Prepared** 

3/20/2020

# **ART HOUSE**


2 HOLLYHOCK ROAD, WILTON CT

Date Revised 11/10/2020 Drawing No.

GC-4



NORTH

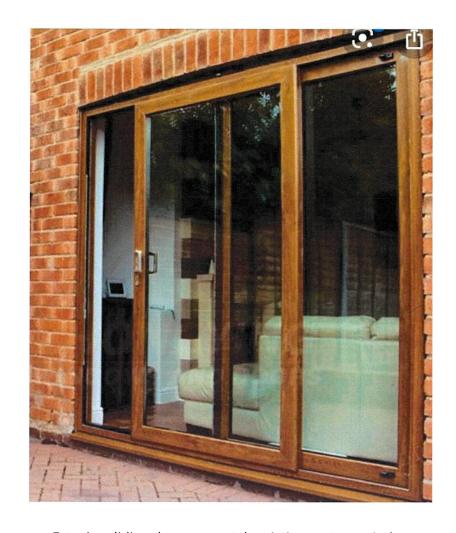

Exterior sliding doors to match existing custom windows



**Existing Exterior Finishes** 




Interior sliding doors to match existing custom woodwork in Mahogany

Project PROPOSED 8-30g AFFORDABLE RESIDENTIAL UNITS		Drawing Title	
CLARK HOLDINGS, LL	.C	ART	HOUSE
2 HOLLYHOCK ROAD, WILTON CT			/HOCK ROAD, WILTON CT
Douglas Cutler Architect, AIA - Code Consultant	(203)761-9561	Date Prepared 5./20/2020	Date Revised 11/10/2020
Gregory Clark Designer, Industrial Designer,	(203)515-1122	W	

GC -5

Drawing No.

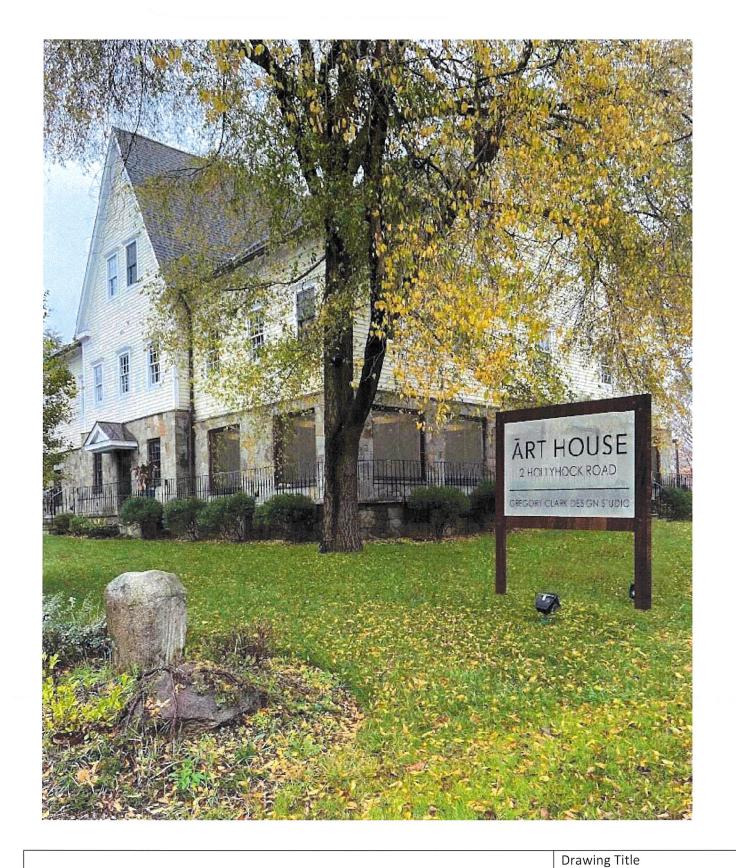



# PRELIMINARY SIGNAGE

PROPOSED 8-30g AFFORDABLE RESIDENTIAL UNITS

# **CLARK HOLDINGS, LLC**

2 HOLLYHOCK ROAD, WILTON CT

Douglas Cutler Architect, AIA - Code Consultant Gregory Clark Designer, Industrial Designer, (203)761-9561 (203)515-1122

Date Prepared


3/20/2020

# **ART HOUSE**

2 HOLLYHOCK ROAD, WILTON CT


Date Revised 11/10/2020 Drawing No.

GC-6

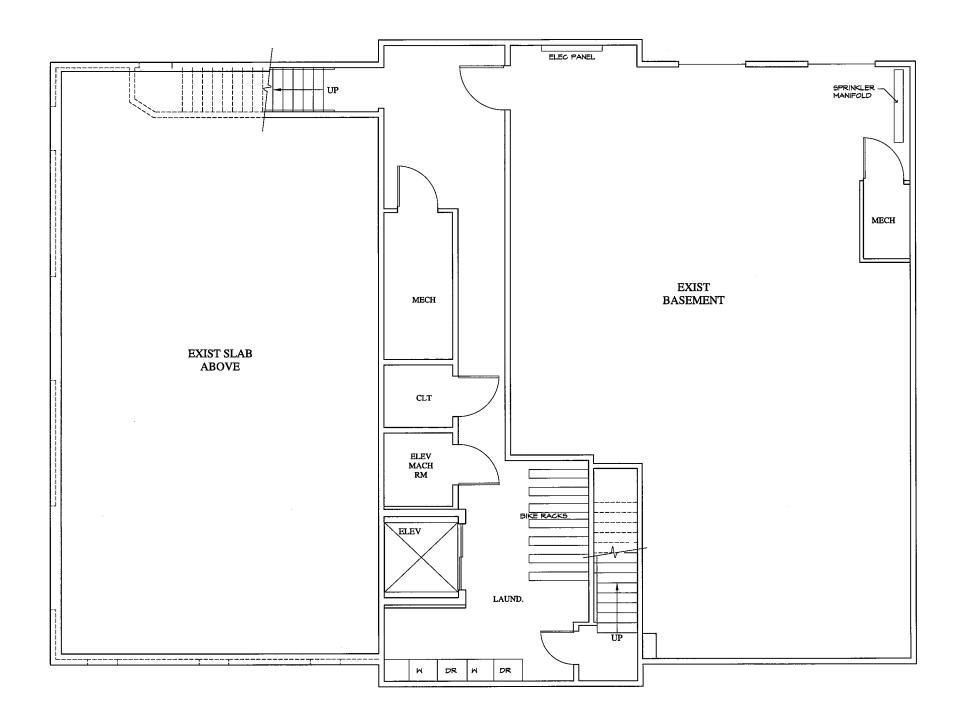

# EXIST BASEMNT PLAN SCALE: 3/16" = 1'-0"

LATEST RE	EVISION: XX/XX/XX			OT/17/03 DOUGLAS CUT	ILER ARCHITECT	
DATE	REVISIONS DESCRIPTION USSUED FOR PERMIT	Project PROPOSED AFFORDABLE 8-30G RESIDENTIAL CONVERSION FOR CLARK HOLDINGS LLC 2 HOLLY HOCK ROAD, WILTON, CT		EXIST BASEMENT PLAN		
		Douglos Cutler 221 Danbury Road, Wilton, CT 08897	Architects A.I.A. (203) 761-9561	Project No. Drawn By	Date Drawn Date Revised $3/29/20$ Scale $1/4$ " = $1-0$ "	

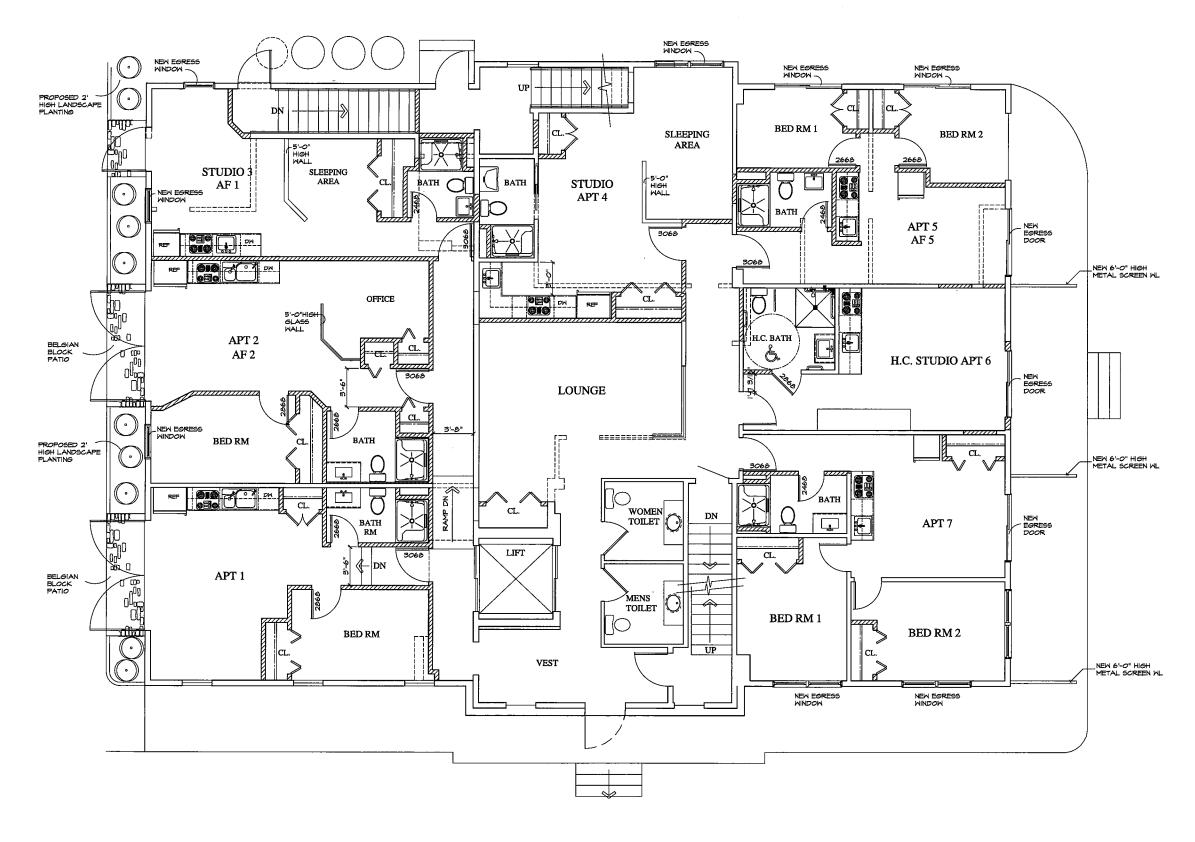

#### FIRST FLOOR PLAN

SCALE: 3/16" = 1'- 0"

LEGEND

EXISTING CONSTRUCTION TO BE REMAIN

NEW CONSTRUCTION

======= EXISTING CONSTRUCTION TO BE REMOVED

---- LINE OF ROOF ABOVE

■ 4 X 4 MIN. POST SIZE EXCEPT OTHERWISE NOTED

4-2 X 4 MD. POST

THESE PLANS AND/OR DRAWINGS MAY NOT BE USED WITHOUT THE EXPRESS PRIOR WRITTEN CONSENT OF DOUBLAS CUTLER ARCHITECT. THESE PLANS AND/OR DRAWINGS ARE THE SOLE EXCLUSIVE PROPERTY OF DOUBLAS CUTLER ARCHITECT. AND WANT-FOR DEPROPULATION OR USE HEREOF BY INDIVIDUAL OR MANUFACTURER IS STRICTLY PROHIBITED AND MAY SUBJECT THE USER TO CIVIL AND/OR CRIMINAL PENALTIES. OTHERS DOUBLAS CUTLER ARCHITECT.

REVISIONS

Project

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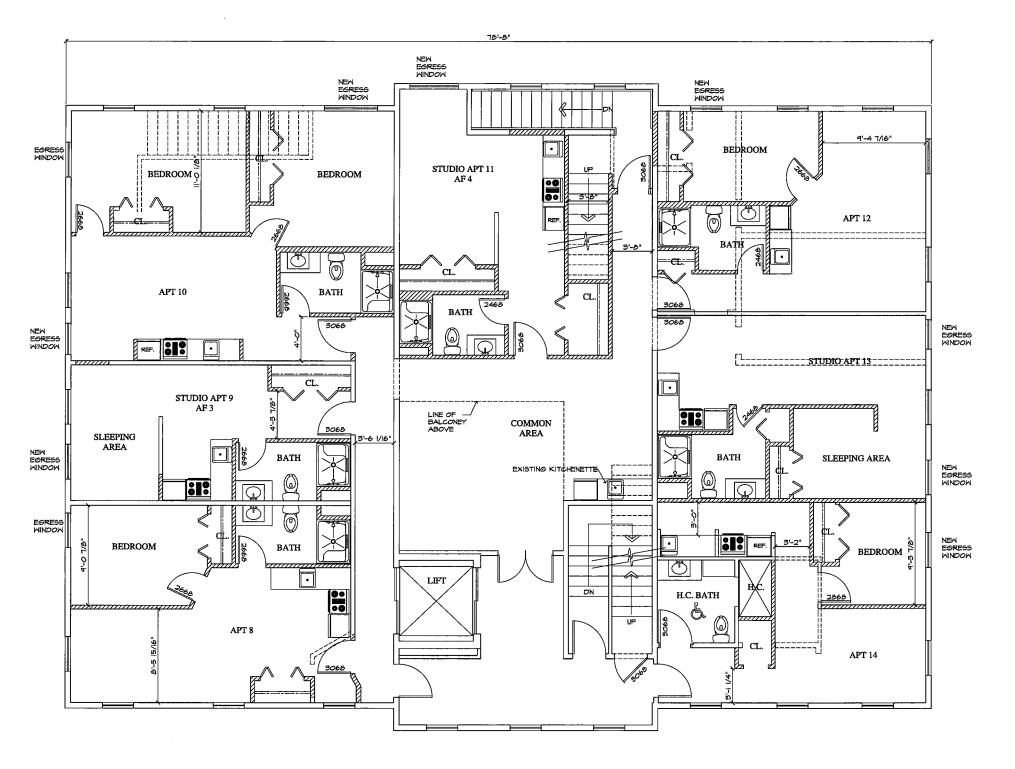
THESE PLANS AND/OR DRAWINGS MAY NOT BE USED WITHOUT THE EXPRESS PRIOR WRITTEN CONSENT OF DOUBLAS CUTLER ARCHITECT.

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REVISIONS Project	Drawing
DATE DESCRIPTION PROPOSED AFFORDABLE 8-30G RESIDENTIAL CONVERSION FOR	i i
GSUED FOR PERMIT CLARK HOLDINGS LLC	
2 HOLLY HOCK ROAD, WILTON, CT	
	Project
Douglas Cutler Archit	ects A.I.A.
- Joseph Grand	Drawn
221 Danbury Road, Wilton, CT 06897 (203)	761-9561

FIRST FLOOR PLAN

A2



## SECOND FLOOR PLAN SCALE: 1/4" = 1'-0"

# LEGEND EXISTING CONSTRUCTION TO BE REMAIN THE CONSTRUCTION EXISTING CONSTRUCTION TO BE REMOVED LINE OF ROOF ABOVE 4 X 4 MIN POST SIZE EXCEPT OTHERWISE IN

4 X 4 MIN. POST SIZE EXCEPT OTHERWISE NOTED 4- 2 X 4 MD. POST LATEST REVISION: XX/XX/XX

REVISIONS

DATE DESCRIPTION
ISSUED FOR PERMIT

Douglas Cutler

Douglas Cutler

Architects A.I.A.

Project No.
Drawn By


Project No.
Drawn By

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SECOND FLOOR PLAN

act No. Date Drawn Date Revised 3/24/2O on By Scale |/4" = |'-C"

A3

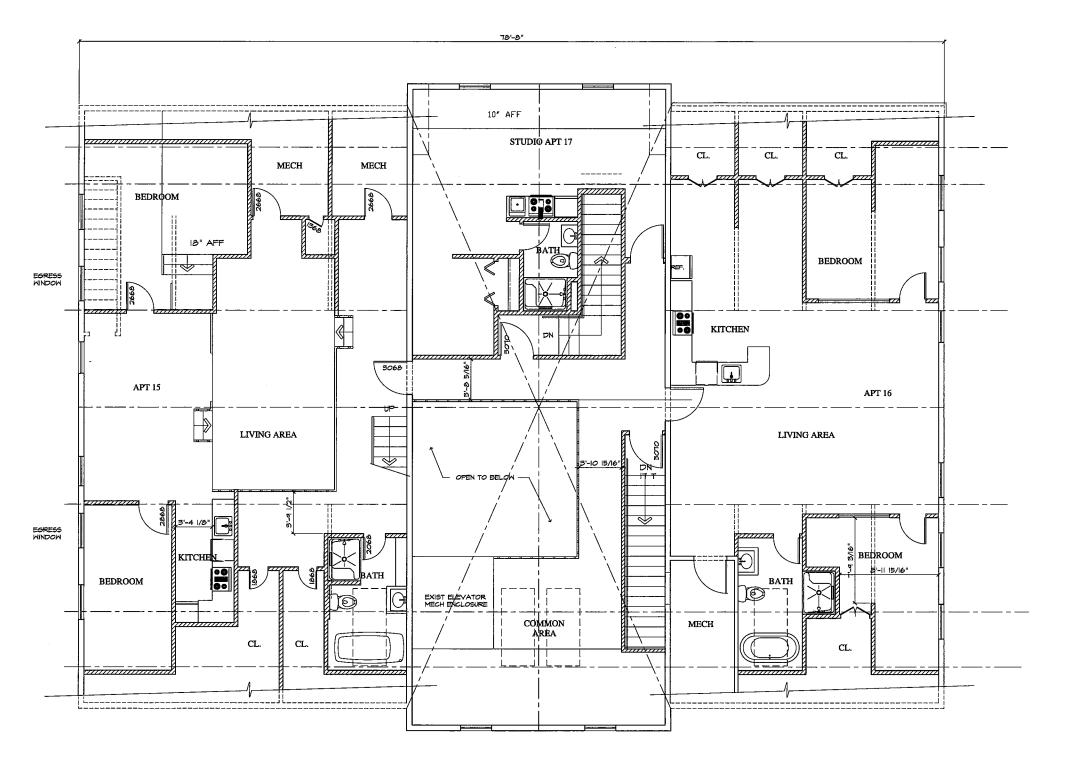

#### THIRD FLOOR PLAN

REVISIONS

SCALE: 3/16" = 1'- 0"

#### LEGEND

EXISTING CONSTRUCTION TO BE REMAIN

TITLE NEW CONSTRUCTION

\_\_\_\_\_ EXISTING CONSTRUCTION TO BE REMOVED

---- LINE OF ROOF ABOVE

4 X 4 MIN. POST SIZE EXCEPT OTHERWISE NOTED

4-2 × 4 WD. POST

#### LATEST REVISION: XX/XX/XX

#### THIRD FLOOR PLAN

THESE PLANS AND/OR DRAWINGS MAY NOT BE USED WITHOUT THE EXPRESS PRIOR WRITTEN CONSENT OF DOUBLAS CUILER ARCHITECT. THESE PLANS AND/OR DRAWINGS ARE THE SOLE EXCLUSIVE PROPERTY OF DOUBLAS CUILER ARCHITECT. ANY WANTHORIZED REPRODUCTION OR USE HERSOF BY INDIVIDUAL OR MANUFACTURES IS STRICTLY PROHIBITED AND MAY SUBJECT THE USER TO CIVIL AND/OR CRIMINAL PENALTIES, OT///I/OB DOUBLAS CUILER ARCHITECT.

A4

PROPOSED AFFORDABLE 8-30G RESIDENTIAL CONVERSION FOR CLARK HOLDINGS LLC
2 HOLLY HOCK ROAD, WILTON, CT

Project No. Date Drawn Date Revisec

THE APPLICANT understands that this application is to be considered complete only when all information and documents required by the Commission have been submitted and is responsible for the payment of all legal notices incurred.

THE UNDERSIGNED WARRANTS the truth of all statements contained herein and in all supporting documents according to the best of his or her knowledge and belief; and hereby grants visitation and inspection of the subject property as described herein.

Cong Clark	12/1/2020	gregoryclarkart@gmail.com	(203) 515- 1122
APPLICANT'S SIGNATURE	DATE	EMAIL ADDRESS	TELEPHONI
Cy Clark	12/1/2020	gregoryclarkart@gmail.com	(203) 515- 1122
OWNER'S SIGNATURE	DATE	EMAIL ADDRESS	TELEPHON

#### For Planning and Zoning Department Use Only:

Mandatory Referrals - Jurisdiction/Agend	ęy	
Village District Design Advisory Committee (VDDAC):	Yes	No
Architectural Review Board (ARB):	Yes	No
Western Connecticut Council of Governments (WestCOG):	Yes	No
South Norwalk Electric and Water Company (SNEW) Designated Public Watershed:	Yes	No
First Taxing District Water Department Designated Public Watershed:	Yes	No
State-Designated Aquifer Protection Area:	Yes	No
Adjoining Community Notification:	Yes	No

WILTON PLANNING AND ZONING COMMISSION	FORM B - ZONING DATA
Include the following data on the required Site D	evelopment Plan, as well.
2 Hollyhock Road, Wilton, CT 06897	.49
PROPERTY ADDRESS	LOT ACREAGE
DE-5	104'
ZONING DISTRICT	LOT FRONTAGE

		*************************************		
	PER ZONING REGS (MAX OR MIN ALLOWED)	EXISTING	PROPOSED	TOTAL
GROSS FLOOR AREA [SF]	N/A	13,900	1083	14,983
BUILDING FOOTPRINT [SF]	N/A	4,482	0	4482
BUILDING COVERAGE [SF/%] (round up)	N/A	21%	0	21%
BUILDING HEIGHT [FT - Story]	N/A	33.9′	0	33.9′
FLOOR AREA RATIO (F.A.R.)	N/A	65.65	5.11	70.76
PARKING SPACES (round up)	N/A	19	4	23
LOADING SPACES	N/A	1	0	1
SITE COVERAGE [SF/%]	N/A	56%	0	56.6%

#### OFF-STREET PARKING AND LOADING CALCULATIONS

Please provide the specific calculation used to determine the minimum required off-street parking and loading spaces pursuant to the Zoning Regulations.

PARKING CALCULATION (Use separate page, if necessary)

Parking Study Provided

**LOADING CALCULATION** (Use separate page, if necessary)

Parking Study Provided

#### PLAN OF CONSERVATION AND DEVELOPMENT

Please indicate on separate page how this proposal complies with the Plan of Conservation and Development.

THE UNDERSIGNED WARRANTS the truth of all statements contained herein:

APPLICANT'S SIGNATURE

DATE

#### Clark Holdings, LLC

#### **Application for Special Permit**

Premises: 2 Hollyhock Road (Assessor's Map # 68 – Lot 30

#### Statement of Compliance with Plan of Conservation and Development

The property is .49 acres of landed located in a DE5 Zone directly on Route 7. Clark Holdings, LLC proposes to convert the multi office use on the above — referenced Premises into a multi family building that will contain (17) units pursuant to Section 8-30g of the Connecticut General Statues. This proposal is compatible with the Wilton 2019 Town Plan of Conservation and Development — adopted on September 23, 2019 and effective October 1, 2019 (the "Town Plan"). The Town Plan states the following:

"A Wilton where new housing typologies and mixed-use designs emerge through organic means to provide desired and versatile living, working, shopping, and entertaining opportunities and experiences." "Continue to increase housing options to benefit the shared interests of the Town's residential and commercial communities"

"A Wilton where the post-war, automobile-centric suburban zoning model was rethought and revamped for the new millennium."

"A Wilton that is an incubator of land-use ideas that attract residents, businesses and investors for their innovation and efficacy."


"A Wilton that is the model for Fairfield County and Connecticut in the 21st century."

"Danbury Road is the central artery of the community. A regional employment hub, Danbury Road is home to major employers such as ASML and Tauk. Over the next ten years, the Town seeks to develop the corridor with a diverse mix of uses with the highest intensity uses in the southern portion of the corridor and more rural patterns north of Cannondale."

The construction of the additional apartments in this section of Town will contribute to vitality of this area, supporting local restaurants and other services, and provide potential "non car users" an opportunity to commute to work by walking to nearby companies, including ASML across the street and the businesses at the neighboring corporate park, 64 Danbury Road.

#### **Project Narrative Presented to the ARB:**

2 Hollyhock Road has functioned as a multi use office building, furniture production studio, and furniture gallery for Gregory Clark Collection since receiving its CO in March of 2006. Due to a shrinking office market in recent years, with the property consistently being "under-Leased", and a change in the home interior design market in Fairfield County the highest and best use of the property going forward is to convert it to residential units. Our proposal is for the conversion of the building into 17 apartment units, pursuant to Section 8-30g of the Connecticut General Statutes, consisting of (6) Studios, (6) one bedroom apartments, and (5) two bedroom apartments. Minimal change will be made to the exterior with the exception of adding windows and customizing some windows to offer egress, additional light, and or air flow. Minor changes will be made to the site including, beautification of landscaping, addition of some green space, and addition of 4 parking spaces through minor alterations to the current parking configuration. The name of the building will be ART HOUSE, conceived with smart efficient design, artisan level finishes, and natural materials consistent with the current construction and standards of the building.

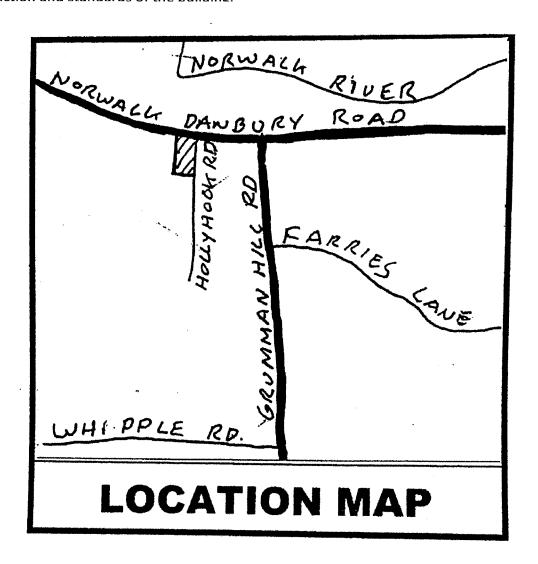

#### **List of Project Professionals**

Gregory Clark Collection Interior/Exterior Design, General Contractor 2 Hollyhock Road Wilton, CT 06987 (203) 515-1122

Architectural Plans & Code Consultant Code/Engineering/Architectural Design Douglas Cutler Architects A.I.A. 221 Danbury Road, Wilton. CT 06897 (203)761-9561

P.W.Scott Engineering and Architecture, P.C. Traffic Study & Parking Study 3871 Danbury Road Brewster, NY 10509 (845) 278-2110

Jim Murphy Gregory & Adams, P. C. Legal Counsel 190 Old Ridgefeild Road, Wilton, CT 06897 (203) 762-9000

Wayne Arcamone, Land Surveyors 4 Taft Street, Norwalk, CT 06854 (203) 866-2058

David Seymour, P.E. PMB#350
Original Engineer
1771 Post Road East, Westport CT 06880
(203) 259-8911

Atlantic Engineering 525 John Street, Bridgeport CT, 06604 (203) 336-4422

#### LEGAL TITLE SERVICES, LLC

Serving Connecticut
100 Tunxis Hill Road
Fairfield, CT 06825

Telephone: 203-333-1511 Facsimile: 203-366-6900

PROPERTY ADDRESS: 2 Hollyhock Road Wilton, CT

DATE:

October 9, 2019

#### **CERTIFICATE OF TITLE**

The undersigned hereby certifies that after an examination of the land records, as indexed, of the City/Town in which the land and appurtenances described in Schedule A are located, the undersigned is of the opinion that title in FEE SIMPLE is vested in Clark Holdings, LLC subject only to those matters appearing on Schedule B hereof.

This Certificate of Title is issued to **Jackson Law Group CT**, **LLC** and is not assignable.

Certified to the 7th day of October, 2019 at 8:00 a.m.

LEGAL TITLE SERVICES, LLC

JA
Ву:
 duly authorized

# 2 Hollyhock Road Wilton, CT

# TRAFFIC REPORT

Prepared by:

P.W. Scott Engineering and Architecture, P.C. 3871 Danbury Road Brewster, NY 10509 Date: April 9, 2020

#### **Traffic Study**

Project:

2 Hollyhock Road

Conversion from an Office building to 8-30g Apartment Building.

#### Scope

The following is an analysis of the traffic impacts resulting from the conversion of an office building use to that of an apartment building based upon the ITE Manual and the following building occupancies.

Assumptions: Existing Building Occupancies based upon 2020 rent rolls.

Apartments proposed shall remain rental units

I) Existing: Commercial Office spaces: 9

Total Occupied square footage; First Floor: 2850 + 900 = 3750 sq. ft. Upper Floor: 4500 sf

ITE Generation: LUC, (land use code): 712 Small Office Building:

Peak PM: 2.45 trips per 1000 GFA

II) Proposed Use: 17 Apartments of the following distribution

Studio:

6 units

1 Bedroom:

6 units

2 Bedroom:

5 units

Total square footage:

Gross: 4500 sf first

Includes the proposed lounge & common bathrooms

Gross: 4500 sf upper

ITE Generation: LUC: 220 Multi-family: low rise: (2 story garden apartments)

A description of the appropriate apartment LUC category is provided in the appendix.

Peak PM: 0.56 trips per dwelling unit

The data above is based upon double occupancy for studio and 1 bedroom with an additional occupant within the second bedroom considered a non-driver. Since the sidewalk facilities along Route 7 are limited it is assumed that 100% of the occupancy entry and exit is by a motor vehicle. Since the proposed 8-30G project is close to the prime business sites in the Route 7 corridor, ASML and The Wilton Corporate Park, some occupancy commuting may be as a pedestrian. The study takes the conservative approach considering weather, sidewalk, and Route 7 pedestrian crossing limitations.

Refer to the attached excel spread sheet for the traffic generation at an hourly interval noted.

#### **Findings**

Trip generation:

Existing use: 9 offices: 8250 sf

LUC: 712

PM Peak: 25.2 trips Daily total: 78.3 trips

Proposed use: 17 apartment units

LUC: 220

PM Peak: 9.5 trips Daily total: 52.6 trips

The change in use reduces the peak trip generation count from the subject site by 62%.

Occupancies along Hollyhock Road consist of Commercial Office, Single family and Mixed Occupancy, (commercial on the first floor, apartments above). A chart is available for the adjacent uses, yet there is no impact on the traffic along Hollyhock Road by this change in use, since there is a net reduction in traffic generation by the building use conversion. In addition, since the predominant Commercial use along Hollyhock Road is commercial office, the peak traffic generation rate of the neighboring properties is not in time sequence with the proposed Apartments. A review of the charts attached indicates that the commercial use peak traffic generation rate lags after the apartments peak generation rate for both the AM and PM peaks.

#### Traffic Impacts on Route 7.

Referencing a 2010 Route 7 Transportation and Land Use Study(SWRPA) which included an ADT site north at Grumman Hill Road intersection, the 8:00 peak is 2100 trips, predominantly south bound and the PM Peak at 5:30 is 2000 trips, exceeding the site generated traffic substantially. The Level of Service (LOS) analysis completed at the Grumman Hill Intersection Traffic Light was an AM value of C and a PM value of B. The inclusion of the light assists in the traffic movement at the Hollyhock Road intersection.

In addition, improvements as noted in the CTDOT Preliminary Design Report 102-35, extending to the Hollyhock intersection, consist of the inclusion of dedicated right and left turning lanes which should improve the LOS levels noted above for the Hollyhock intersection.

#### **Conclusion:**

The conversion of the existing Commercial Office Building to Apartments will not negatively impact the traffic circulation along Hollyhock Road and Route 7 corridor.

Respectfully Submitted:

Peder W. Scott, P.E., R.A. President

#### **Attachments**

Existing Occupancies- Offices: Hourly traffic Generation Proposed Occupancy-Apartments: Hourly traffic Generation Town of Wilton Tax Map; Hollyhock Road Existing Rent Roll-Office Spaces ITE- Description of Land Use Codes for apartments Route 7 Map with location relative to other Uses

#### **EXISTING OCCUPANCY (9) OFFICE SPACES**

# Hourly Distribution of Entering and Exiting Vehicle Trips by Land Use

Source: ITE Trip Generation Manual, 10th Edition

PERCENT OF 24 HOUR TRAFFIC Land Use Code

Land Use Small Office Building
Setting General Suburban
Time Period Weekday

Time Period Weekday
Trip Type Vehicle
# Data Sites 18

GROSS FLOOR AREA 8250 TOTAL LUC GENERATOR UNIT

PM PEAK 2.45 1000 GFA 20.2 TRIPS

712

DAILEY 78.3 1000 GFA

	% of 24-H	our Traffic	TRIP COUNT	٦	TOTAL TRIP COUNT
Time	Entering	Exiting	Entering	Exiting	
12-1 AM	0	0	0.0	0.0	0.0
1-2 AM	0	0	0.0	0.0	0.0
2-3 AM	0	0	0.0	0.0	0.0
3-4 AM	0	0	0.0	0.0	0.0
4-5 AM	0	0	0.0	0.0	0.0
5-6 AM	0	0	0.0	0.0	0.0
6-7 AM	0	0	0.0	0.0	0.0
7-8 AM	10.9	0.5	8.5	0.4	8.9
8-9 AM	12.8	3.7	10.0	2.9	12.9
9-10 AM	10.0	6.3	7.8	4.9	12.8
10-11 AM	9.0	6.0	7.1	4.7	11.8
11-12 PM	8.1	11.9	6.3	9.3	15.7
12-1 PM	9.5	11.6	7.4	9.1	16.5
1-2 PM	10.7	6.7	8.4	5.2	13.6
2-3 PM	10.9	12.3	8.5	9.6	18.2
3-4 PM	9.0	9.5	7.1	7.4	14.5
4-5 PM	6.3	7.7	4.9	6.0	11.0
5-6 PM	2.8	23.0	2.2	18.0	20.2
6-7 PM	0	0.7	0.0	0.5	0.5
7-8 PM	0	0	0.0	0.0	0.0
8-9 PM	0	0	0.0	0.0	0.0
9-10 PM	0	0	0.0	0.0	0.0
10-11 PM	0	0	0.0	0.0	0.0
11-12 AM	0	0	0.0	0.0	0.0

#### PROPOSED OCCUPANY - (17) 8-30G APARTMENTS

#### Hourly Distribution of Entering and Exiting Vehicle Trips by Land Use

Source: ITE Trip Generation Manual, 10th Edition


Land Use Code		220				
Land Use	N	Aultifamily Housi	ng (Low-Rise)			
Setting	General	Suburban				
Time Period	Wee	ekday				
Trip Type	Vehicle					
# Data Sites		9				
DWELLING UNITS	17	TOTAL				
LUC GENERATOR		UNITS				
PM PEAK	0.56	DW UNIT	9.5 TRIP	S		
DAILEY	52.6	DW UNIT				
	% of 24-H	our Traffic	TRIP COUN	IT TO	TAL TRIP COUNT	
Time	Entering	Exiting	Entering E	xiting		
12-1 AM	0.7	0.3	0.4	0.2	0.5	
1-2 AM	0.4	0.1	0.2	0.1	0.3	
2-3 AM	0.3	0.3	0.2	0.2	0.3	
3-4 AM	0.3	0.4	0.2	0.2	0.4	
4-5 AM	0.4	1.0	0.2	0.5	0.7	
5-6 AM	0.1	2.6	0.1	1.4	1.4	
6-7 AM	1.1	5.8	0.6	3.1	3.6	
7-8 AM	2.6	12.9	1.4	6.8	8.2	
8-9 AM	4.0	9.1	2.1	4.8	6.9	
9-10 AM	3.9	7.2	2.1	3.8	5.8	
10-11 AM	3.9	4.7	2.1	2.5	4.5	
11-12 PM	4.9	5.5	2.6	2.9	5.5	
12-1 PM	5.6	5.4	2.9	2.8	5.8	
1-2 PM	4.8	4.9	2.5	2.6	5.1	
2-3 PM	5.9	6.0	3.1	3.2	6.3	
3-4 PM	8.3	5.2	4.4	2.7	7.1	
4-5 PM	10.0	5.1	5.3	2.7	7.9	
5-6 PM	11.4	6.7	6.0	3.5	9.5	
6-7 PM	9.5	6.3	5.0	3.3	8.3	
7-8 PM	7.1	4.3	3.7	2.3	6.0	
8-9 PM	5.7	3.5	3.0	1.8	4.8	
9-10 PM	4.7	1.4	2.5	0.7	3.2	
10-11 PM	2.9	1.0	1.5	0.5	2.1	
11-12 AM	1.5	0.4	0.8	0.2	1.0	

# **Town of Wilton**

4/8/2020

Geographic Information System (GIS)



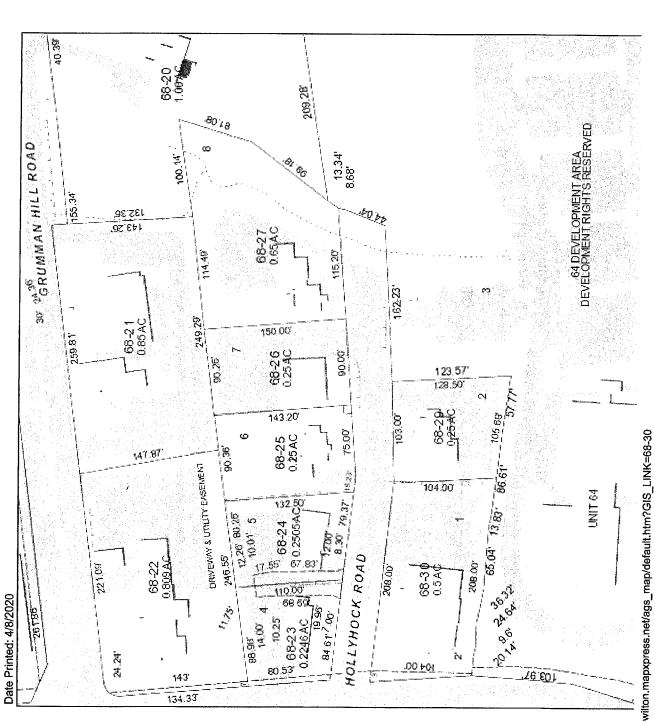


Rent Roll: Current Office Mode	el					
				Renewal	Tenant	Net Rental
Tenant	Lease Type	Start	End	Options	Since	Area
Sage/Catalytic Inc.	Gross+Utilities	6/1/10	5/31/20	1x5	6/1/10	1,375
Cosemetologist	Gross	7/20/19	7/19/25	1x5	10/1/19	009
Susan Bauerfeld, PHD	Gross	7/1/18	3/31/21	1x2	7/1/18	009
Euro Engineer	Gross	3/1/20	2/28/21		8/1/19	009
Vacant 2nd Floor Cathedral Center Suite	Gross+Utilities					1,645
Pinyan Capital	Gross	5/1/18	4/31/21	1x3	5/1/18	380
Judith Woolf Acupuncture	Gross	9/1/17	8/31/20	2x3	9/1/17	650
Lockwood Capital	Gross	8/1/17	10/24/19	1x1	8/1/17	200
Claire Arcamone - Healing Touch	Gross	10/1/17	10/1/19	1x2	10/1/17	009
Vacant -South Shop/Studio 1st Floor	Gross					006
Creative Planning Inc	Gross	10/1/19	10/1/20	1x1	10/1/19	250
Gregory Clark Collection Basement	Gross	3/1/06	3/1/24	1x5	3/1/06	2,650
Gregory Clark Collection East Wing Loft	Gross	3/1/06	3/1/24	1x5	3/1/06	1,650
Gregory Clark Collection Rear Shop/Studio	Gross	3/1/06	3/1/24	1x5	3/1/06	006
Coldwell Banker Real Estate	Gross	2/1/19	1/30/20	1x2	2/1/19	550

Table 5 ITE Descriptions of Land Use Codes (LUC)

LUC	Name	Description
220	Apartment	Apartments are rental dwelling units located within the same building with at least three other dwelling units, for example, quadraplexes and all types of apartment buildings. The studies included in this land use did not identify whether the apartments were low-rise, mid-rise, or high-rise. Low-rise apartment (Land Use 221), high-rise apartment (Land Use 222) and mid-rise apartment (Land Use 223) are related uses.
221	Low-Rise Apartment	Low-rise apartments (rental dwelling units) are units located in rental buildings that have one or two levels (floors), such as garden apartments. Apartment (Land Use 220), high-rise apartment (Land Use 222) and mid-rise apartment (Land Use 223) are related uses.
222	High-Rise Apartment	High-rise apartments (rental dwelling units) are units located in rental buildings that have more than 10 levels (floors) and most likely have one or more elevators. Apartment (Land Use 220), low-rise apartment (Land Use 221) and mid-rise apartment (Land Use 223) are related uses.
223	Mid-Rise Apartment	Mid-rise apartments are apartments (rental dwelling units) in rental buildings that have between three and 10 levels (floors). Apartment (Land Use 220), low-rise apartment (Land Use 221) and high-rise apartment (Land Use 222) are related uses.
230	Residential Condominium	Residential condominiums/townhouses are defined as ownership units that have at least one other owned unit within the same building structure. Both condominiums and townhouses are included in this land use. The studies in this land use did not identify whether the condominiums/townhouses were low-rise or high-rise. Low-rise residential condominium/townhouse (Land Use 231), high-rise residential condominium/townhouse (Land Use 232) and luxury condominium/townhouse (Land Use 233) are related uses.
231	Low-Rise Residential Condominium	Low-rise residential condominiums/townhouses are units located in buildings that have one or two levels (floors). Both condominiums and townhouses are included in this land use. Residential condominium/townhouse (Land Use 230), high-rise residential condominium/townhouse (Land Use 232) and luxury condominium/townhouse (Land Use 233) are related land uses.
232	Condominium	High-rise residential condominiums/townhouses are units located in buildings that have three or more levels (floors). Both condominiums and townhouses are included in this land use. Residential condominium/townhouse (Land Use 230), low-rise residential condominium/ townhouse (Land Use 231) and luxury condominium/townhouse (Land Use 233) are related land uses.

The differences in travel impacts between apartments and condominiums are less clear. "Ownership" may be a proxy for higher income. Travel behavior research has established a positive association with income, specifically related to higher rates of auto ownership (Pucher & Renne, 2003; Giuliano & Dargay, 2006; Blumenberg &

# Gogle Maps Little Pub Wilton

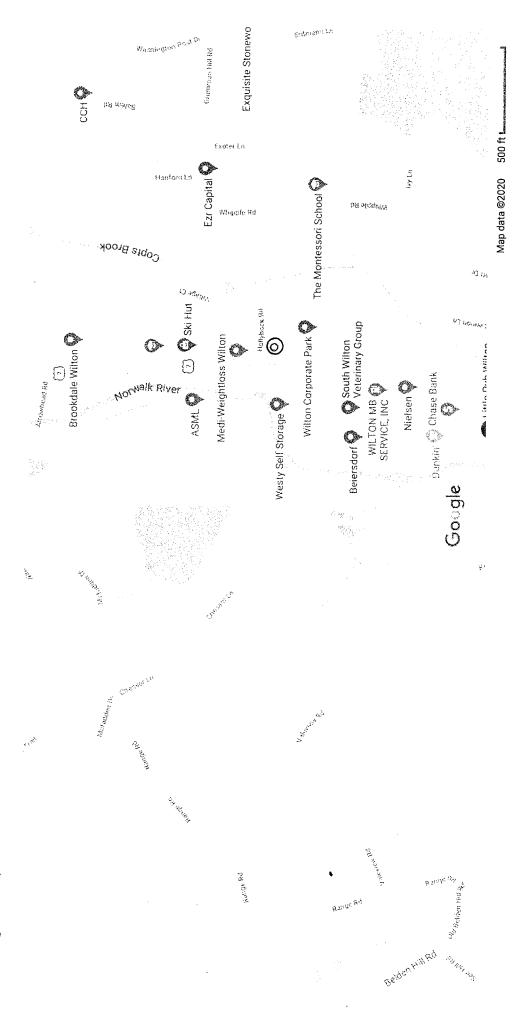

# 2 Hollyhock Road Wilton, CT

# **PARKING STUDY**

Prepared by:

P.W. Scott Engineering and Architecture, P.C. 3871 Danbury Road Brewster, NY 10509 Date: April 29, 2020

#### **Parking Study**

**Project:** 

2 Hollyhock Road

Conversion from an Office Building to 8-30g Apartment Building.

#### **Scope**

The following is an analysis of the parking requirements resulting from the conversion of an office building use to that of an apartment building based upon the Town of Wilton Regulations with a comparison to the ITE Parking Generation Manual, 5<sup>th</sup> edition. The ITE manual provides parking rates for various land use types (Residential, Retail, etc) in various settings (Suburban, dense urban and city center core, etc.) The ITE data also includes an Affordable housing component which shall be discussed in the following report.

The project as submitted consists of 17 apartments with studios, one- and two-bedroom units as outlined below of which 30% are affordable, made up of 15% (3 units) at 85% market rate and 15% (2 units) at 60% market rate.

	<del></del>	1	
	Affordable Housing		
Apartment	(5 Units)	Floor	Туре
1		1st	1 -Bed
2		1st	1 -Bed
3	AF1	1st	1 -Bed
4	AF3	1st	Studio
5		1st	2-Bed
6	AF4	1st	Studio
7		1st	2-Bed
8		2nd	1 -Bed
9		2nd	Studio
10	AF5	2nd	2-Bed
11		2nd	Studio
12	AF2	2nd	1 -Bed
13		2nd	Studio
14 Handicap		2nd	1 -Bed
15		Loft	2-Bed
16		Loft	2-Bed
17		Loft	Studio

Based upon the site plan prepared, the project proposes 23 parking spaces including one handicapped space which is included in this analysis, refer to attachment Figure 1.0.

#### Methodologies

Parking requirements for various land uses are typically determined based upon the municipality Zoning Regulations. However, since the project is considered unique in nature due to the following factors, the parking regulations for the project can be different than what is required for a typical residential use:

- The relatively small size of the units
- Affordability housing designation classification for a portion of the units.
- Proximity of the units to the main commercial corridor of the municipality.

The above factor could potentially result in reduced parking demand for the proposed project. Hence to determine the required parking demand for this unique project, this analysis evaluates the forecast parking demand of the project utilizing the following various methodologies and sources.

- Parking required based on the Town of Wilton Parking Regulations.
- Parking required based upon the Institute of Transportation Engineers (ITE) Parking Generation Manual 5<sup>th</sup> Edition (January 2019);
- Parking required based upon similar projects submitted to the Town of Wilton

#### I) Municipal Zoning Regulations

Based upon the Town of Wilton zoning regulations, the following is the parking requirements for multi-family dwelling.

Parking required per Town of Wilton Zoning				
Studio	1.5/unit			
One-bedroom	2/unit			
Two bedroom	2/unit			
Visitor Parking	1 space per 2 units			

Project Parking Capacity required per Town of Wilton Zoning						
			Parking	Total		
Land Use	Quantity	Units	Required	Parking		
Studio	6	dwelling units	1.5	9	spaces	
One-bedroom	6	dwelling units	2	12	spaces	
Two bedroom	5	dwelling units	2	10	spaces	
Visitor Parking	11	1&2 bedroom	0.5	5.5	spaces	
			Total req'd	36.5	spaces	
			Round-up	37	spaces	
		Parking Provide	ed:	23	spaces	
		Compliance to	regulations	-14	spaces	
		Percentage of r	eq'd parking	62.16%	percentage	

#### II) Parking required based on the ITE Parking Generation Manual

The Institute of Transportation Engineers (ITE) Parking Generation Manual is a widely accepted source for the determination of parking demand. The Manual contains parking requirements and rates for various land uses based upon empirical and recorded data from existing sites. The most recently updated Manual consists of an updated data base reflecting the impacts of rider sharing companies, trends in vehicular use by younger adults and other factors which effect parking demand.

The fact is that the municipal codes adopted by most communities reflect a general land use in which one regulation fits all residential land uses while the ITE Manual creates numerous categories which reflect demand based upon unit densities, locations and the affordability index. The ITE also breaks down the parking requirements for weekday, Saturday and Sunday conditions. With this project, in which the predominant land uses on Hollyhock Road are commercial, the weekend parking requirements do not govern the capacity of the project due to street side parking opportunities.

The ITE Manual has developed parking requirements based upon either bedroom count or unit count. With a project which includes 2- bedroom units and the demographics of the area in which each unit can house couples with several vehicles, the unit count analysis is more accurate than that based upon bedroom count.

For the use category of Low Rise housing (category 220) for weekday parking within an Urban/Suburban area, for the peak demand period, the parking demand is based upon an equation: P-1.34(x) - 8.06 in which x is the number of units.

The affordable housing analysis completed by the ITE Parking Generation Manual includes all multi-family housing that is rented at below market rate to households that include at least one employed member. The eligibility to live in an affordable unit is based upon housing income and/or the resident's age. Most of the studies completed by ITE consisted of between 75% to 100% affordable with units, recorded at sites in the general urban/suburban setting.

The affordability index for the proposed units in the Wilton area must be reviewed based upon the demographics and the respective income ranges to that of vehicle ownership. The occupant income levels for the "85% of market Affordable units" will not impact the number of vehicles owned, and thus these units are analyzed under the ITE Low-Rise housing category. The occupant income level of the "65% of market Affordable units" would have a significant impact on vehicular ownership and are therefore analyzed under the ITE Affordable category.

Based upon 5th Edition ITE Manual-Affordable Housing required parking is;

Weekend:

0.99 spaces/dwelling unit

Saturday:

0.79 spaces/dwelling unit

Sunday:

0.96 spaces/dwelling unit

An analysis combining the (15) units of Low-Rise Housing category and the (2)-65% percentile market rate Affordable category for the weekday peak is tabulated below based upon the ITE manual. The handicapped space allocation is assumed to be constant for the two categories of use.

Project Parking Capacity Planned to be provided per ITE Manual						
weekday: 11:00 pm to 6:00 am						
			Parking	Total		
Land Use	Quantity	Units	Required	Parking		
Low Rise			see			
units	15	dwelling units	equation	12.05	spaces	
Affordable	2	dwelling units	0.99	1.98	spaces	
	· · · · · · · · · · · · · · · · · · ·					
Visitor						
Parking	11	1&2 bedroom	0.5	5.5	spaces	
•						
			Total reg'd	19.53	spaces	
			Round-up	20	spaces	
		Parking Provided:		23	spaces	
		Compliance to				
		regulations		3	spaces	
		Percentage of reg'd				
		parking		115.00%	percentage	

The above analysis is based upon the 85% percentile of prediction, refer to the attached ITE Category Data Sheet. Based upon the ITE analysis completed, the project has proposed adequate parking for the intended Apartment use.

#### III) Comparison to similar projects

The standard for the review and approval of projects is based upon the premise that each project is reviewed equally relative to the zoning codes of the municipality. Accordingly, precedents are established in how the regulations applied, especially with regards to parking regulations. Reference is made to another 8-30g application pending at 3 Hubbard Road, a site containing an existing bank and 24 housing units with the proposal for an additional 17 housing units. The peak weekday use is analyzed for this project for comparison to that completed for the 2 Hollyhock Road project.

Comparison to	similar pro	pjects					
Project Parking	g Capacity r	equired per Town of Wil	ton Zoning				
3 Hubbard		•	Ü				
Road 24 exist + 17 proposed (assume equal 1 & 2 bedroom)							
			Parking	Total			
Land Use	Quantity	Units	Required	Parking			
Studio	0	dwelling units	1.5	0	spaces		
		and and	1.5	<u> </u>	spaces		
one-bedroom	20	dwelling units	2	40	spaces		
Two bedroom	21	dwelling units	2	42	spaces		
Visitor							
Parking	41	1&2 bedroom	0.5	20.5	spaces		
			Total req'd	102.5	spaces		
			Round-up	103	spaces		
		Parking Provided:		69	spaces		
		Compliance to					
		regulations		-34	spaces		
		Percentage of reg'd					
		parking		66.99%	percentage		

This analysis indicates that this project also is deficient in parking spaces required per the Town of Wilton regulations, yet meets the predicted parking demands based upon an ITE analysis. This project is presented on an hourly basis due to two different use categories on the site: Bank and Apartments.

#### IV) Findings and Conclusions

Based upon the Town of Wilton regulations, 37 parking spaces are required.

Predicted by ITE Parking Generation Code

Based upon this analysis, 21 spaces are required.

Since 23 spaces are proposed, an estimated surplus of 3 spaces (15%) is provided with this proposal, including allocation for visitor spaces.

Similar 8-30G projects submitted to the Town of Wilton

3 Hubbard Road: 67% of Town of Wilton required parking spaces provided

2 Hollyhock Road: 62% of Town of Wilton required parking spaces provided

The adequacy of parking is met based upon the predicted parking demands estimated by the ITE Manual. This addresses trends in reduced parking for apartments due to changes in vehicular use, use of ride share capabilities and proximity to facilities along the Route 7 corridor. The trends anticipated in many studies is the reduction in vehicular use in the near future, with the potential of alternate means of mass transit, such as bus routes, autonomous vehicles and ride share capabilities. This is in addition to the impacts of expanded virtual work environments coupled with delivery services and expansion of key commercial and office facilities in walking distance to the subject apartments, all of which reduce the need for individual vehicle use. Accordingly, there is no anticipated increase in parking required for this occupancy.


The geometry of the site also provides for additional parking along Hollyhock Road which during daylight hours is used by several of the commercial establishments and visitors to the apartments after business closing hours or on weekends. While a specific on-site parking analysis was not completed, this anticipated additional capacity if available and additional to the parking proposed on the site plan.

Respectfully Submitted:


Peder W. Scott, P.E., R.A.

President

Date

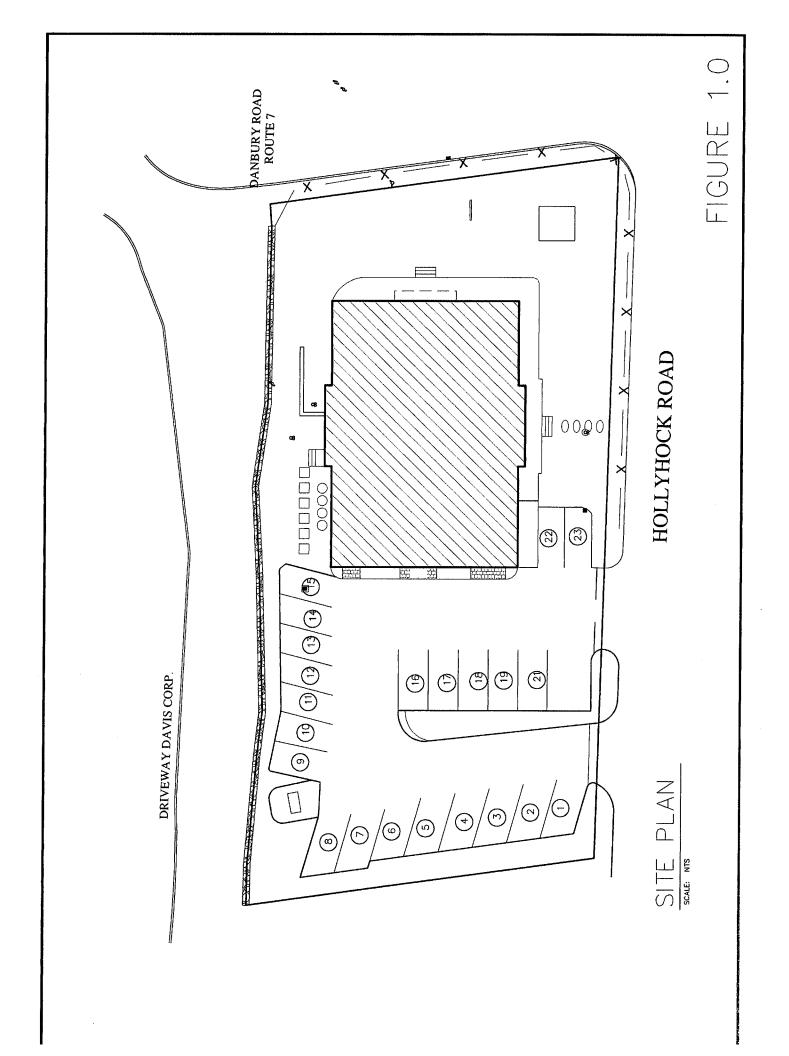



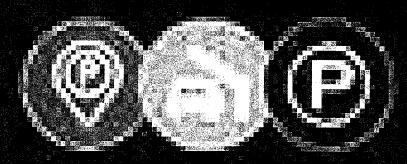

Ter etalot et et

# Multifamily Housing (Low-Rise) (220)

Peak Period Parking Demand vs: Occupied Dwelling Units

On a: Weekday (Monday - Friday)

Setting/Location: General Urban/Suburban (< 1/2 mile to rail transit)

Peak Period of Parking Demand: 11:00 p.m. - 6:00 a.m.

Number of Studies: 7

Avg. Num. of Occupied Dwelling Units: 83

# Peak Period Parking Demand per Occupied Dwelling Unit

		Proupida Direilli	a our	
Average Rate	Range of Rates	33rd / 85th Percentile	95% Confidence Interval	Standard Deviation (Coeff. of Variation)
1.25	0.45 - 1.44	0.85 / 1.41	***	0.25 ( 20% )
	T			(,-,

