

NOTES:


- EXISTING AND PROPOSED SITE INFORMATION TAKEN FROM A DIGITAL AUTOCAD PLAN SUPPLIED BY B&B ENGINEERING, ENTITLED "SITE DEVELOPMENT PLAN" OF 516 DANBURY ROAD", DATED 2-4-20.
- EXISTING TREE LOCATIONS HAVE BEEN FIELD LOCATED BY ELS AND ARE APPROXIMATE.
- EXACT LOCATION OF PROPOSED PLANTINGS AND SPECIES TYPES MAY VARY FROM THIS PLAN BASED ON SITE PLAN REVISIONS AND/OR ACTUAL FIELD CONDITIONS.
- SEED AL DISTURBED AREA ADJACENT TO AND IN THE WETLAND WITH NEW ENGLAND WETLAND PLANTS "WETMAY". AT THE METHODS AND 150% THE RATE RECOMMENDED BY THE MANUFACTURER. LIGHTLY MULCH SEEDER AREA WITH WEED FREE CLEAN HAY. A NURSE CROP SHALL BE ADDED TO THE SEED MIX ON SLOPES OF EXCESS OF 10% AND AS SPECIFIED. SEED MIX SUBSTITUTIONS SHALL BE EQUIVALENT TO THAT SPECIFIED AND APPROVED BY THE PROJECT LANDSCAPE ARCHITECT PRIOR TO USE. EXCEPT FOR LAWN AREAS, DO NOT FERTILIZE AREAS TO BE SEEDER. LIGHTLY RAKE OR ROLL GROUND SURFACE AFTER SOWING. SEED AREAS AS PER THE FOLLOWING SCHEDULE:
- SPRAY NEW PLANTINGS IMMEDIATELY AFTER INSTALLATION WITH A WHITE-TAILED DEER REPELLENT AND CONTINUE AS NEEDED TO MAINTAIN PLANTS FREE OF SIGNIFICANT DEER BROWSING.
- PLANT SPECIES SUBSTITUTIONS MAY BE MADE WITH THE APPROVAL OF THE WILTON WETLAND COMMISSION PRIOR TO PLANTING. SUBSTITUTED PLANTS SHALL BE AT AN EQUAL OR GREATER SIZE AS NOTED USING A SIMILAR TYPE PLANT.
- MULCH TREES WITH A 2.5" THICK LAYER OF SHREDED BARK MULCH. AREAS WITHIN 4" OF TREE TRUNKS SHALL BE MAINTAINED FREE OF MULCH.
- ALL PLANTING METHODS SHALL BE IN ACCORDANCE WITH THE "AMERICAN STANDARDS FOR NURSERY STOCK", LATEST EDITION, AS PUBLISHED BY THE AMERICAN NURSERY & LANDSCAPE ASSOCIATION.
- IN THE EVENT OF A DISCREPANCY BETWEEN THE QUANTITIES OF PLANTS IN THE "PLANT LIST" AND THE ACTUAL QUANTITIES SHOWN ON THE PLAN, THE PLAN SHALL GOVERN.
- THIS PLAN FOR PLANTING PURPOSES ONLY. SEE PLANS BY OTHERS FOR ADDITIONAL INFORMATION.
- THE BOULDER DEMARCATION ROW SHALL BE COMPOSED OF TWO-MAN BOULDERS (2 CUBIC FEET) OR LARGER SPACED 15-20' ON CENTER. MAINTAINED LANDSCAPED AREAS (SUCH AS LAWN) WILL BE PERMITTED UPHILL OF THE BOULDER ROW. LAND DOWNSLOPE OF THE DEMARCATION FEATURE SHALL BE MAINTAINED IN A NATURAL UNMAINTAINED WOODED STATE EXCEPT EXISTING LAWN AREA WHICH SHALL REVERT TO A MEADOW CONDITION. THE BOULDERS MAY BE PARTIALLY SUNKEN INTO THE GROUND WITH A MINIMUM OF 8" EXPOSED ABOUT THE FINAL GRADE.

PLANT LIST FOR WETLAND AREAS



QTY	KEY	BOTANICAL NAME	COMMON NAME	SIZE	ROOT	REMARKS
4	RM	ACER RUBRUM	RED MAPLE	2-2.5" CAL.	B&B	FULL

PLANT LIST FOR UPLAND AREAS

QTY	KEY	BOTANICAL NAME	COMMON NAME	SIZE	ROOT
SHRUBS & GROUND COVER					
1	CH	CLETHRA HUMMINGBIRD	HUMMINGBIRD CLETHRA	18-24" HT.	CONT.
1	HQ	HYDRANGEA QUERCIFOLIA	OAKLEAF HYDRANGEA	2-5.3' HT.	CONT.
3	HH	ILEX HELLERI	HELLERI HOLLY	18-24" HT.	CONT.
3	PK	POTENILLA DAKOTA SUNSPOT	CINQUEFOIL	12-18" HT.	CONT.
1	VN	VIBURNUM NUDUM LIL. WITHEROD	WITHEROD VIBURNUM	30-36" HT.	CONT.
200	PT	PACHYSANDRA TERMINALIS	PACHYSANDRA	FLATS	CONT.
1	PO	PLATANUS OCCIDENTALIS	AMERICAN SYCAMORE	3-3.5" CAL.	B&B

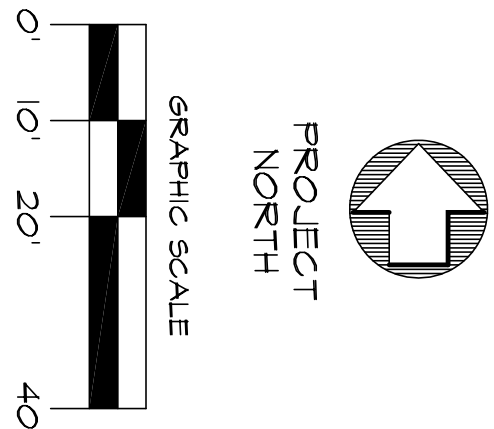

LEGEND

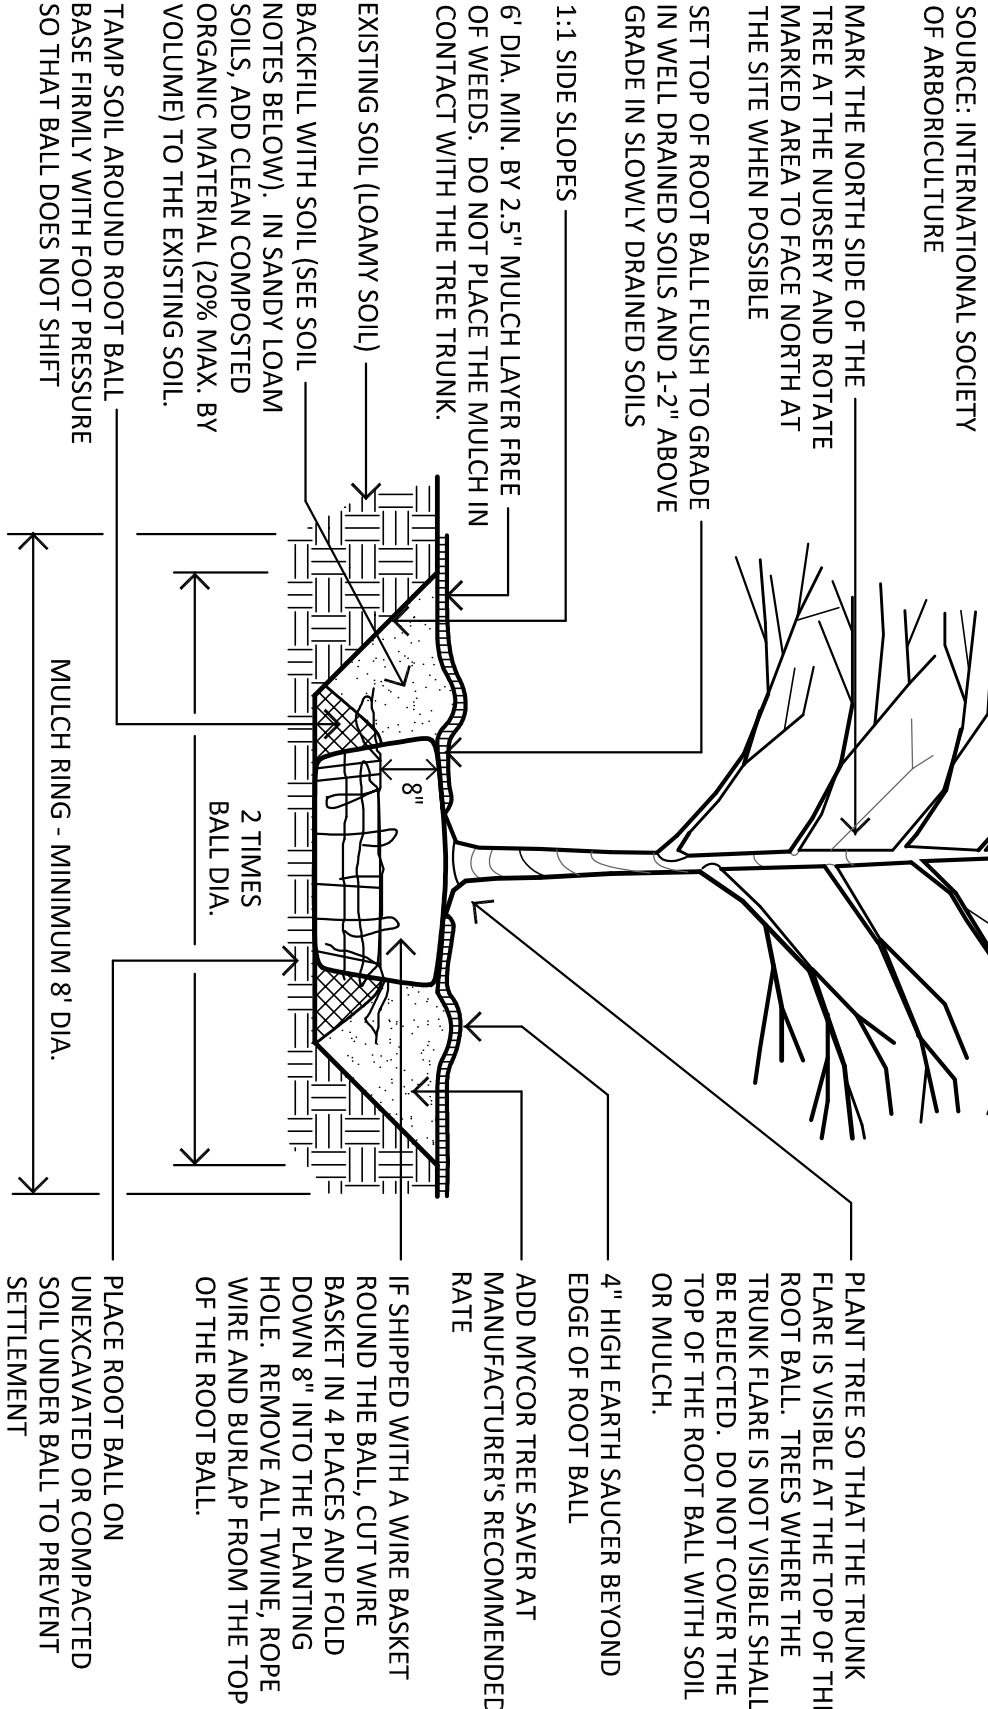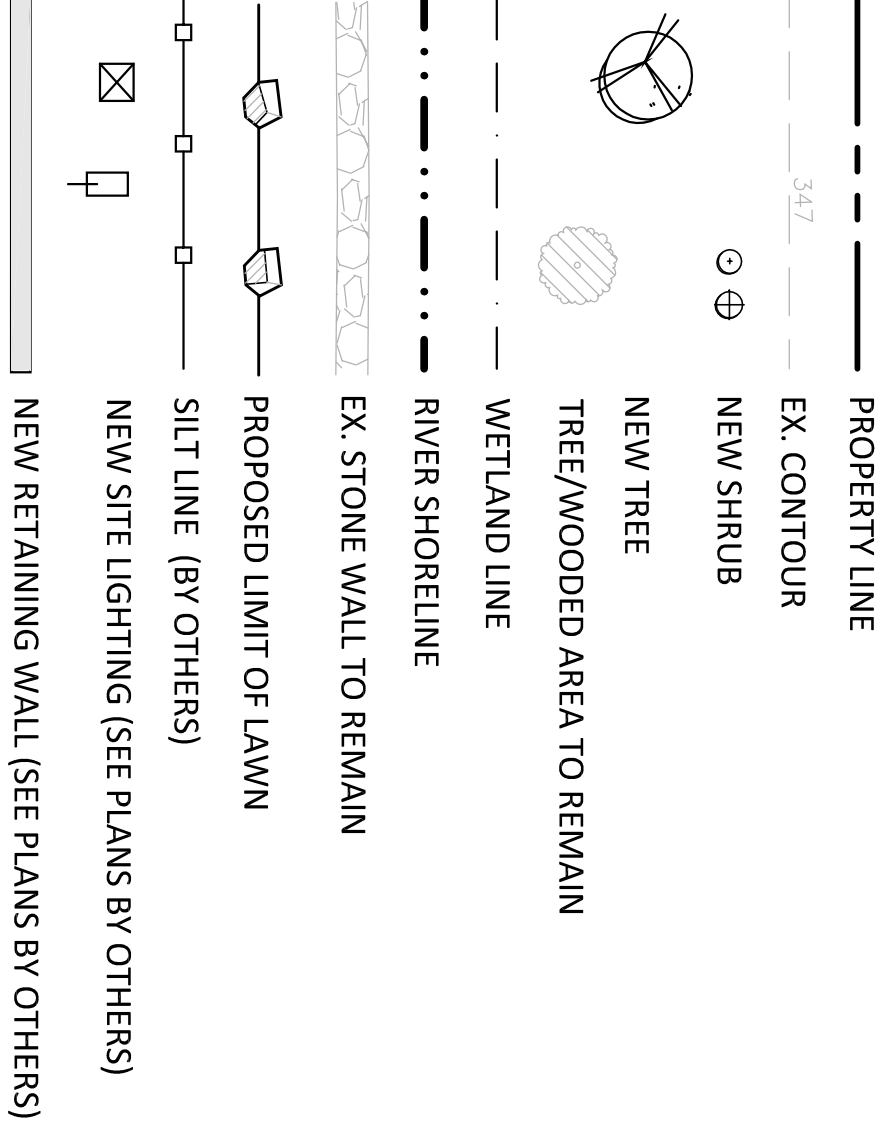

- PLANTING NOTES:
- DO NOT HEAVILY PRUNE THE TREE AT PLANTING. PRUNE ONLY CROSSOVER LIMBS, CO-DOMINANT LEADERS, AND BROKEN OR DEAD BRANCHES. DO NOT REMOVE THE TERMINAL BUDS OF BRANCHES. DO NOT REMOVE THE TERMINAL BUDS OF BRANCHES. DO NOT REMOVE THE TERMINAL BUDS OF BRANCHES. DO NOT REMOVE THE TERMINAL BUDS OF BRANCHES.
 - WRAP TREE TRUNKS ONLY UPON THE APPROVAL OF THE LANDSCAPE ARCHITECT.


- SOIL NOTES:
- CLEAN FILL MATERIAL SHALL BE A LOAMY SOIL. LOAMY SOILS INCLUDE THE FOLLOWING USDA TEXTURAL CLASSIFICATIONS AND HAVE A CLAY CONTENT BETWEEN 7% TO 27%; LOAM, SANDY LOAM AND SILT LOAM. NOTE THAT SOILS AT THE OUTER LIMITS OF THE LOAM CLASSIFICATION MAY PRESENT SPECIAL PLANTING PROBLEMS NOT ANTICIPATED BY THE DETAIL. THE SOIL STRUCTURE SHALL NOT BE PLANTY OR MASSIVE. A SUITABLE PLANTING SOIL IS 65% SAND, 20% COMPOST, AND 15% CLAY LOAM.
 - LOAM SOILS ARE DEFINED AS A GRANULAR OR BLOCKY FRIABLE SOILS, A MIXTURE OF SAND, SILT AND CLAY PARTICLES WITH A WITH GROWTH OR DRAINAGE.

- STAKING NOTES:
- STAKE TREES ONLY IF IT IS EXPECTED THAT THE TREE WILL NOT BE ABLE TO SUPPORT ITSELF AND REMAIN STRAIGHT. STAKE TREES FOR THE FOLLOWING REASONS:
 - THE TREE IS INSTALLED WITHIN VERY SANDY SOIL OR VERY WET CLAY SOIL.
 - THE TREE IS LOCATED IN A PLACE OF EXTREMELY WINDY CONDITIONS.
 - CONTACT THE PROJECT LANDSCAPE ARCHITECT FOR STAKING DETAIL IF NEEDED.

TREE PLANTING DETAIL


SCALE: NOT TO SCALE

REVISIONS:

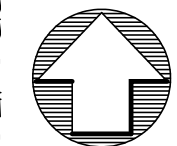

PROJECT NORTH

GRAPHIC SCALE

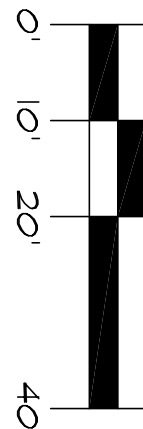

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SCALE: 1"=20'

DRAWING NO: LP-1