


**WILTON PUBLIC WORKS
DEPARTMENT**

(203) 563-0153

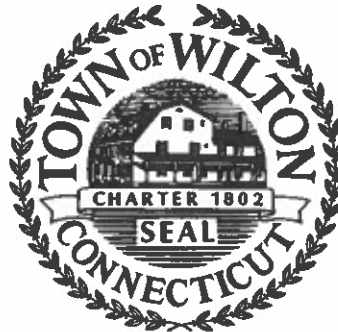

**TOWN HALL ANNEX
238 Danbury Road
Wilton, Connecticut 06897**

TO: WPCA Commission

FROM: Frank Smeriglio, PE –
Director of Public Works/ Town Engineer *F.S.*

DATE: January 5, 2024

Cc: Michael Wrinn – Director of Planning & Zoning
Craig Flaherty, PE – Redness & Mead Consulting

RE: 131 Danbury Road, Wilton CT – 131 Danbury Wilton Dev AMS, LLC

This letter is written in response to the review of the submission by Redniss & Mead dated November 17, 2023 for the proposed development on 131 Danbury Road. Based on the review of the above mentioned application at this time, the items listed below shall be addressed:

- 1) The project is subject to obtaining approvals from Wilton's WPCA Commission to connect additional units into the sanitary sewer system. The WPCA is currently evaluating all flows from proposed development projects to determine if proposed flows at the Town line will remain below what's allowed in the Interlocal Agreement between Norwalk and Wilton.
- 2) Engineer proposes to utilize a flow of 55 gallons/bedroom in lieu of 150 gallons/bedroom for the purposes of evaluating overall flow discharge to Norwalk. Engineer shall provide summary to the WPCA Commission for review. Furthermore, Engineer's summary shall include, but not limited to the following:
 - a. Is there going to be discharge from a pool – what are the total discharges for the season. Also, refer to item #3.
 - b. How will the owner monitor and limit occupancy in the building to ensure flows are below 55 gallons/bedroom?
 - c. How will the owner monitor the flows to remain below 55 gallons/bedroom and what adjustments will be made if they are over.
 - d. Is there added flows for office/staff use in addition to the apartments.
- 3) For the proposed pool:
 - a) What are the discharge frequencies and flow rates associated with the pump discharge?
 - b) General Permit for the discharge of Swimming Pool Wastewater may be required with the Town of Wilton and/or State of Connecticut.
 - c) Depending on responses to sub item "a", Pump discharge times will be restricted.

- 4) Design Engineer shall address Norwalk WPCA's review as per email dated 11/28/23.
- 5) Engineer to evaluate the use of an 8" sewer line. The proposed sewer lateral shall be connected to a new manhole along the existing sewer main within Route 7. Modify details.
- 6) Garage drains on the lower level subject to the 100-year flood limits shall tie to an oil separator and not discharge into the sanitary system. Engineer to evaluate other discharge locations (i.e. storm infiltrators).
- 7) Sewer Capital Assessment in accordance with WPCA regulations shall be levied on the property.
- 8) Please note, Property owner shall be responsible for maintenance and any potential clogs in the lateral and/or sewer main connection points up to the main sewer line on Route 7.
- 9) All proposed sewer lines shall be air tested prior to sign off of certificate of occupancy.
- 10) All proposed work in the State Right of Way shall be subject to the State Encroachment Permit approval.
- 11) Prior to the issuance of a Certificate of Occupancy, a certified as-built drawing and certified letter signed by a Professional Engineer indicating that all work was completed in accordance with the design plans shall be submitted to the Town of Wilton.

Based on the items above, this list shall be considered preliminary. Additional items shall be requested depending on responses to the above.

If you have any questions, please do not hesitate to call.

November 17, 2023

Lynne Vanderslice, Chair
Water Pollution Control Authority
Town Hall
238 Danbury Road
Wilton, CT 06897

RE: Sewer Connection Approval
Project Address: 131 Danbury Road
Applicant: 131 Danbury Wilton Dev AMS LLC, an affiliate of AMS Acquisitions, LLC

Dear Ms. Vanderslice and members of the Water Pollution Control Authority,

131 Danbury Wilton Dev AMS LLC, the contract purchaser of 131 Danbury Road and our client, is proposing to remove an existing 50,000sf office building and construct a 4 ½-story building with 208 apartments and appurtenant parking, infrastructure, and amenities. The 4.75± acre property is located on the westerly side of Danbury Road 1,100 feet south from its intersection with Westport Road. On behalf of our client, we are requesting Sewer Connection Approval from the Water Pollution Control Authority. An application with the Inland Wetland Commission has been filed and a Planning & Zoning application is being filed soon.

Included herewith for your consideration are the following documents:

1. Downstream Sewer Capacity Analysis prepared by SLR dated November 16, 2023
2. Site Utility Plan and Site Details by SLR dated November 14, 2023
3. Architectural Site and Floor Plans by Beinfield Architecture dated November 16, 2023

The Downstream Sewer Capacity Analysis prepared by SLR indicates ample capacity in the receiving 24-inch diameter sewer main in the road fronting the site. We look forward to presenting our request to the Authority at the upcoming meeting on December 13th.

Sincerely,



Craig J. Flaherty, P.E.

cc: Frank Smeriglio, Town Engineer

The proposed 6-inch SDR-35 PVC sewer lateral will be approximately 170'-4" long with a slope of 2.11 percent, which provides a maximum capacity of 476 gpm. With a peak estimated discharge of 137 gpm, the pipe will be flowing at 29 percent of capacity. The proposed 6-inch sewer lateral has ample capacity to accommodate the peak sewer discharge from 131 Danbury Road.

Let me know if you have any questions.

Regards,



SLR International Corporation



Thomas A. Knowlton, PE
Principal Water & Wastewater Engineer

21543.00001.0008.n1623.memo.docx



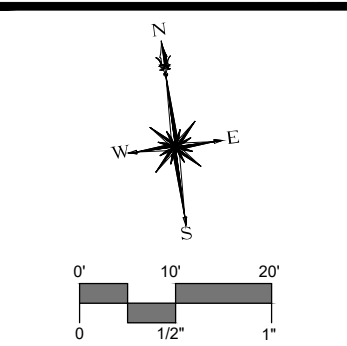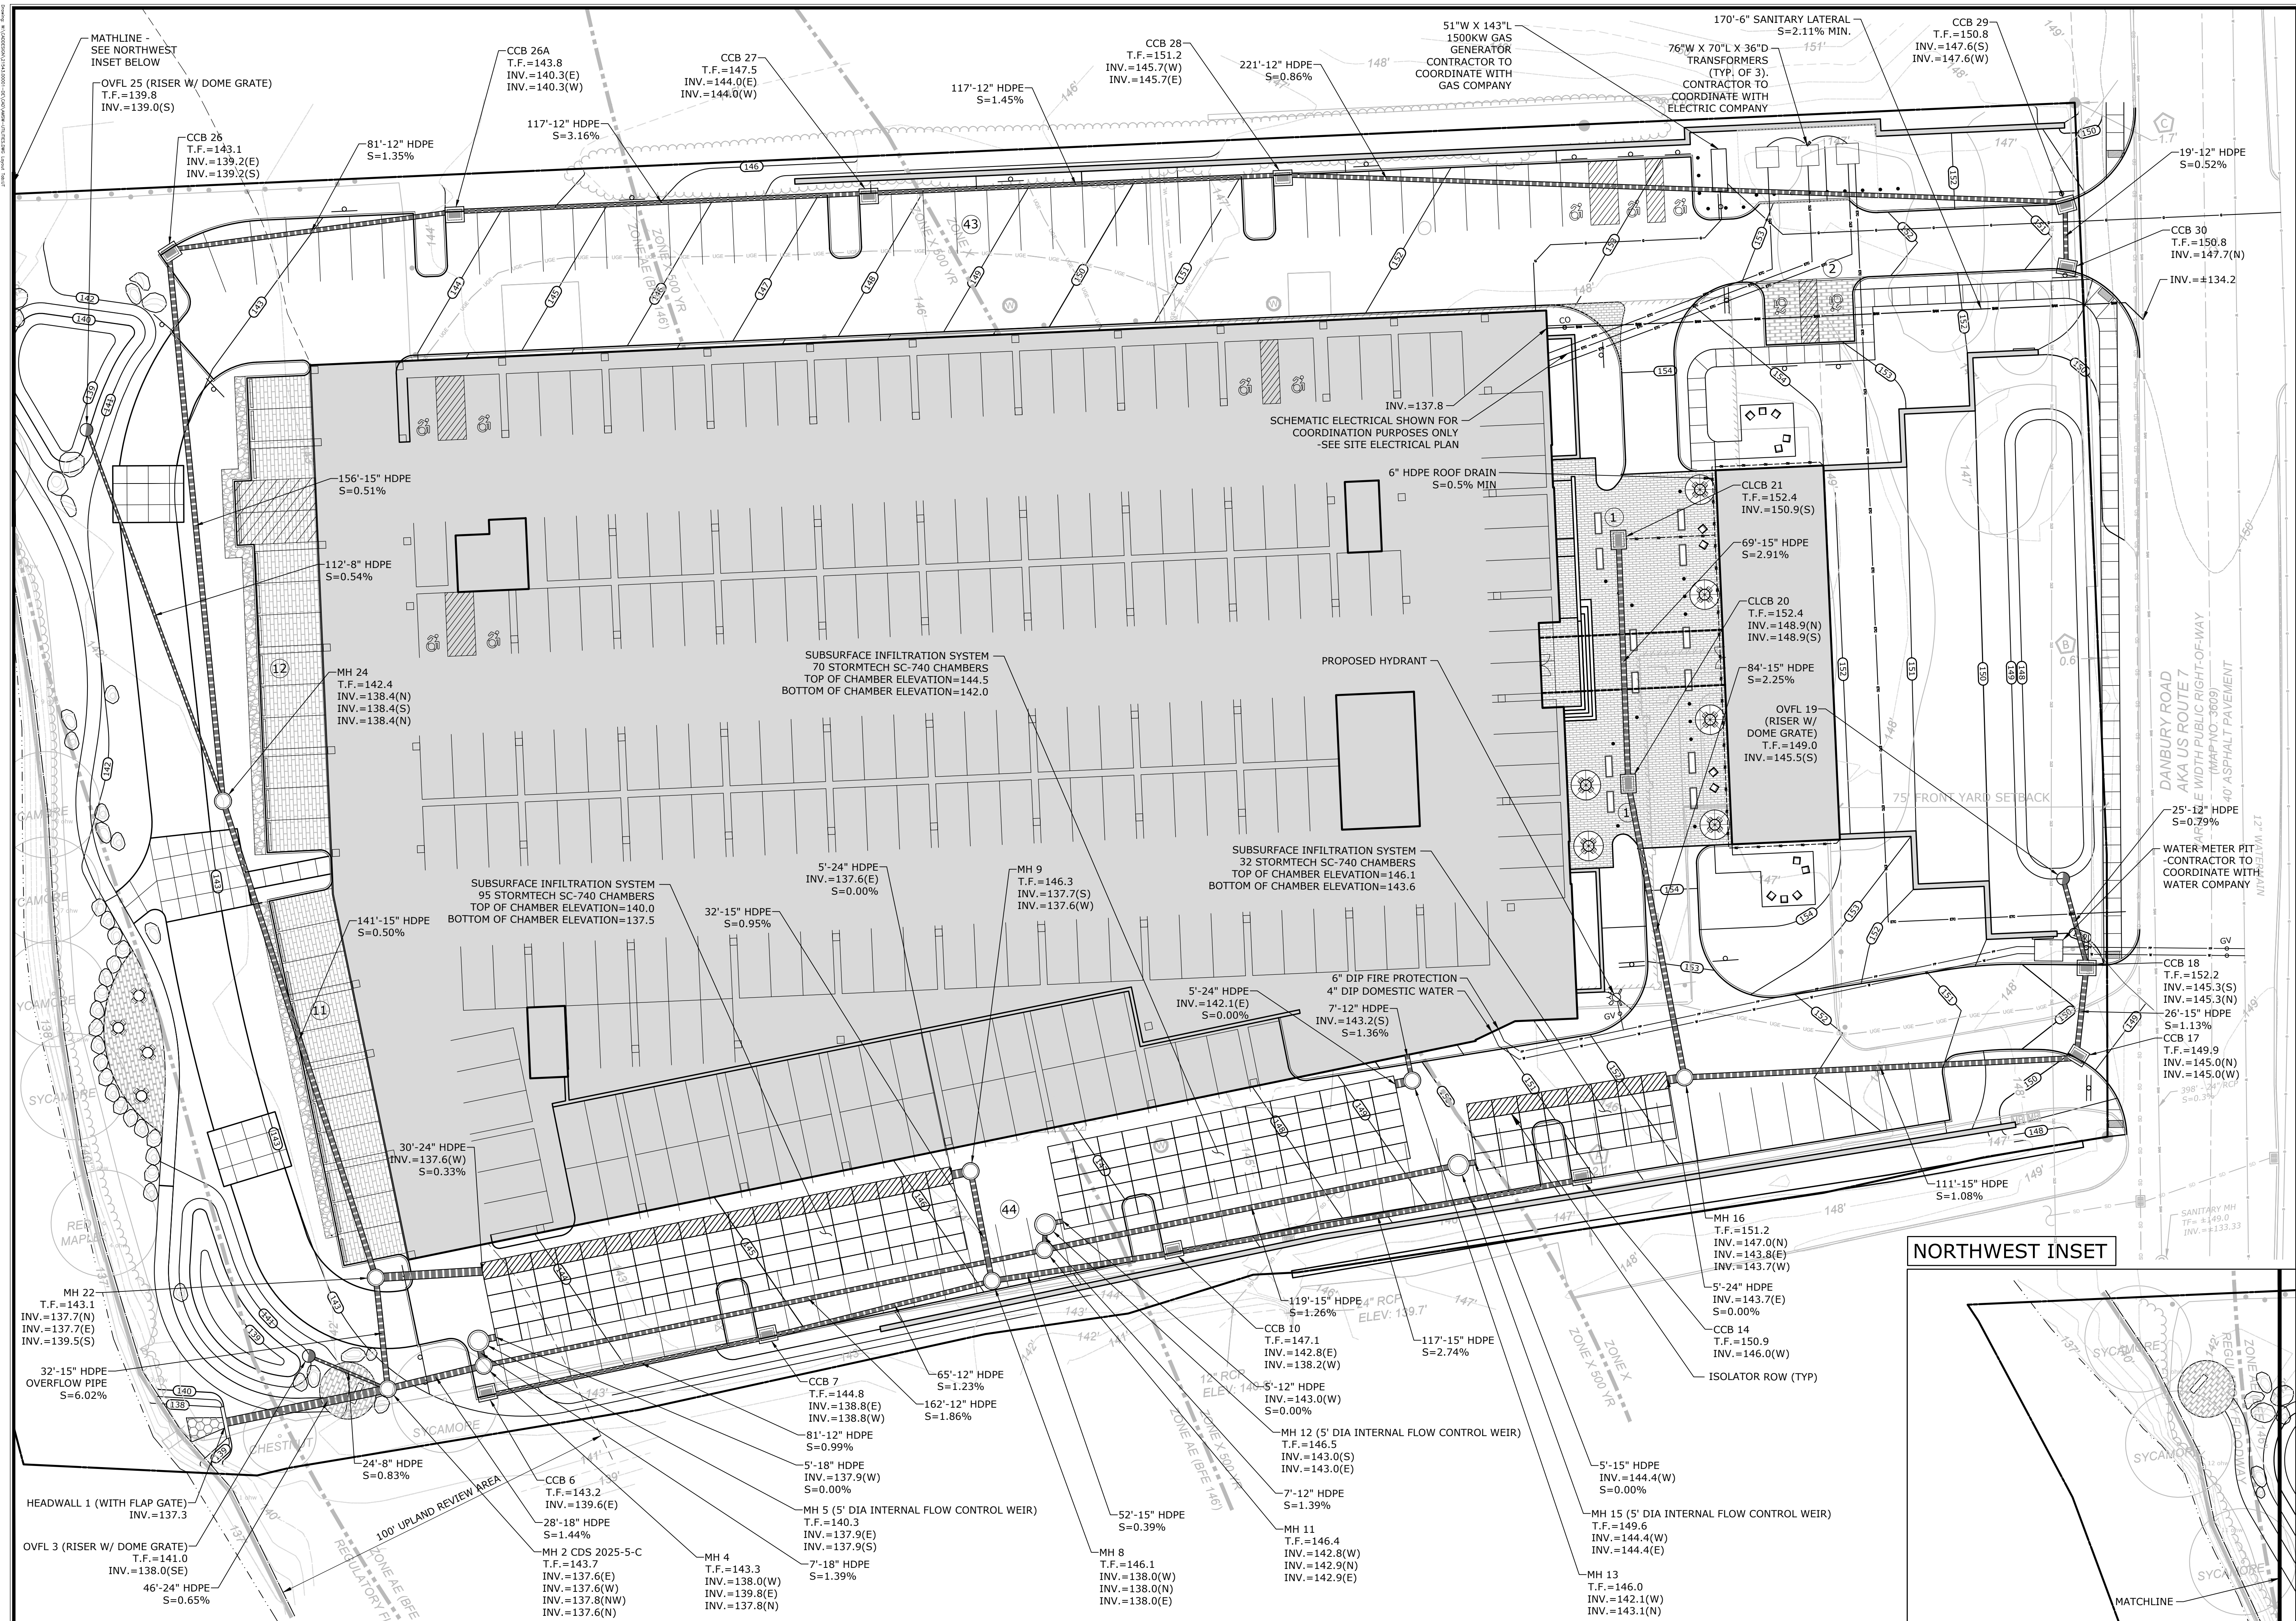

DESCRIPTION	DATE	BY
PAZ SUBMISSION	11/10/2023	AWG
WPCA REVISIONS	11/14/2023	AWG


SITE PLAN - UTILITIES
PROPOSED MULTI-FAMILY DEVELOPMENT
 131 DANBURY ROAD
 WILTON, CONNECTICUT

AWG	RH	TD
DESIGNED	DRAWN	CHECKED


SCALE: 1"=20'
 DATE: **OCTOBER 23, 2023**
 PROJECT NO: 21543.00001
 SHEET NO: **08 OF 21**
UT



11/16/23

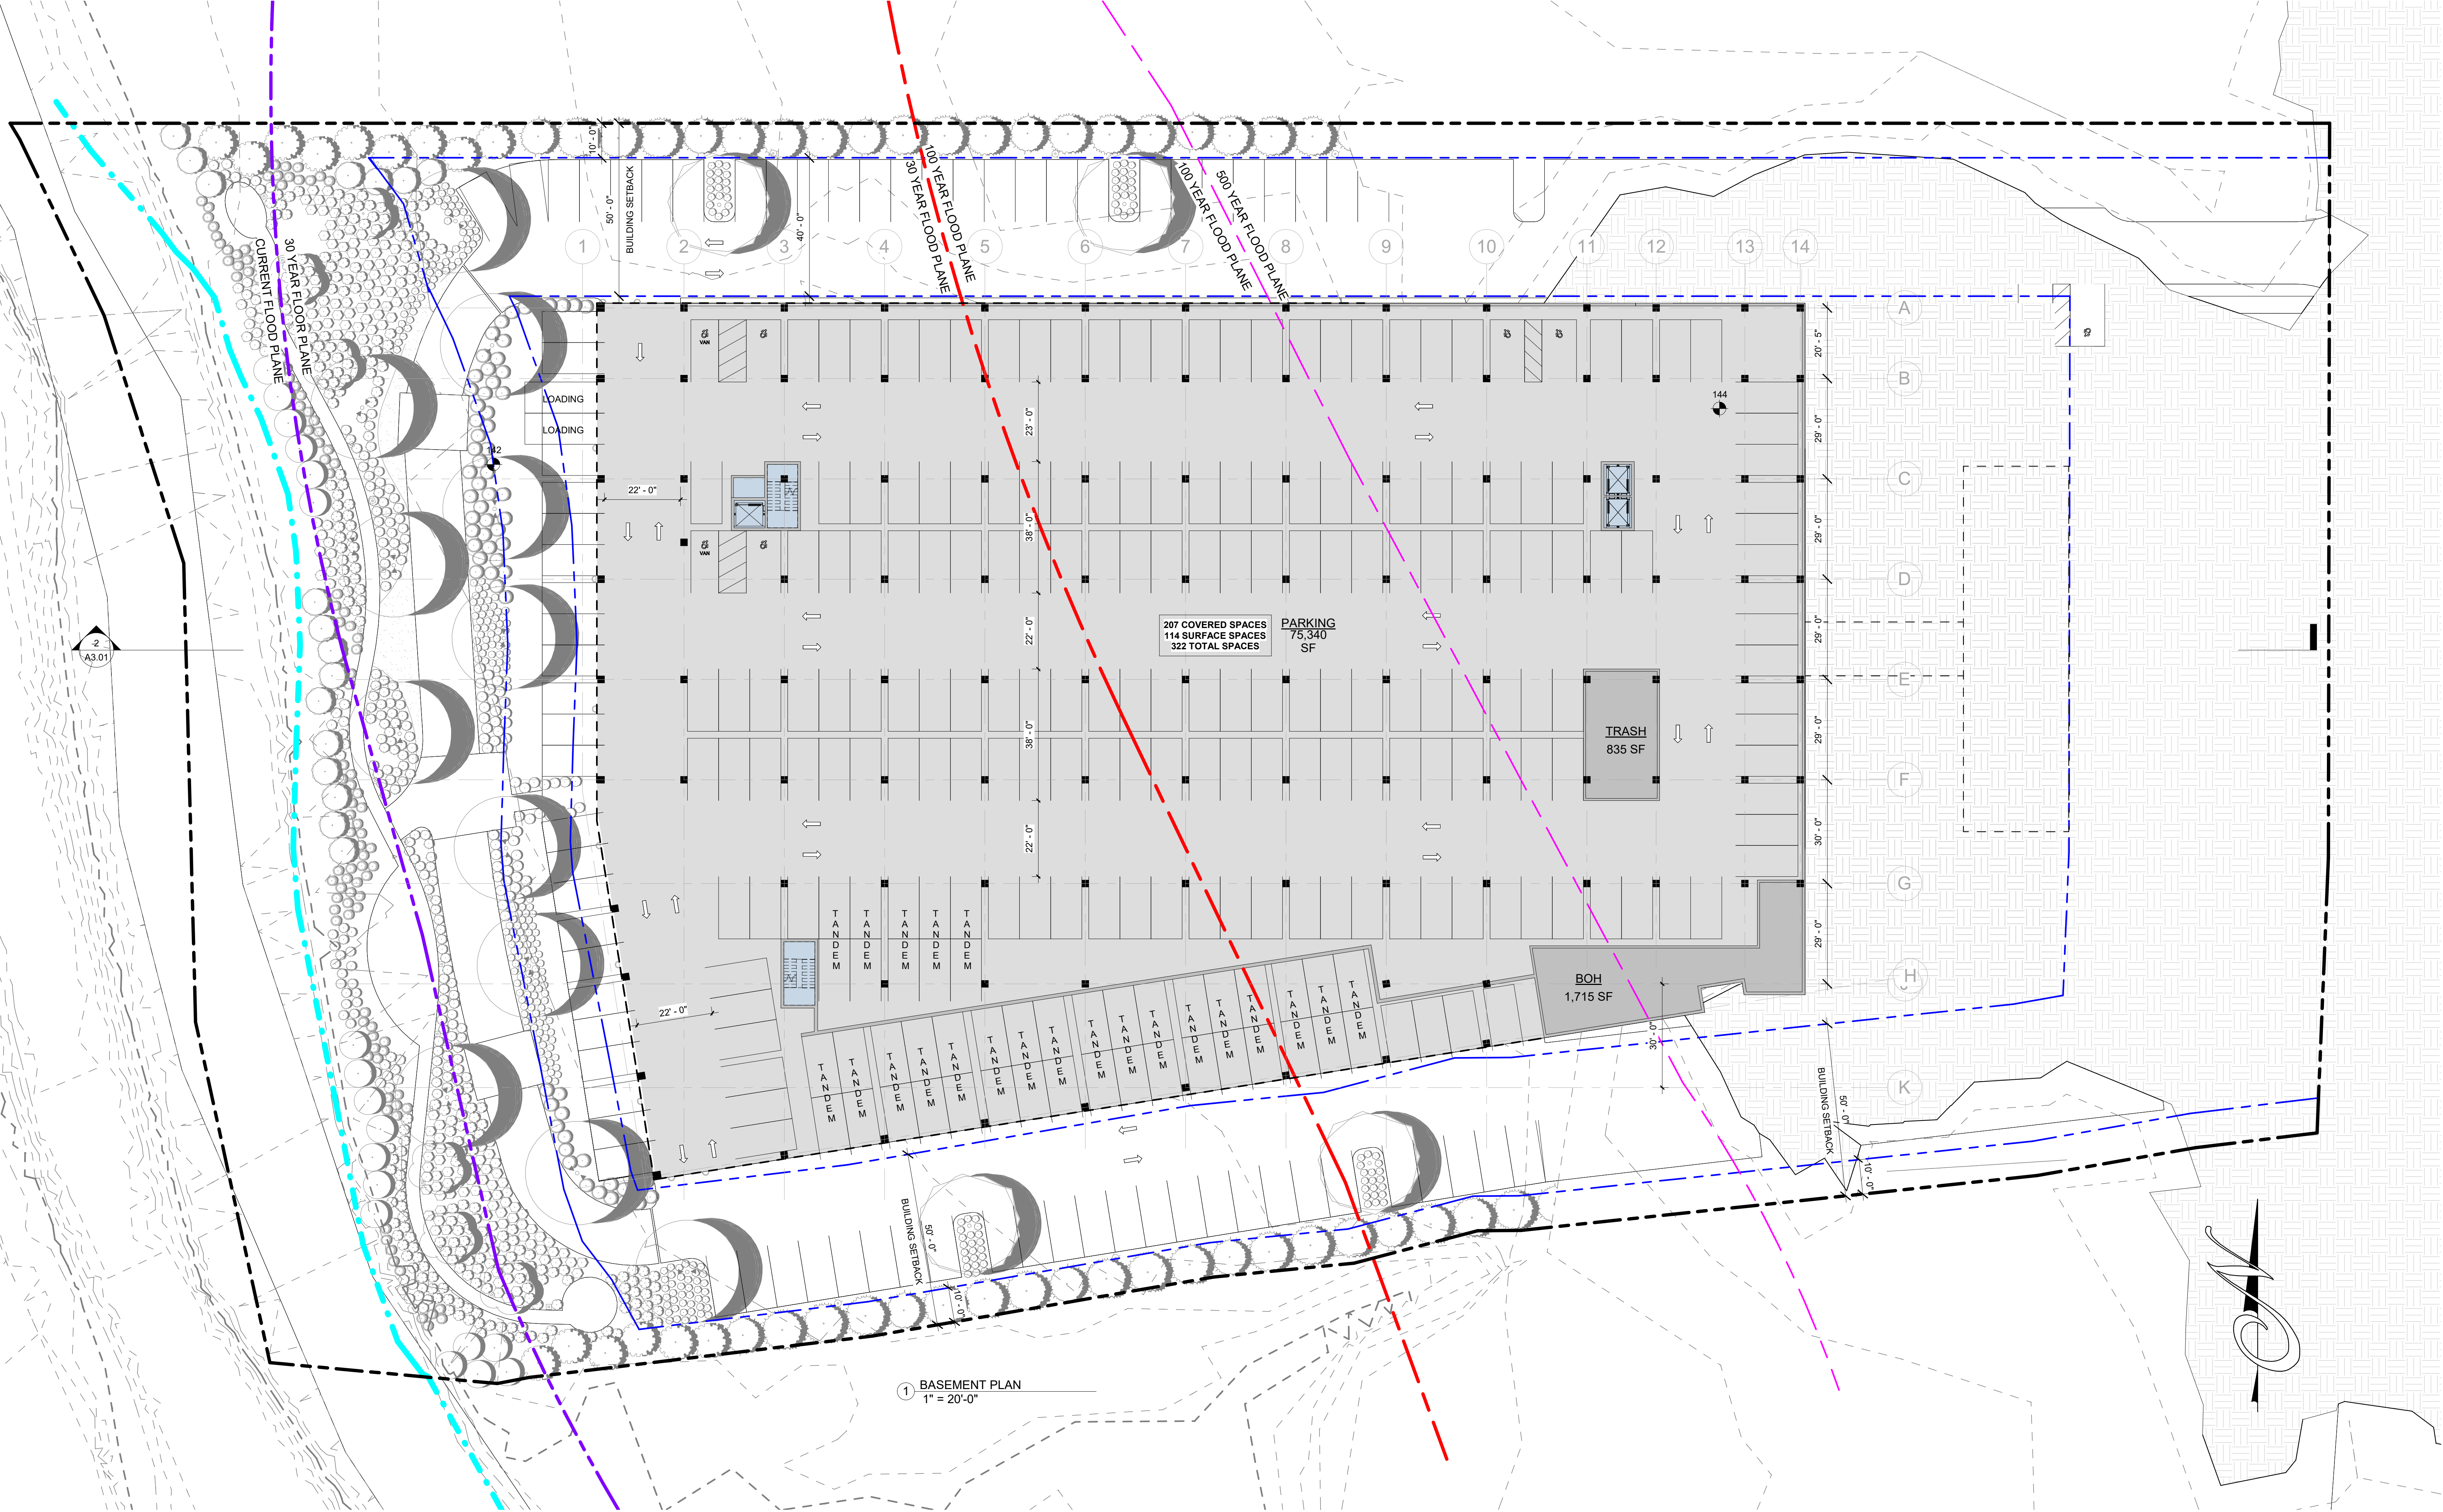

1 BASEMENT PLAN
1" = 20'-0"

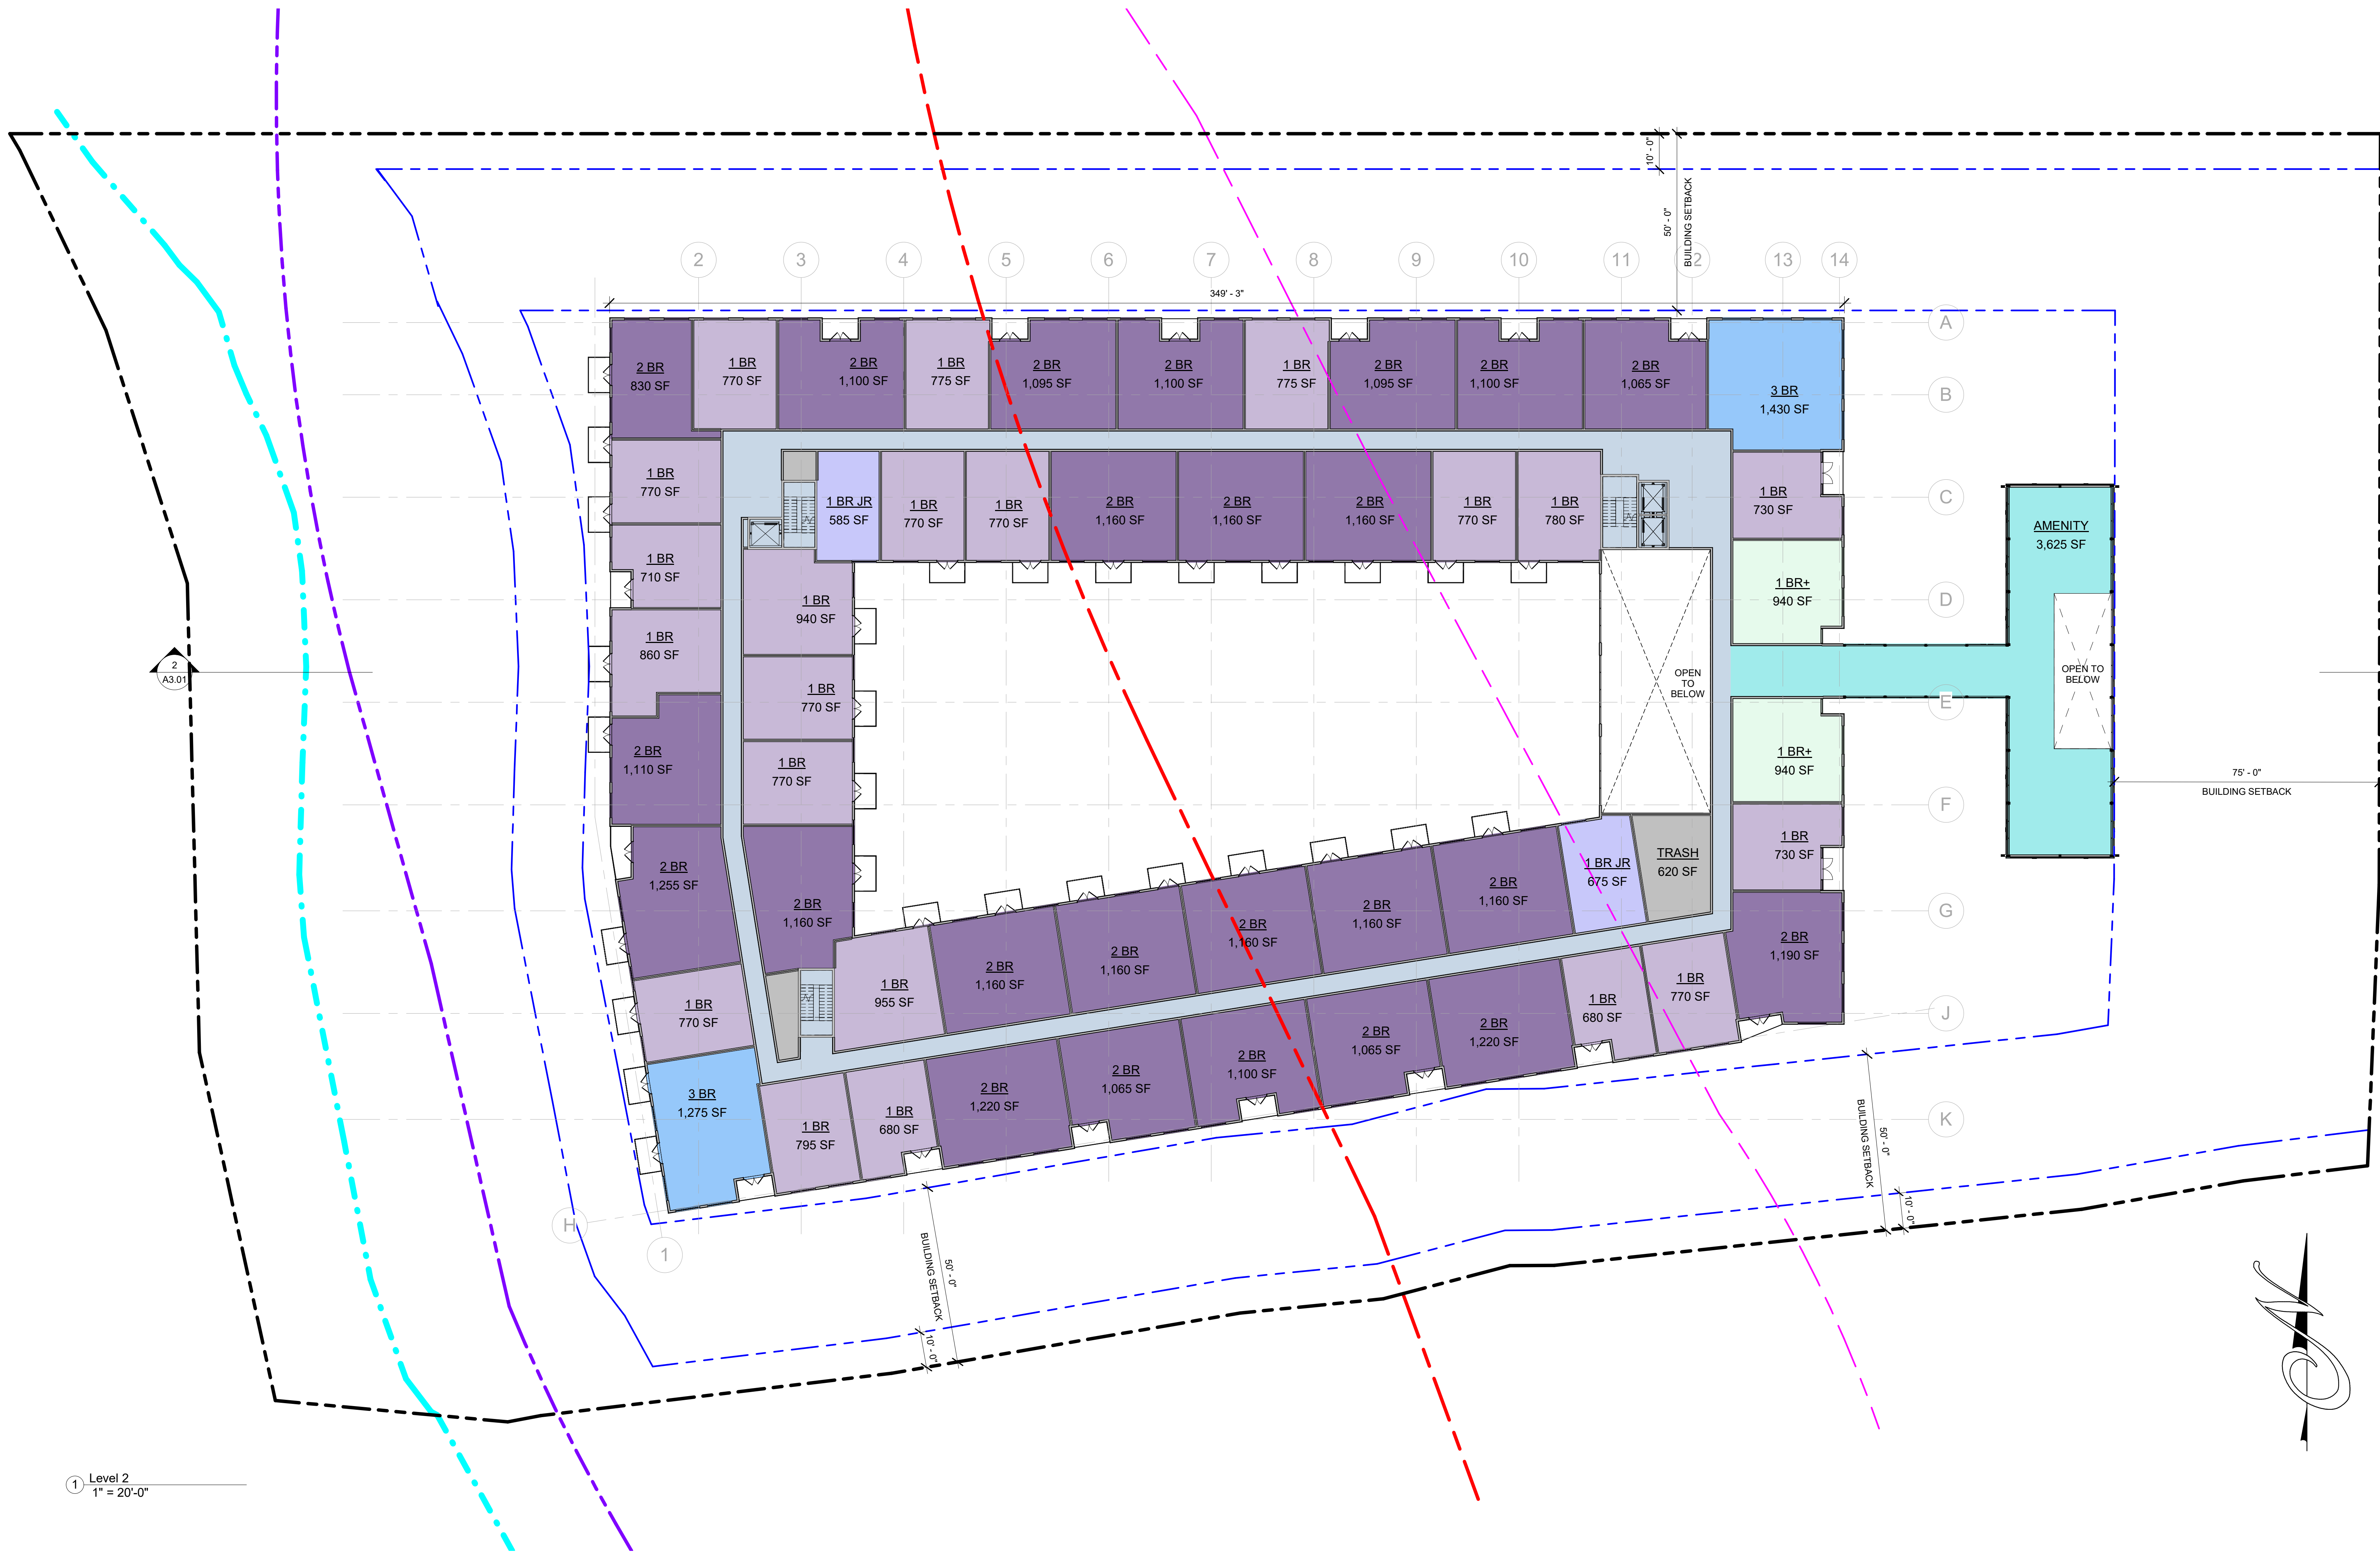

2
A3.01

1 Level 2
1" = 20'-0"

