## REQUEST FOR QUALIFICATIONS / PROPOSALS (RFQ/RFP)

**FOR** 

## ARCHITECTURAL / ENGINEERING SERVICES SCHOOL FACILITIES NEEDS ASSESSMENT RFP/RFQ NUMBER #W-2023-11



## August 4, 2023 ADDENDUM NO. 2

Addendum No.2 is being issued to all potential bidders to provide the items and attachments set forth herein which shall act to qualify, clarify, or otherwise modify the Documents previously issued regarding the above referenced project. These items, whether of omission, addition, substitution, or clarification, shall be incorporated into the proposals submitted by all proposers, and receipt of this document and its attachments must be acknowledged, either in the space provided on the Proposer's Form of Proposal. Failure to do so may subject the Proposer to disqualification.

- 1. Sign-In Sheet for Non-Mandatory Walk-Through conducted on Friday July 28, 2023.
- 2. Response to RFI No.1 submitted on 8/3/23.
- 3. Fee sheet included in the RFP is hereby Deleted, attached Fee sheet is to be utilized.
- 4. The Team Rooms and the Press Box at Veteran's Stadium will be added to

Town Buildings Facilities Needs Assessment RFQ/RFP Architectural/Engineering Services W-2023-11

the Scope of Work.

- Press Box, 2007, 336sf
- Team Rooms, 2007, 3,108sf
- 5. Drawings for the Press Box and Teams Rooms at Veterans Stadium.

All other terms and conditions of RFQ/RFP W-2023-11 remain the same.



Project: Architectural/Engineering Services

Facility Needs Assessment

Date: Friday, July 28, 2023

RFQ/RFP: W-2023-11

Walk Through Sign-In Sheet

### RFI No. 1

Written Questions for Wilton Facilities Needs Assessment-Town Buildings RFP/RFQ #W-2023-11

To be sent via email to: <u>jeff.pardo@wiltonct.org</u>
Jeff Pardo no later than Friday, August 4, 3023 at 4PM.

1. Volunteer Ambulance Corps is not listed in the RFP, but there are questions and scope described to examine new locations for this function. Should this be added to the fee breakdown?

Response: See revised fee sheet

2. Priority 1 includes "cited safety hazards" Does this mean there are hazards that were previously documented by code officials? If so, by whom? Can a full list be provided?

Response: Safety inspections have been performed by the Towns Safety Inspection Team on all Town buildings. Some of the items cited in the reports have been completed. These reports will be made available to the firm selected by the Town.

3. Are there existing hazardous materials test reports for any of the buildings? Our team could include environmental/hazmat personnel to walk through each building and identify risks and potential costs that warrant further testing and investigation. Or we could identify that as an optional additional service. Is that an appropriate approach given your current information and needs?

Response: There are reports on some of the buildings, all available reports will be made available to the firm selected by the Town. The RFP indicates the age of the buildings and renovations that have occurred. Based on the age of the buildings, hazardous materials will be present in many of the buildings. The scope does not include hazardous material inspection, but the cost to perform inspections and potential abatement needs to be included in the assessments.

4. The RFP is identified as a Facility Needs Assessment, but the scope reads more as a Property Condition Assessment in that it focuses more on building conditions than program needs. Does the town already have a listing of program needs that the nine buildings are expected to accommodate, or do we need to assemble one as part of the scope of this effort? It was mentioned that you will expect the A/E to talk with each of the Department Heads during this effort. This can be at any number of different levels of discussion that range from high level brief overviews to details. Please clarify the level of program information you can provide and how much you wish the A/E to derive from discussions.

Response: The intent of the RFP is to focus on facilities assessment more than program needs. However, the consultant will interview Directors and Department Heads in understanding their needs since many of the buildings ae at capacity or have exceeded capacity. The scope of the RFP is not for the consultant to prepare designs, but to make recommendations toward the maintenance and renovations of the buildings with cost estimates over the next 10 years. Each year, if funding is approved to address the needs described in the facilities assessment, an RFP will be prepared to hire a consultant to prepare designs and contract documents so that specific need can be addressed through a competitive Bid.

7. The fee breakdown in Appendix D does not align perfectly with the scope (including as described in Question #1 above). Additionally, there is an economy of scale that can be realized if we review multiple buildings rather than one, but the breakdown asks for a cost for each building separately. What is the town's preference for presentation of potential fee discounts for multiple properties on the town hall site as the key example, then Comstock and the others separate?

Response: The Town will be entering into an agreement with just one consultant, the Needs Assessment will not be broken up into multiple different consultants. The Fee Proposal is for the Town to understand the costs for each building and to manage payments while the work is being performed by the consultant.

8. Will a single consultant be hired for the entirety of the project, or is there a chance the buildings will be divided up among multiple firms?

Response: Only one consultant will be hired.

9. We routinely provide opinions of probable cost and remaining useful life estimates for our Property Condition Assessments, but the language in the RFP suggests something more precise and detailed. We anticipate utilizing a professional estimator as part of our team for this effort. Please confirm this is appropriate for your current needs.

Response: An independent estimator would be appropriate, however, if a consultant is proficient at preparing estimates, then that service could be performed in house.

10. You have provided a copy of the drawings the Town has on these sites. You write that "the consultant will verify all dimension and conditions and prepare the necessary CAD fields..." That is not typical or practical in this kind of Assessment with a five week schedule of investigation and documentation.

Response: The Town does not have every drawing of every building or the latest renovations. The consultant will need to verify that the information provided is correct.

11. If it becomes obvious that measured a s built drawings would be helpful. We can offer that as an additional subcontractor.

As one example, if Town Hall does indeed require field measurements of the building, inside and outside to assess feasibility of adding a second floor,, elevators and stairs etc. we can provide a separate cost for such a measuring service. Do you want such an option as an additional line item now? That may also be true for the ANNEX/Dog Pound structure. That may also be true for Comstock. Please advise if Wilton would find receiving digitized, fully measured, as built drawings useful. It would be a subcontractor. The Town could engage directly or the AE can as a pass through. Our clients have found it most helpful. It does take 4-6 weeks by itself to produce documents. It may also be better later as the capital projects are identified since not every building will need this level of detail.

Response: If it is necessary for the consultant to prepare as-builts, then that work needs to be included in the fee. As-builts may not be required depending on the accuracy of the information the Town currently has. The firm(s) hired to prepare the designs and construction documents will be expected to prepare all required drawings on CADD.

Fee breakdown:

## **APPENDIX D: Fee Proposal Form**

The following Fee is proposed to perform the duties, responsibilities and obligations as described in this RFQ/RFP. The project shall be completed under a lump sum fee arrangement as follows.

Town Hall	
Investigation, Survey and Documentation	\$
Preliminary Needs Assessment	\$
Final Report	\$
Sub-total cost	\$
Annex Building/Animal Shelter	
Investigation, Survey and Documentation	\$
Preliminary Needs Assessment	\$
Final Report	\$
Sub-total Cost	\$

## Fire Headquarters

Investigation, Survey and Documentation	\$
Preliminary Needs Assessment	\$
Final Report	\$
Sub-Total Cost	\$
Highway Garage	
Investigation, Survey and Documentation	\$
Preliminary Needs Assessment	\$
Final Report	\$
Sub-total Cost	\$
Fire Station No. 2	
Investigation, Survey and Documentation	\$
Preliminary Needs Assessment	\$
Final Report	\$
Sub-total Cost	\$

## **Merwin Meadows Restroom Facility**

Investigation, Survey and Documentation	\$
Preliminary Needs Assessment	\$
Final Report	\$
Sub-total Cost	\$
Merwin Meadows Barn	
Investigation, Survey and Documentation	\$
Preliminary Needs Assessment	\$
Final Report	\$
Sub-total Cost	\$
Comstock Community Center	
Investigation, Survey and Documentation	\$
Preliminary Needs Assessment	\$
Final Report	\$
Sub-total Cost	\$

## **Veteran's Memorial Stadium Restroom and Concession Stand**

Investigation, Survey and Documentation	\$
Preliminary Needs Assessment	\$
Final Report	\$
Sub-total Cost	\$
Veteran's Memorial Stadium Team Rooms an	d Press Box
Investigation, Survey and Documentation	\$
Preliminary Needs Assessment	\$
Final Report	\$
Sub-total Cost	\$
<b>Town Hall Complex Master Plan</b> (Including evaluation of building expansions ar Ambulance Corp)	nd possible relocation of the
Sub-Total Cost	\$
Total Cost	\$
Reimbursables (Not To Exceed)	\$

Acknowledgment of Addenda:		
Addendum No. 1		
Addendum No. 2		
Addendum No. 3		
Addendum No. 4		
Company Name:	Date:	
Address:		
Name of Submitter:	Title:	
Phone:	Email:	
Authorized Signature:	<del></del>	

Facilities Needs Assessment – Town Buildings

RFQ/RFP W-2023-11 Architectural/Engineering Services

Wilton Connecticut

Addendum No. 2

## SOUTH FIELDS - VETERANS MEMORIAL STADIUM

# WILTON ATHLETIC FIELD COMPLEX AT WILTON HIGH SCHOOL

WILTON, CONNECTICUT

5 JUNE 2006 (BID DOCUMENTS)


## GENERAL NOTES

- 1. LOCATIONS OF ALL UTILITIES AND SUBSURFACE STRUCTURES WERE DETERMINED FROM VARIOUS SOURCES AND BY LIMITED OBSERVATIONS MADE IN THE FIELD AND ARE CONSIDERED APPROXIMATE BOTH AS TO SIZE AND LOCATION AND ARE INDICATED ON THESE DRAWINGS TO GIVE THE CONTRACTOR A GENERAL IDEA OF EXISTING CONDITIONS IN THE FIELD. THE CONTRACTOR SHALL CALL 1-800-922-4455 "CALL BEFORE YOU DIG" TWO DAYS BEFORE BEGINNING ANY EXCAVATION AT THE SITE.
- 2. PROTECT EXISTING UTILITIES TO REMAIN FROM DAMAGE. ACTIVE UTILITY LINES DAMAGED DURING CONSTRUCTION SHALL BE REPAIRED OR REPLACED AS DIRECTED BY THE OWNER AT NO ADDITIONAL COST TO THE OWNER. THE CONTRACTOR SHALL FAMILIARIZE HIMSELF WITH ALL SUBSURFACE UTILITIES PRIOR TO THE START OF WORK.
- 3. CONTRACTOR IS RESPONSIBLE FOR ANY DAMAGE DUE TO CONSTRUCTION OPERATIONS WITHIN ANI OUTSIDE OF THE LIMITS OF WORK AS SHOWN ON THE PLANS.
- 4. SILTATION AND EROSION CONTROL MEASURES SHALL BE INSTALLED AS NECESSARY PRIOR TO THE START OF GRADING AND MAINTAINED UNTIL ALL GROUND SURFACES ARE STABILIZED I.E. WITH TURF PAVEMENTS, ETC.
- 5. THE CONTRACTOR SHALL PROVIDE, ERECT AND MAINTAIN BARRICADES, WARNING LIGHTS, SIGNS, ETC., AS REQUIRED FOR THE SAFETY OF PERSONNEL, THE PUBLIC AND OCCUPANTS OF THE FACILITIES AFFECTED BY THE CONTRACTOR'S OPERATIONS. THE CONTRACTOR SHALL MAINTAIN TRAFFIC ACCESS AND EGRESS PATTERNS AS DIRECTED BY OWNER.
- 6. ALL MATERIALS AND METHODS OF CONSTRUCTION SHALL CONFORM TO THE STATE OF CONNECTICUT D.O.T. STANDARD SPECIFICATIONS FOR ROADS, BRIDGES AND INCIDENTAL CONSTRUCTION, FORM 816, LATEST EDITION, UNLESS OTHERWISE SPECIFIED HEREIN.
- 7. THE CONTRACTOR SHALL PROVIDE ALL MATERIALS, LABOR, EQUIPMENT, AND SUPERVISION TO CONSTRUCT THE PROJECT AS SHOWN ON THE DRAWINGS AND AS SPECIFIED HEREIN.
- 8. THE CONTRACTOR SHALL CAREFULLY SAWCUT EXISTING PAVEMENTS PRIOR TO REMOVAL. ALL EXISTING PAVEMENTS AND OTHER AMENITIES THAT MAY INTERFERE WITH THE NEW WORK SHALL BE BROUGHT TO THE ATTENTION OF THE OWNER/OWNER'S REPRESENTATIVE.
- 9. NEW WORK SHALL BLEND SMOOTHLY WITH EXISTING GRADES.
- 10. THE CONTRACTOR SHALL PROMPTLY REMOVE ALL DEBRIS AND EXCAVATED MATERIAL FROM THE SITE AREA.

1. IN ACCORDANCE WITH SECTION 8-3(i) OF THE CONNECTICUT GENERAL STATUTES, ALL WORK IN CONNECTION WITH THIS SITE DEVELOPMENT PLAN SHALL BE COMPLETED WITHIN FIVE (5) YEARS AFTER THE APPROVAL OF THE PLAN. SAID FIVE-YEAR PERIOD SHALL EXPIRE ON MARCH 30, 2011.

2. "FOR CONDITIONS OF APPROVAL FOR SPECIAL PERMIT, SEE WILTON PLANNING AND ZONING RESOLUTION #0306-2P."

ISSUED FOR BIDDING

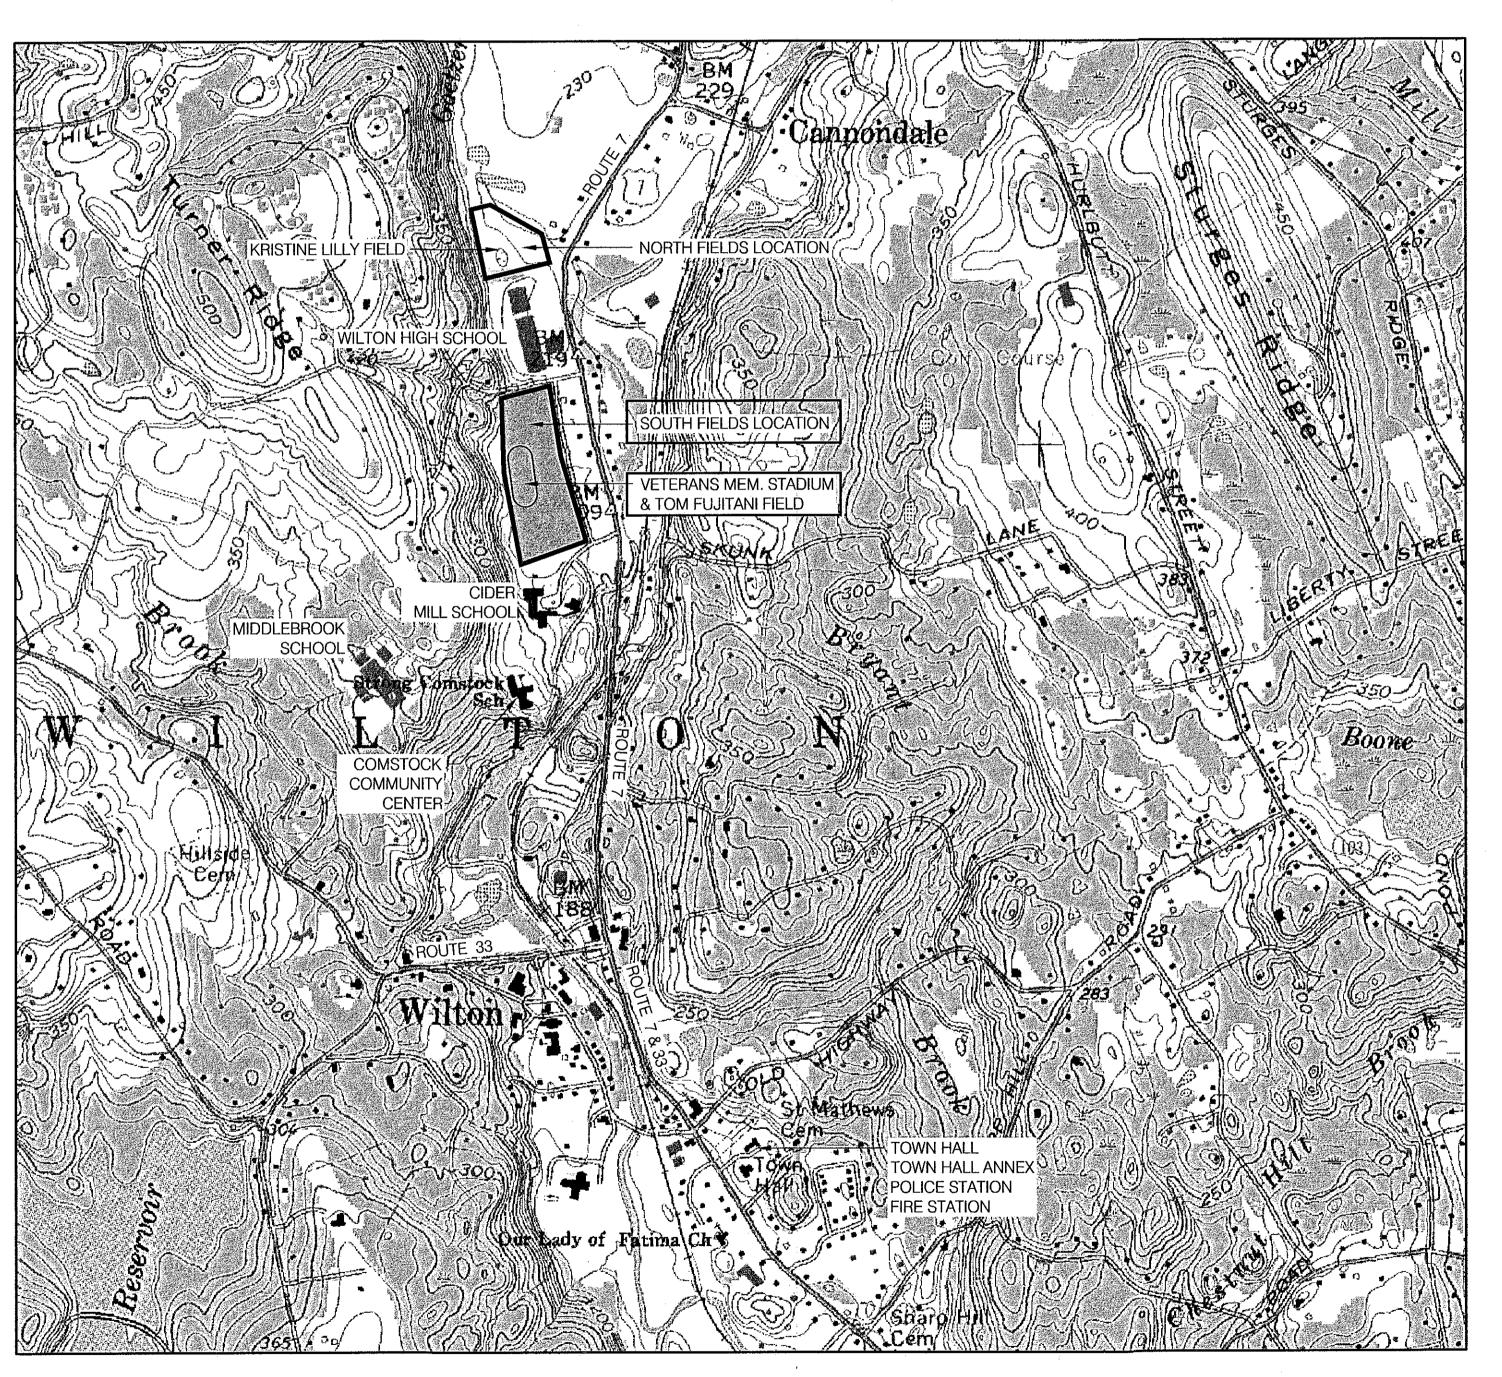


## Site Location Map (Not to Scale)


## **DRAWING LIST:**

C.01 Existing Conditions Construction Phasing Plan Construction Access and Staging Plan Existing Conditions, Removals, Sediment & Erosion Control Plan - 1 Existing Conditions, Removals, Sediment & Erosion Control Plan - 2 South Fields Layout Plan - 1 South Fields Layout Plan - 2 Veterans Memorial Stadium Layout Plan Home-Side Grandstand Enlargement Plan Visitor-Side Grandstand Enlargement Plans Grading, Drainage and Utility Plan -Grading, Drainage and Utility Plan - 2 Grading, Drainage and Utility Plan - 3 **Irrigation Plans - 1** Irrigation Plans - 2 **Irrigation Details** Sediment and Erosion Control Details Varsity & Jr. Varsity Baseball Layout Varsity & Jr. Varsity Softball Layout Baseball & Softball Field Details Backstops and Fencing Details Veterans Memorial Stadium Details-1 Veterans Memorial Stadium Details-2 Veterans Memorial Stadium Details-3 Site Details - 1 L.19 LAND USE APPROVALS Site Details - 2 L.20 Site Details - 3 Home-Side Grandstand Seating Plan (\*) Home-Side Grandstand Foundation Plan Home-Side Grandstand Section (\*) Home-Side Grandstand and Press Box Section (\*) Home-Side Grandstand Press Box Plan, Details & Notes (\*) Visitor-Side Grandstand Seating Plan (\*) ZONING ENFORCEMENT OFFICE Visitor-Side Grandstand Foundation Plan JUL 3 1 2006 Visitor-Side Grandstand Section (\*) Visitor-Side Grandstand End Elevation (\*) Musco Sports Lighting Details - 1 (\*\*) Musco Sports Lighting Details - 2 (\*\*) Musco Sports Lighting Details - 3 (\*\*) Structure General Notes Team Room Foundation Plan Team Room Foundation Details S.02Team Room Framing Plan (Not Included In Contract) S.03Team Room Framing Details (Not Inleuded In Contract) Team Room Building Plan (Not Included In Contract) Team Room Building/Grandstand Elevation (Team Room Not Included In Contract) Blue Storage Building Renovations Softball Press Box and Storage Room Details Softball Press Box Stair Details PREPARED BY: A.06 Softball Press Box Plan, Details & Notes **Dugout Plans & Elevations** Indicates drawings that are included for installation coordination purposes with **VOLLMER** ASSOCIATES LLP grandstand installation by separate Town 2321 Whitney Avenue Contractor. Hamden, CT 06518-3510 Indicates drawings that are included for installation coordination purposes with Tel: 203.281.1350 electrical and sports lighting installation Fax: 203.281.1470

by separate Town Contractor.

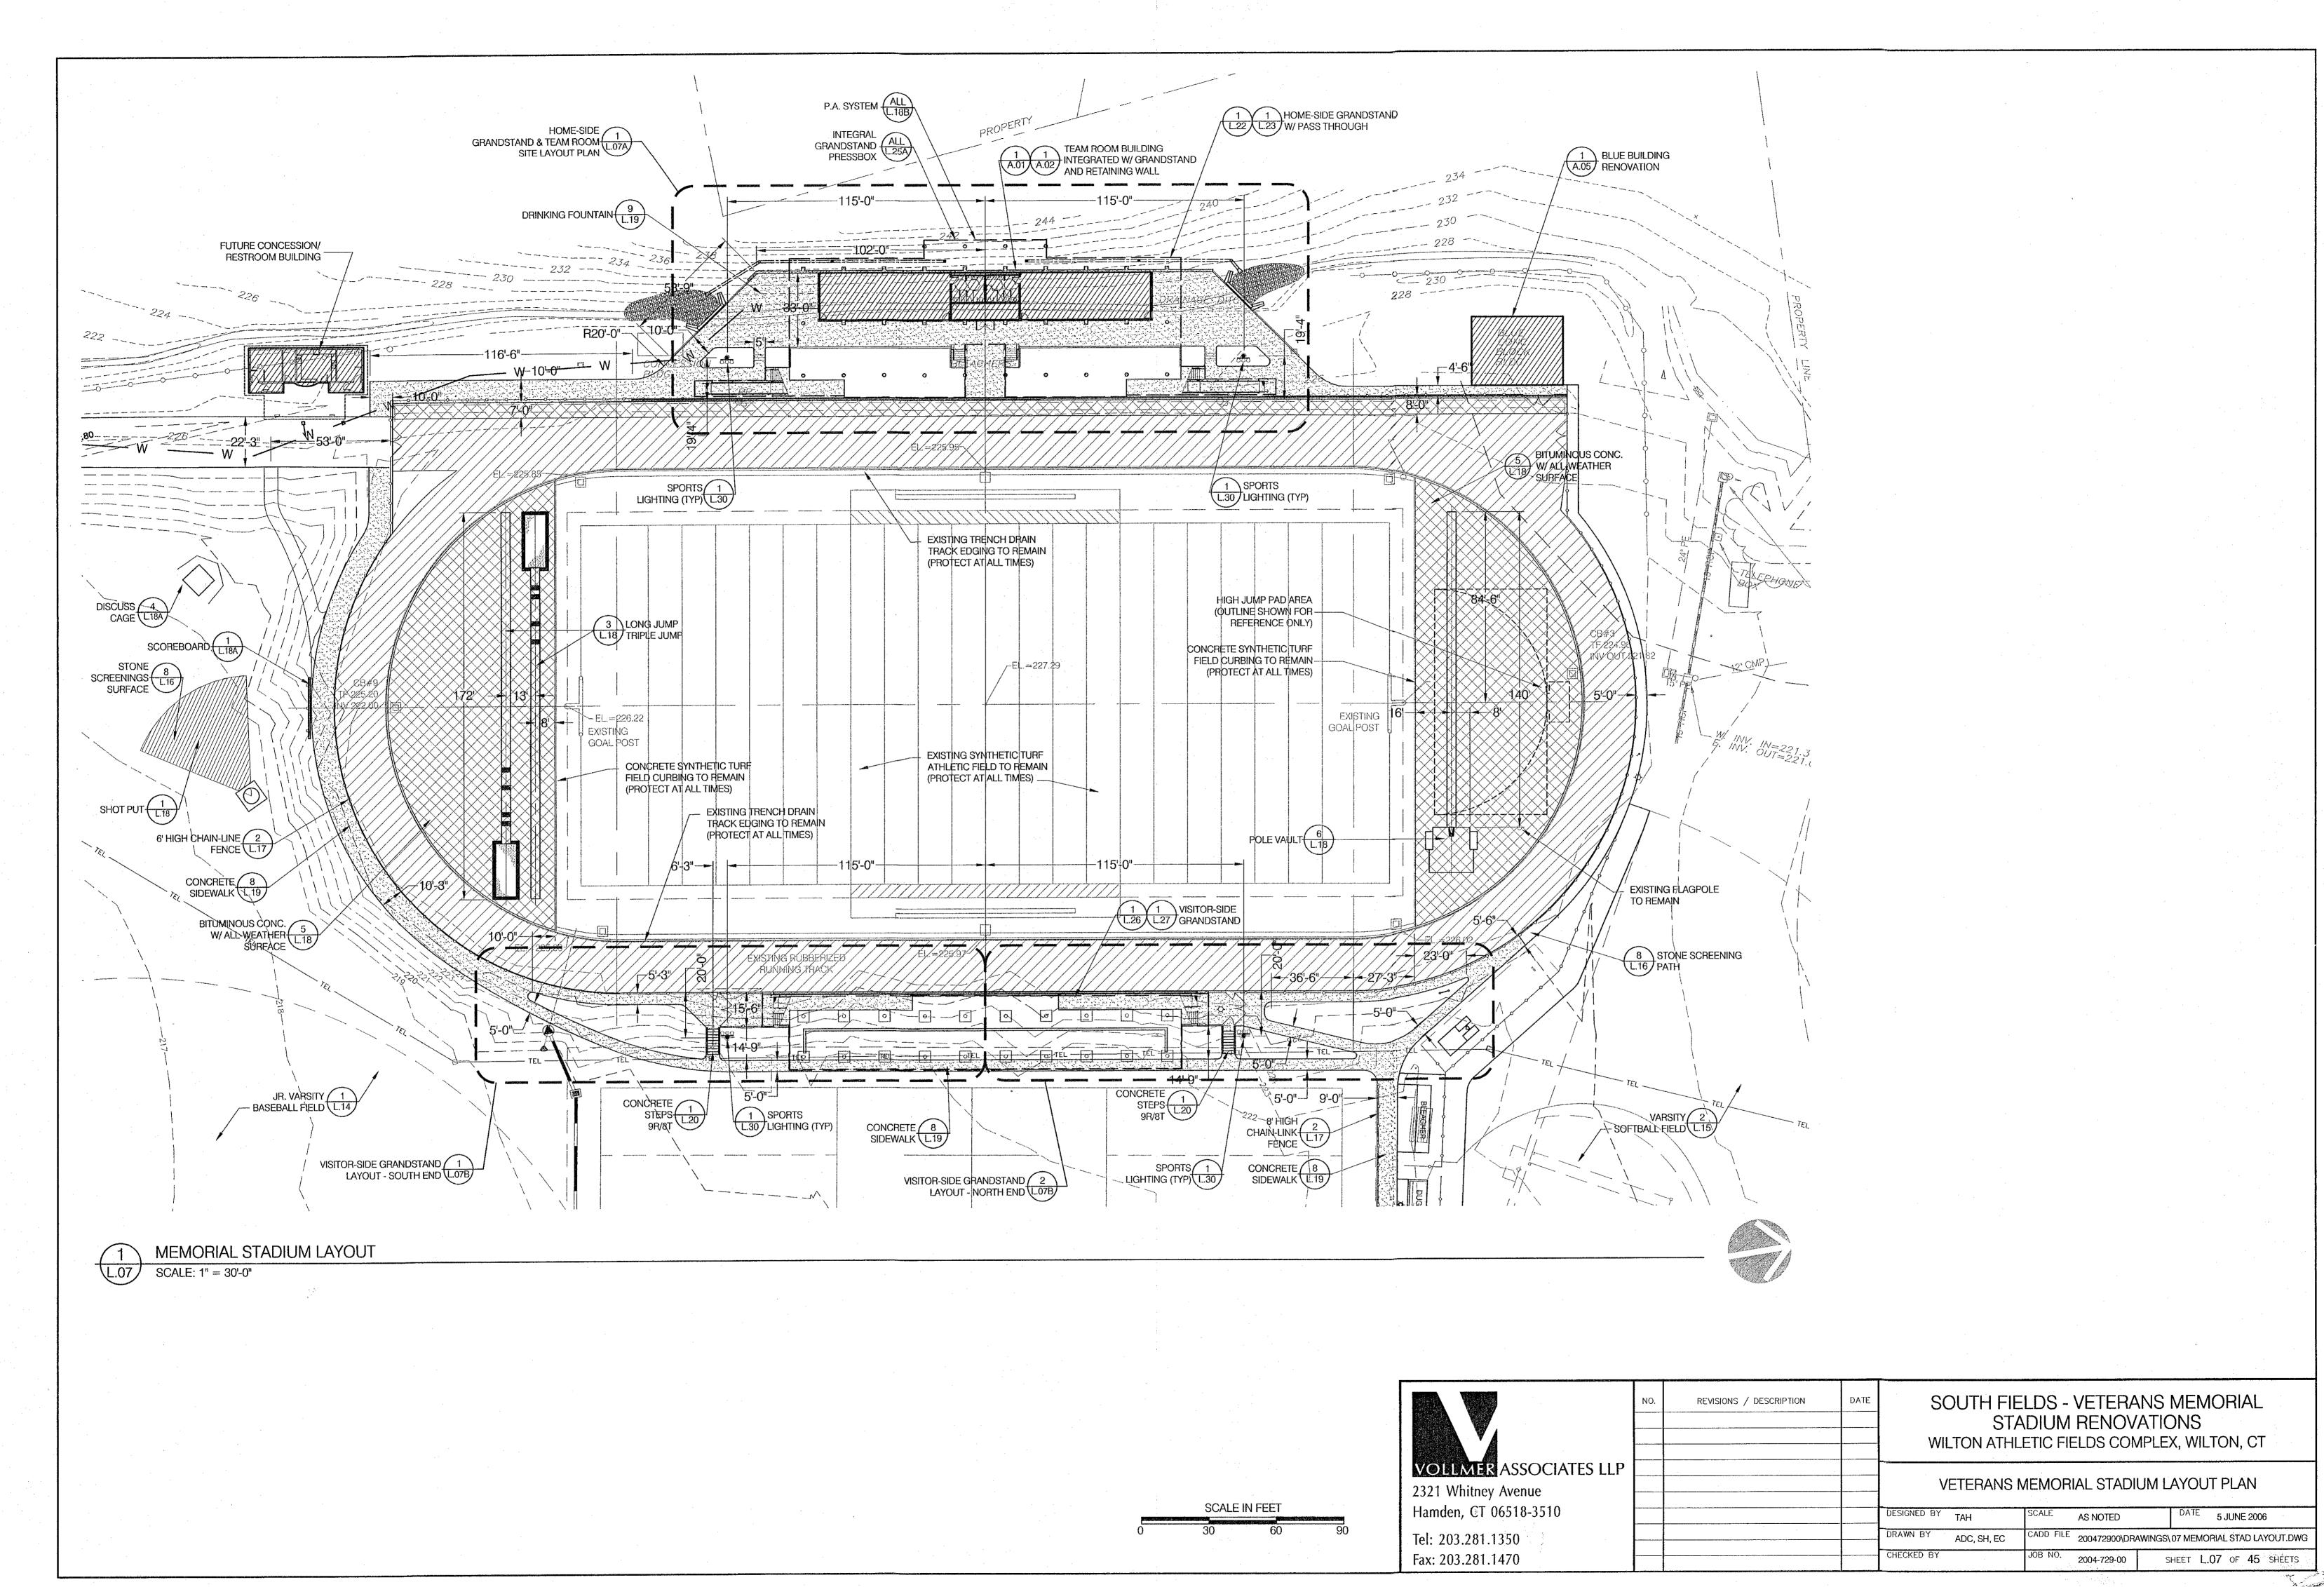

 $\widehat{m{x}}_{2}$ 

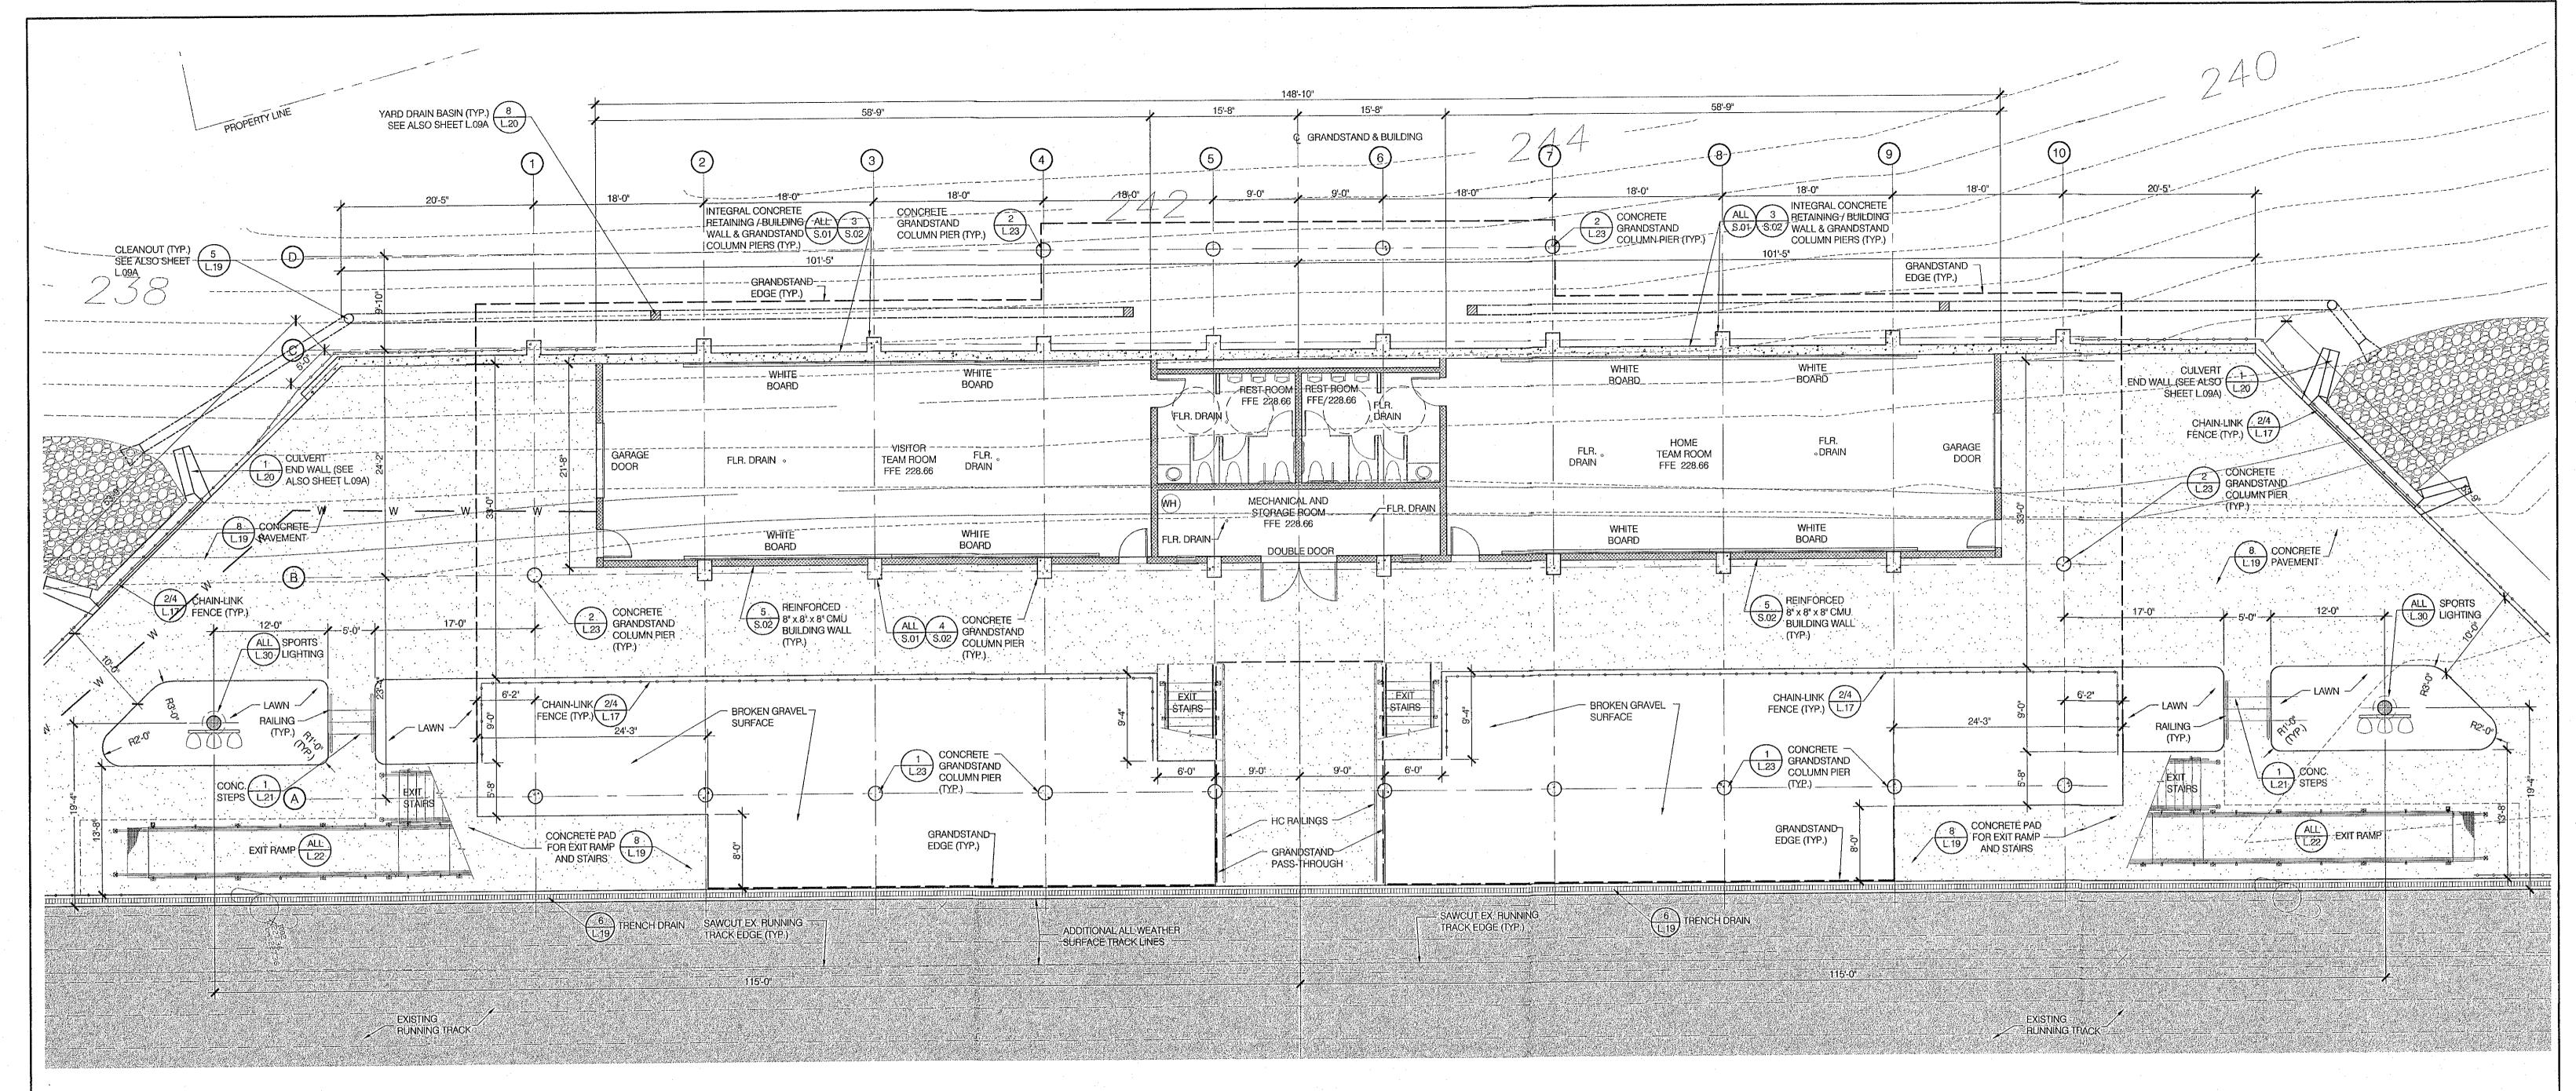

HOME-SIDE GRANDSTAND AND TEAM ROOM SITE LAYOUT PLAN

SCALE: 1/8" = 1'-0"

NOTES

 SEE SHEETS S.01 & S.02 FOR TEAM ROOM BUILDING & GRANDSTAND FOUNDATION PLAN AND DETAILS.

- 2. SEE SHEETS S.03 & S.04 FOR TEAM ROOM BUILDING FRAMING PLAN AND DETAILS.
- 3. SEE SHEETS L.22 & L.23 FOR GRANDSTAND LAYOUT & FRAMING PLANS SEE SHEETS L.24 & L.25 FOR GRANDSTAND FRAMING DETAILS. (GRANDSTAND FOUNDATION WORK IS INCLUDED IN THIS CONTRACT. OTHER GRANDSTAND INSTALLATION WORK IS NOT INCLUDED IN THIS CONTRACT, EXCEPT TO COORDINATE THE INSTALLATION OF THE GRANDSTANDS WITH THE CONTRACTOR'S OWN WORK)

ZONING ENFORCEMENT OFFICE

JUL 3 1 2006

200472900\DRAWINGS\DETAILS\13050-TEAMROOMS-REV.DWG


			in and the second second
	NO.	REVISIONS / DESCRIPTION	DAT
VOLLMER ASSOCIATES LLP			
2321 Whitney Avenue			
Hamden, CT 06518-3510			
Tel: 203.281.1350			

Fax: 203.281.1470

SOUTH FIELDS - VETERANS MEMORIAL STADIUM RENOVATIONS WILTON ATHLETIC FIELDS COMPLEX, WILTON, CT

HOME-SIDE GRANDSTAND ENLARGEMENT PLAN

DESIGNED BY	DB, TAH	SCALE	AS NOTED	DATE	5 JUNE 2006
 DRAWN BY	DB	CADD FILE	200472900\DRA	OME-SIDE LAYOUT.DWG	
CHECKED BY	ME	JOB NO.	2004-729-00	SHEET L	.07A of 45 SHEETS

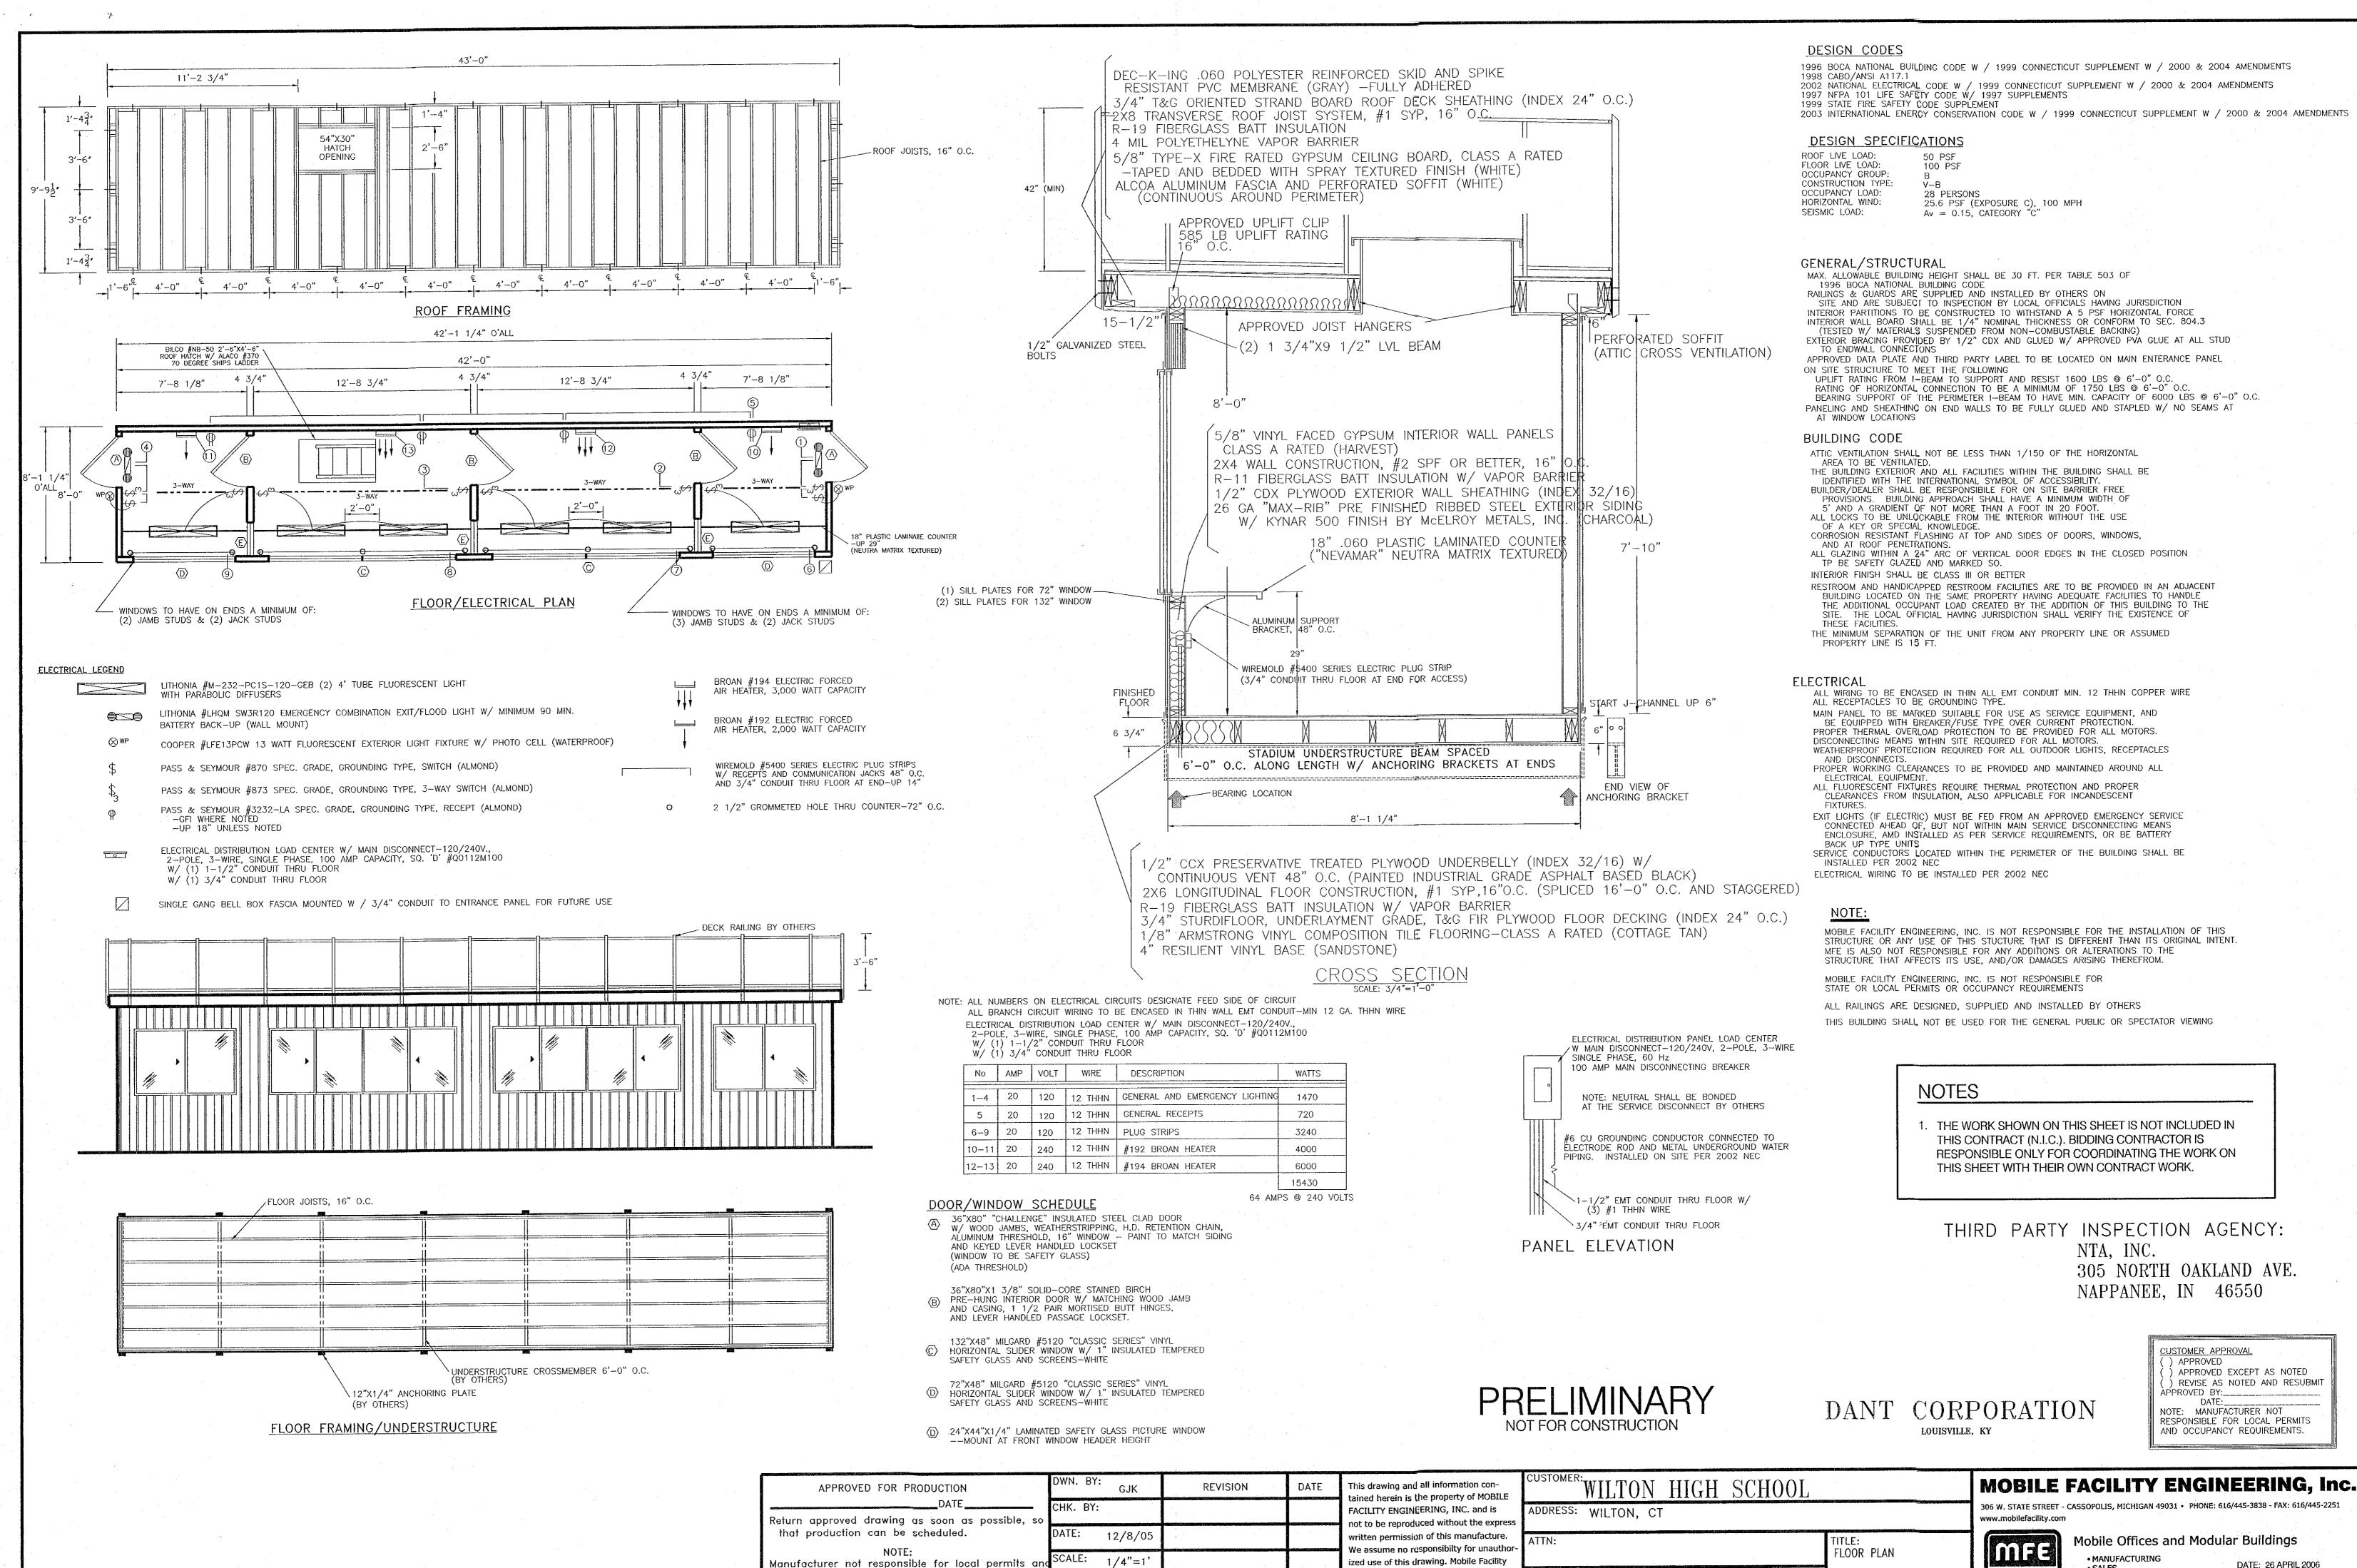

DWG. NO: MF280-05

Engineering is not responsible for local

permits and occupancy requirements.

PROJECT:

842 PRESSBOX

occupancy requirements.

\* 6


a and

DATE: 26 APRIL 2006 SHEET L.25A OF 45 SHEETS

SINCE 1962

SHT #1

SALES LEASING

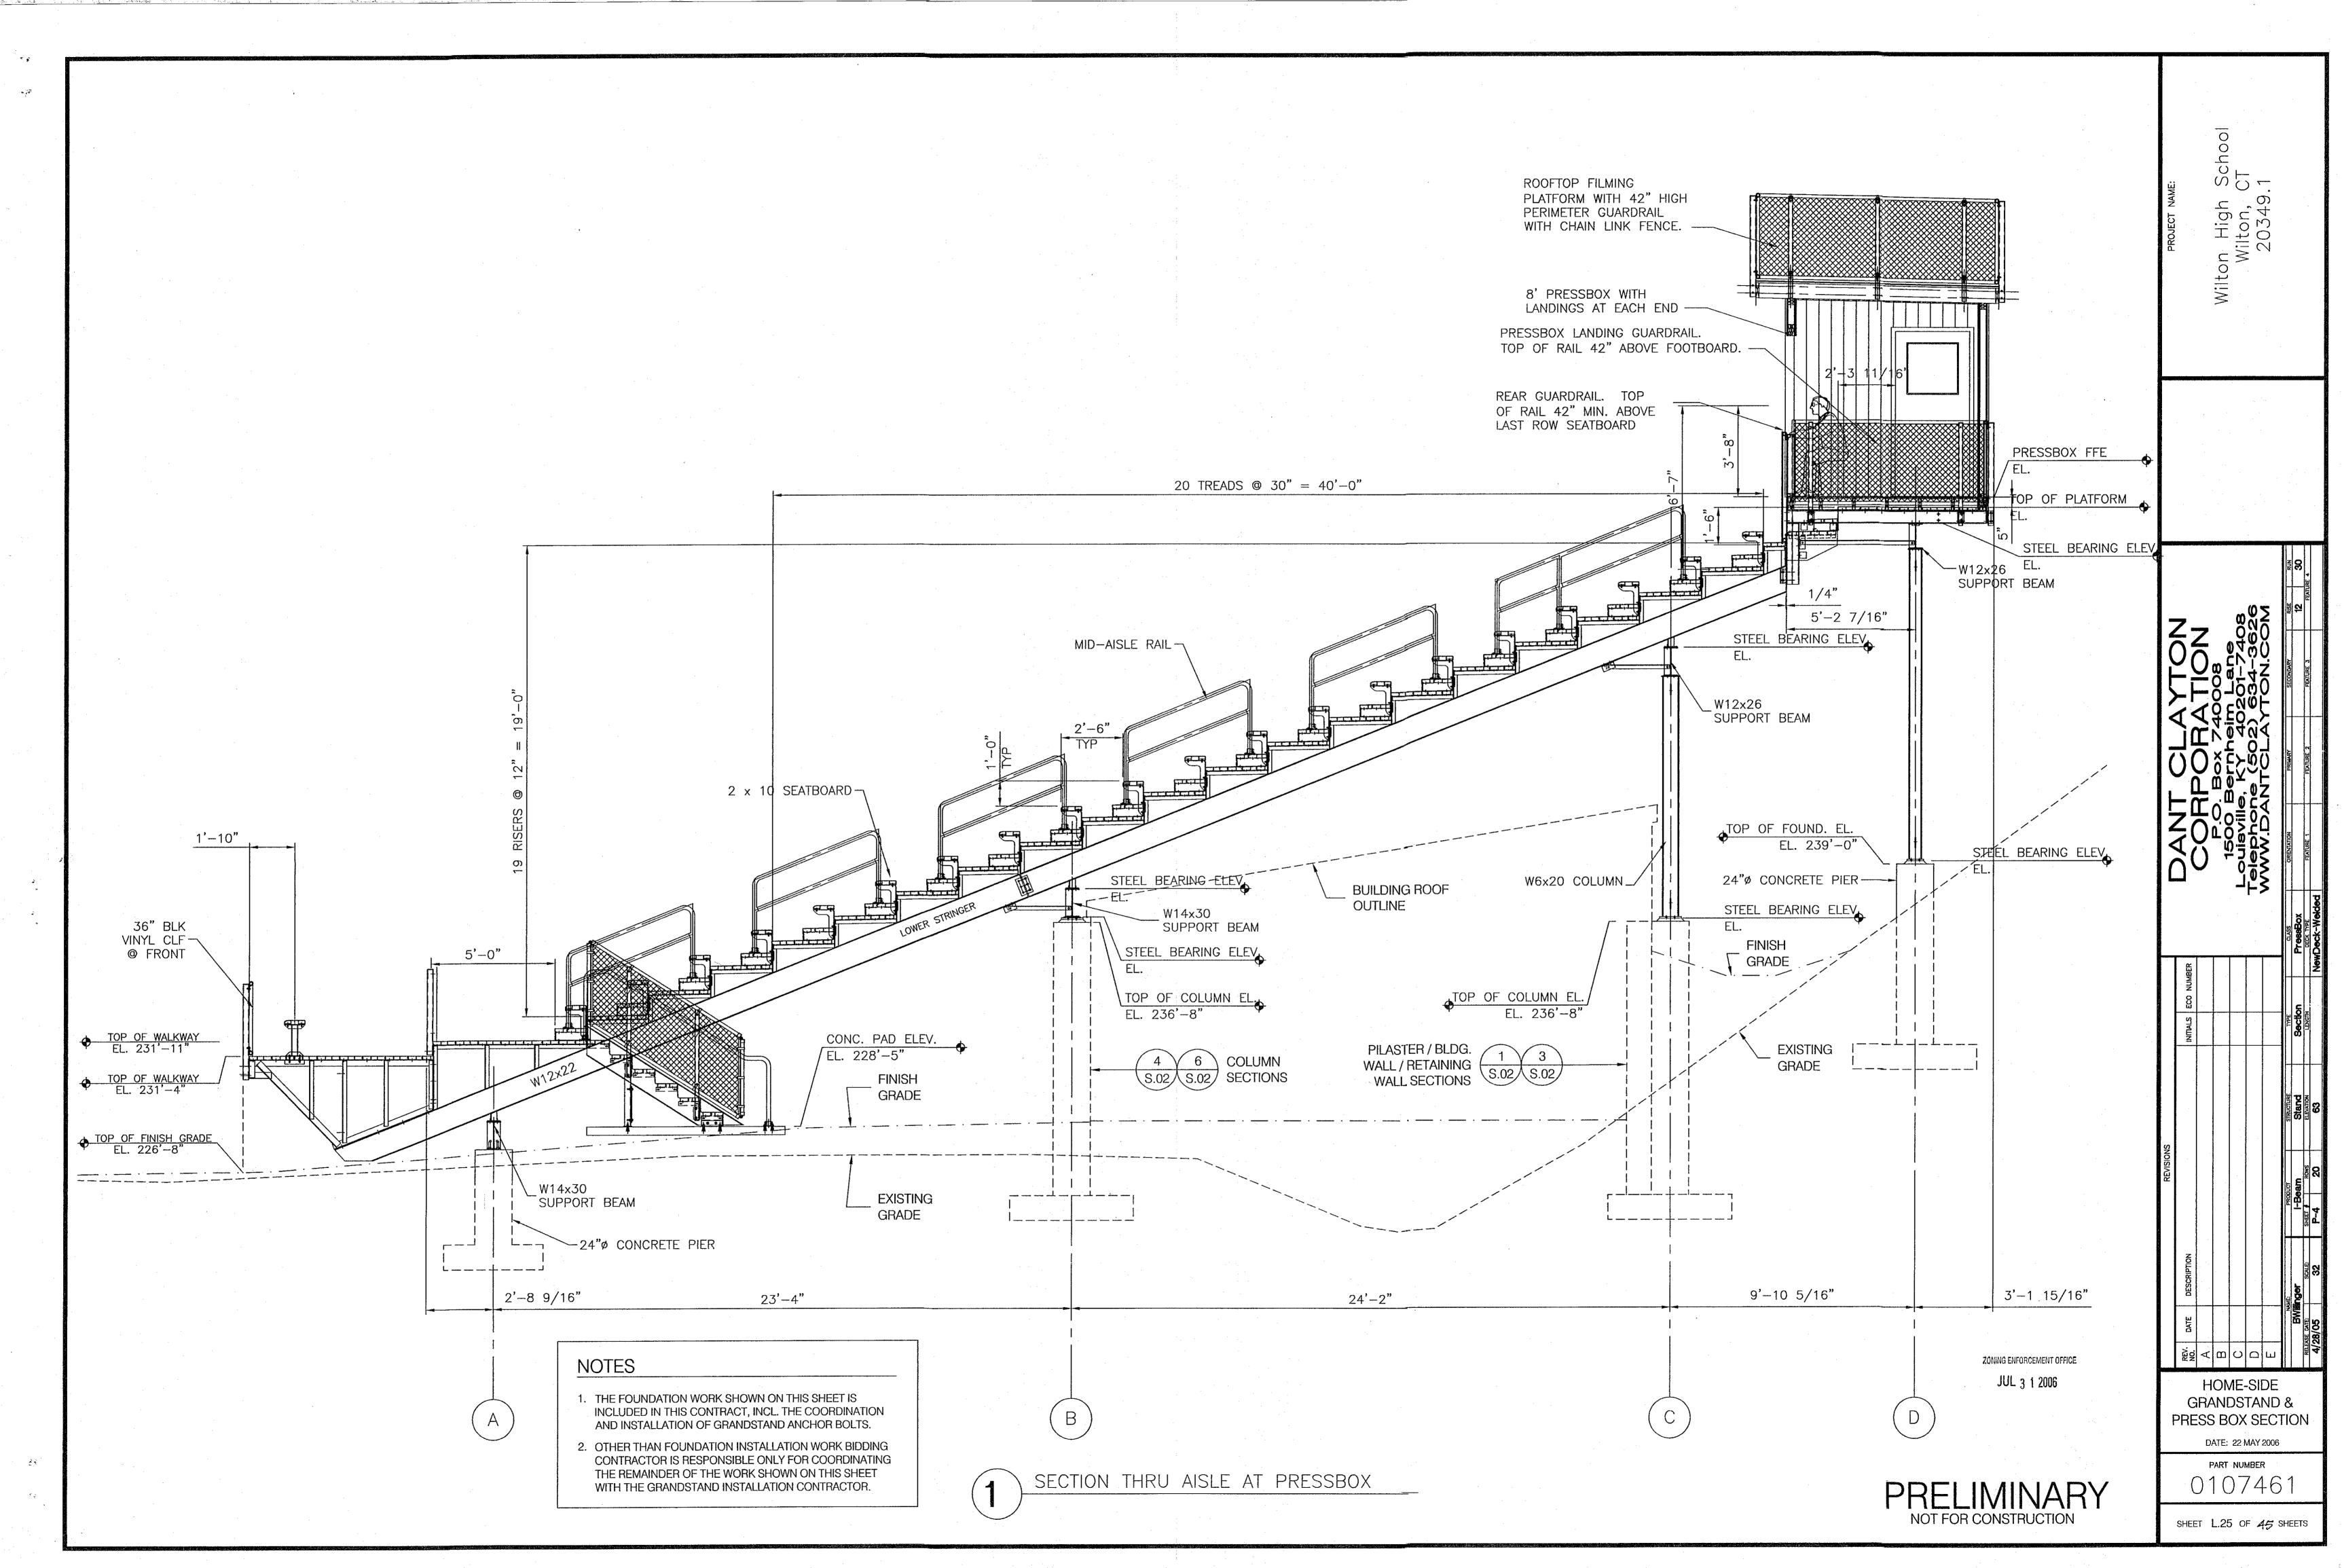

## STRUCTURAL GENERAL NOTES

1. GOVERNING CODE: STATE OF CONNECTICUT BUIDING CODE (2005)

### **BUILDING DESIGN LOADS**

1. DESIGN LIVE LOADS

FLOOR: 100 PSF

2. SNOW LOADS

GROUND SNOW LOAD: 30 PSF SNOW EXPOSURE CATAGORY: C SNOW EXPOSURE FACTOR: 1.0

## 3. WIND LOADS

BASIC WIND SPEED = 100 MPH WIND LOAD IMPORTANCE FACTOR = 1.00 WIND EXPOSURE CATEGORY: C SIMPLIFIED DESIGN WIND PRESSURE (Ps) = 23.11 PSF

### 4. SEISMIC LOADS

SITE CLASS "D" SPECTRAL RESPONSE ACCELERATION (Ss) = 0.367 SPECTRAL RESPONS 1-SECOND PERIOD (S1) = 0.090 SITE COEFFICIENT (Fa) = 1.51 SITE COEFFICIENT (Fv) = 2.4MAX SHORT PERIOD RESPONSE (Sms) = 0.554 MAX 1-SECOND RESPONSE (Sm1) = 0.216SEISMIC USE GROUP II SEISMIC DESIGN CATAGORY C

## CONSTRUCTION

1. REPRODUCTION OF THE CONTRACT DRAWINGS FOR RESUBMITTAL AS SHOP DRAWINGS WILL NOT BE PERMITTED, AND WILL BE REJECTED AND RETURNED.

2. SHOP DRAWINGS SHALL BEAR THE CONTRACTOR'S STAMP OF APPROVAL, WHICH SHALL CONSTITUTE CERTIFICATION THAT THE CONTRACTOR HAS VERIFIED ALL FIELD MEASUREMENTS, CONSTRUCTION CRITERIA, MATERIALS, AND SIMILAR DATA, AND HAS CHECKED EACH DRAWING FOR COMPLETENESS, COORDINATION AND COMPLIANCE WITH THE CONTRACT.

3. IT IS THE CONTRACTOR'S RESPONSIBILITY TO DETERMINE ALLOWABLE CONSTRUCTION LOADS AND TO PROVIDE PROPERLY DESIGNED FORMWORK, STAGINGS, BRACING, SHEETING, SHORING,

4. IMPLEMENTING JOB SAFETY, CONSTRUCTION PROCEDURES, AND TEMPORARY SHORING ARE THE SOLE RESPONSIBILITY OF THE CONTRACTOR.

5. THE CONTRACTOR SHALL REFER TO ARCHITECTURAL, MECHANICAL, PLUMBING, AND ELECTRICAL DRAWINGS FOR SIZE AND LOCATION OF OPENINGS, SLEEVES, AND OTHER INTERDISCIPLINARY COORDINATION ITEMS.

6. IN THE EVENT OF A CONFLICT BETWEEN GENERAL NOTES, DETAILS, AND SPECIFICATIONS, THE MOST RIGID REQUIREMENT SHALL APPLY.

7. THE OWNER WILL ENGAGE A TESTING AGENCY AND A SPECIAL INSPECTOR TO PROVIDE SERVICES AS INDICATED ON THE STATEMENT OF SPECIAL INSPECTIONS.

## **FOUNDATIONS AND GEOTECHNICAL**

1. THE FOUNDATIONS ARE DESIGNED IN ACCORDANCE WITH THE RECOMMENDATIONS SET FORTH IN THE "GEOTECHNICAL ENGINEERING REPORT, PROPOSED STADIUM SEATING, WILTON HIGH SCHOOL, 395 DANBURY ROAD, WILTON, CONNECTICUT" DATED AUGUST 8, 2005, PREPARED BY SOILTESTING, INC., OXFORD, CT.

2. ALL REQUIREMENTS SPECIFIED IN THE AUGUST 8, 2005 REPORT, INCLUDING SUPPLEMENT NO. 1, BY SOILTESTING, INC, APPLY AND ARE CONSIDERED PART OF THIS WORK.

3. REMOVE TOPSOIL, SAND FILL AND ORGANIC SILT FROM THE ENTIRE STRUCTURE FOUNDATION

4. COMPACTED SELECT FILL SHALL BE USED TO BACKFILL TO FOOTING SUBGRADE LEVELS WHERE THE REMOVAL EXCAVATION IS DEEPER THAN THE SUBGRADE.

5. ASSUMED SOIL BEARING CAPACITY OF FOUR THOUSAND (4,000) POUNDS PER SQUARE FOOT (PSF) TO BE VERIFIED IN THE FIELD BY A GEOTECHNICAL ENGINEER.

6. FILL REQUIRED TO ESTABLISH SLAB SUBGRADES SHALL BE COMPACTED SELECT FILL.

7. ALL FOOTINGS SHALL BEAR ON UNDISTURBED SOILS, OR COMPACTED SELECT FILL PLACED AFTER THE REMOVAL OF ANY EXISTING FILLS AND ORGANIC SOILS.

8. BACKFILL RETAINING WALL WITH COMPACTED SELECT FILL WITH A WEDGE THAT IS AT LEAST THREE (3) AND TEN (10) FEET OUTBOARD OF THE BOTTOM AND TOP OF THE WALL

9. SELECT FILL SHALL BE WELL GRADED SAND AND GRAVEL, FREE OF DEBRIS AND ORGANIC MATERIAL, WITH A MAXIMUM PARTICLE SIZE OF THREE (3) INCHES, BETWEEN TEN (10) AND SEVENTY (70) PERCENT BY WEIGHT PASSING THE STANDARD NO. 40. SIEVE SIZE AND LESS THAN TWELVE (12) PERCENT PASSING THE NO. 200 SIEVE.

10. SELECT FILL BACKFILL IS TO BE COMPACTED TO A DENSITY OF AT LEAST NINETY(90) PERCENT OF THE MAXIMUM DETERMINED IN THE LABORATORY WHEN TESTED IN ACCORDANCE WITH THE ASTM D1557 STANDARD.

11. DETERMINATION OF UNDISTURBED SOIL LEVELS, REMOVAL REQUIREMENTS OF TOPSOIL, EXISTING FILL SOIL AND ORGANIC SILT, AND SUPPLY AND COMPACTION OF SELECT FILL SHALL BE VERIFIED IN THE FIELD BY A GEOTECHNICAL ENGINEER.

12. DEWATERING OF THE EXCAVATIONS MAY BE REQUIRED. THE CONTRACTOR IS RESPONSIBLE FOR PROVIDING ALL DEWATERING EQUIPMENT AND PROCEDURES. ALL CONCRETE WORK SHALL BE COMPLETED "IN THE DRY".

## METAL ROOF DECKING

1. ALL METAL DECK SHALL BE MANUFACTURED AND ERECTED IN ACCORDANCE WITH THE LATEST EDITION OF THE "DESIGN MANUAL FOR COMPOSITE DECKS, FORM DECKS AND ROOF DECKS" BY THE STEEL DECK INSTITUTE (SDI).

2. ALL ROOF DECKING SHALL BE 1.5B20 DECK BY VULCRAFT OR EQUAL, (MIN Ix = 0.212 IN ^ 4 / FT AND Sp = 0.234 IN ^3 / FT) SPANNING PERPENDICULAR TO SUPPORTS. CONNECT WITH 5" DIA. PUDDLE WELDS AND MECHANICALLY FASTENED SIDELAPS.

3. ALL METAL DECK WELDING SHALL BE IN ACCORDANCE WITH AMERICAN WELDING SOCIETY SPECIFICATION D1 .3.

4. ALL ROOF DECKING SHALL BE PAINTED. ALL DECK WELDS SHALL BE TOUCHED UP WITH PAINT (GALVANIZING REPAIR PAINT FOR GALVANIZED DECKS).

5. SUBMIT DETAILED SHOP DRAWINGS PRIOR TO FABRICATION SHOWING LAYOUT, TYPES OF METAL DECK UNITS, CONNECTION DETAILS, ACCESSORIES AND OTHER RELATED ITEMS.

6. ROOF DECK SIDELAPS SHALL BE ATTACHED AT ENDS OF CANTILEVERS AND AT A MAXIMUM SPACING OF 12" O.C. FROM CANTILEVERED ROOF DECK ENDS. THE ROOF DECK MUST BE COMPLETELY ATTACHED TO THE SUPPORTS AND AT THE SIDELAPS BEFORE ANY LOAD IS APPLIED TO THE CANTILEVER.

## REINFORCED CONCRETE

1. ALL CONCRETE SHALL CONFORM TO ACI 301, LATEST EDITION "SPECIFICATIONS FOR STRUCTURAL CONCRETE FOR BUILDINGS".

2. ALL CONCRETE SHALL BE NORMAL WEIGHT CONCRETE WITH A 28-DAY COMPRESSIVE STRENGTH (fc) OF 3,000 PSI.

3. ALL CONCRETE SHALL BE AIR ENTRAINED 5%±1%.

4. ALL REINFORCING BARS SHALL BE DEFORMED STEEL BARS IN ACCORDANCE WITH ASTM A615, GRADE 60.

5. DETAIL BARS IN ACCORDANCE WITH "ACI DETAILING MANUAL", LATEST EDITION.

6. THE MINIMUM CONCRETE COVER FOR REINFORCEMENT WHEN NOT OTHERWISE NOTED SHALL BE: -CONCRETE POURED AGAINST EARTH

-CONCRETE POURED IN FORMS BUT EXPOSED TO EARTH OR WEATHER #5 BARS AND SMALLER #6 BARS AND LARGER -SLABS AND WALLS NOT EXPOSED TO

7. NO SPLICES OF REINFORCEMENT SHALL BE MADE EXCEPT AS DETAILED OR APPROVED BY THE ENGINEER. LAP SPLICES, WHERE PERMITTED, SHALL BE A MINIMUM OF 48 BAR DIAMETERS UNLESS OTHERWISE DETAILED. MAKE ALL BARS CONTINUOUS AROUND CORNERS.

8. WIRE MESH SHALL LAP ONE FULL MESH AT SIDE AND END LAPS, AND SHALL BE WIRED TOGETHER. PROVIDE ADEQUATE SUPPORTS FOR MESH TO ENSURE ITS LOCATION AS SHOWN ON THE DRAWINGS.

EARTH OR WEATHER

1. ALL STRUCTURAL STEEL IS DESIGNED USING AISC ALLOWABLE STRESS DESIGN (ASD) OR LOAD AND RESISTANCE FACTOR DESIGN (LRFD) AND SHALL CONFORM TO ASTM A36 (Fy = 36

2. STRUCTURAL STEEL SHALL BE DETAILED, FABRICATED, AND ERECTED IN ACCORDANCE WITH THE AISC SPECIFICATIONS FOR STRUCTURAL STEEL BUILDINGS, ASD OR LRFD, AND THE AISC CODE OF STANDARD PRACTICE.

3. GRAVITY CONNECTIONS: CONNECTIONS NOT OTHERWISE DETAILED SHALL BE DOUBLE ANGLE FRAMED CONNECTIONS. ALL CONNECTIONS ARE TO BE MADE WITH HIGH STRENGTH BOLTS. CONNECTION MATERIAL TO BE ASTM A36 (Fy = 36 ksi). ALL CONNECTION SHALL BE DESIGNED TO RESIST ONE HALF OF THE MAXIMUM ALLOWABLE UNIFORM LOAD CAPACITY UNLESS OTHERWISE NOTED ON THE DRAWINGS.

4. ALL HIGH STRENTGH BOLTS SHALL CONFORM TO THE CURRENT SPECIFICATIONS FOR STRUCTURAL JOINTS USING ASTM A325 OR A490 BOLTS. ALL CONNECTIONS SHALL BE SNUG TIGHT UNLESS NOTED OTHERWISE.

5. ALL WELDING SHALL CONFORM TO THE REQUIREMENTS OF THE AMERICAN WELDING SOCIETY (AWS) STRUCTURAL WELDING CODE - STEEL D1.1, LATEST EDITION. USE E70xx ELECTRODES UNLESS NOTED OTHERWISE.

6. SHOP DRAWINGS AND CALCULATIONS SHALL BE SUBMITTED TO THE ENGINEER AND SHALL BEAR THE SEAL OF A PROFESSIONAL ENGINEER LICENSED TO PRACTICE IN THE STATE OF CONNECTICUT. CALCULATIONS FOR FOR EACH TYPE OF CONNECTION SHALL BE INCLUDED.

7. THE CONTRACTOR SHALL NOTIFY THE ENGINEER OF ANY FABRICATION OR ERECTION ERRORS OR DEVIATIONS AND RECEIVE WRITTEN APPROVAL BEFORE ANY FIELD CORRECTIONS ARE MADE.

## DIMENSIONS

1. THE CONTRACTOR SHALL COORDINATE THE DIMENSIONS OF THE ROOF, FLOOR AND WALL OPENINGS SO THE FRAMING PROPERLY FITS THE REQUIREMENTS OF ALL TRADES.

2. THE CONTRACTOR SHALL VERIFY EXISTING CONDITIONS AND DIMENSIONS IN THE FIELD, PRIOR TO FABRICATION AND INSTALLATION OF ANY NEW MATERIALS.

1. ALL MASONRY SHALL HAVE A 28-DAY COMPRESSIVE STRENGTH (fm) OF 1,500 PSI.

2. ALL MORTAR SHALL BE TYPE S.

3. FILL ALL VOIDS AND BLOCK CELL SOLIDLY WITH GROUT FOR A DISTANCE OF 24" BENEATH AND 12" EACH SIDE OF ALL BEAM AND OTHER CONCENTRATED LOADS.

4. ALL REINFORCING BARS SHALL CONFORM TO ASTM A615, GRADE 60.

5. ALL REINFORCING BARS SHALL BE FULLY GROUTED IN PLACE.

6. NO SPLICES IN REINFORCEMENT SHALL BE MADE EXCEPT AS DETAILED OR APPROVED BY THE ENGINEER. WHERE PERMITTED, SPLICES SHALL BE A MINIMUM OF 48 BAR DIAMETERS UNLESS OTHERWISE DETAILED.

7. PROVIDE STANDARD 9 GAUGE HORIZONTAL JOINT REINFORCEMENT EVERY OTHER COURSE IN ALL

## DESIGN LOADS FROM BLEACHER TO BUILDING FOUNDATION

BASED ON INFORMATION PROVIDED BY DANT CLAYTON CORPORATION, P.O. BOX 740008, 1500 BERNHEIM LANE, LOUISVILLE, KY 40201-7408, TELEPHONE (502) 634-3626.

## **GENERAL SUMMARY OF LOADS**

1. DEAD LOAD

BLEACHERS: 12 PSF

2. DESIGN LIVE LOADS

FLOOR: 100 PSF

3. LATERAL LOADS

PER ROW (PARALLEL TO SEATS): PER ROW (PERPENDICULAR TO SEATS): 10 PLF

LOADS FOR THIS SYSTEM (PER BLEACHER COLUMN AT BASE)

1. DEAD LOAD

BLEACHERS: 4-6 KIPS MAX. (ASSUMED 7.5 KIPS)

2. LIVE LOADS


BLEACHERS: 40 KIPS MAX. (ASSUMED 50 KIPS)

SWAY LOADS

PARALLEL WITH SEATS (APPLIED AT COLUMN ROWS "C" & "D" ONLY): 8-10 KIPS MAX.

4. WIND LOADS

LATERAL (APPLIED AT COLUMN ROW "A" ONLY): 8-10 KIPS, 14 KIPS MAX VERTICAL UPLIFT (APPLIED AT ROWS "B" & "C" ONLY; NOT INCLUDING DEAD OR LIVE LOADS): 8-10 KIPS

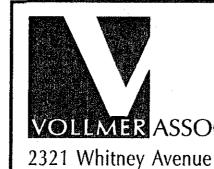

**VOLLMER** ASSOCIATES


Tel: 203.281.1350 Fax: 203.281.1470

Hamden, CT 06518-3510

LLP	NO.	REVISIONS / DESCRIPTION	DATE	SOUTH FIELDS - VETERANS MEMORIAL STADIUM RENOVATIONS WILTON ATHLETIC FIELDS COMPLEX, WILTON, CT
				STRUCTURAL GENERAL NOTES
				DESIGNED BY JMD SCALE AS NOTED DATE 5 JUNE 2006  DRAWN BY JMD CADD FILE 200472900\DRAWINGS\SO1FDN+DETS.DWG


SHEET \$.00 OF 45 SHEETS

2004-729-00

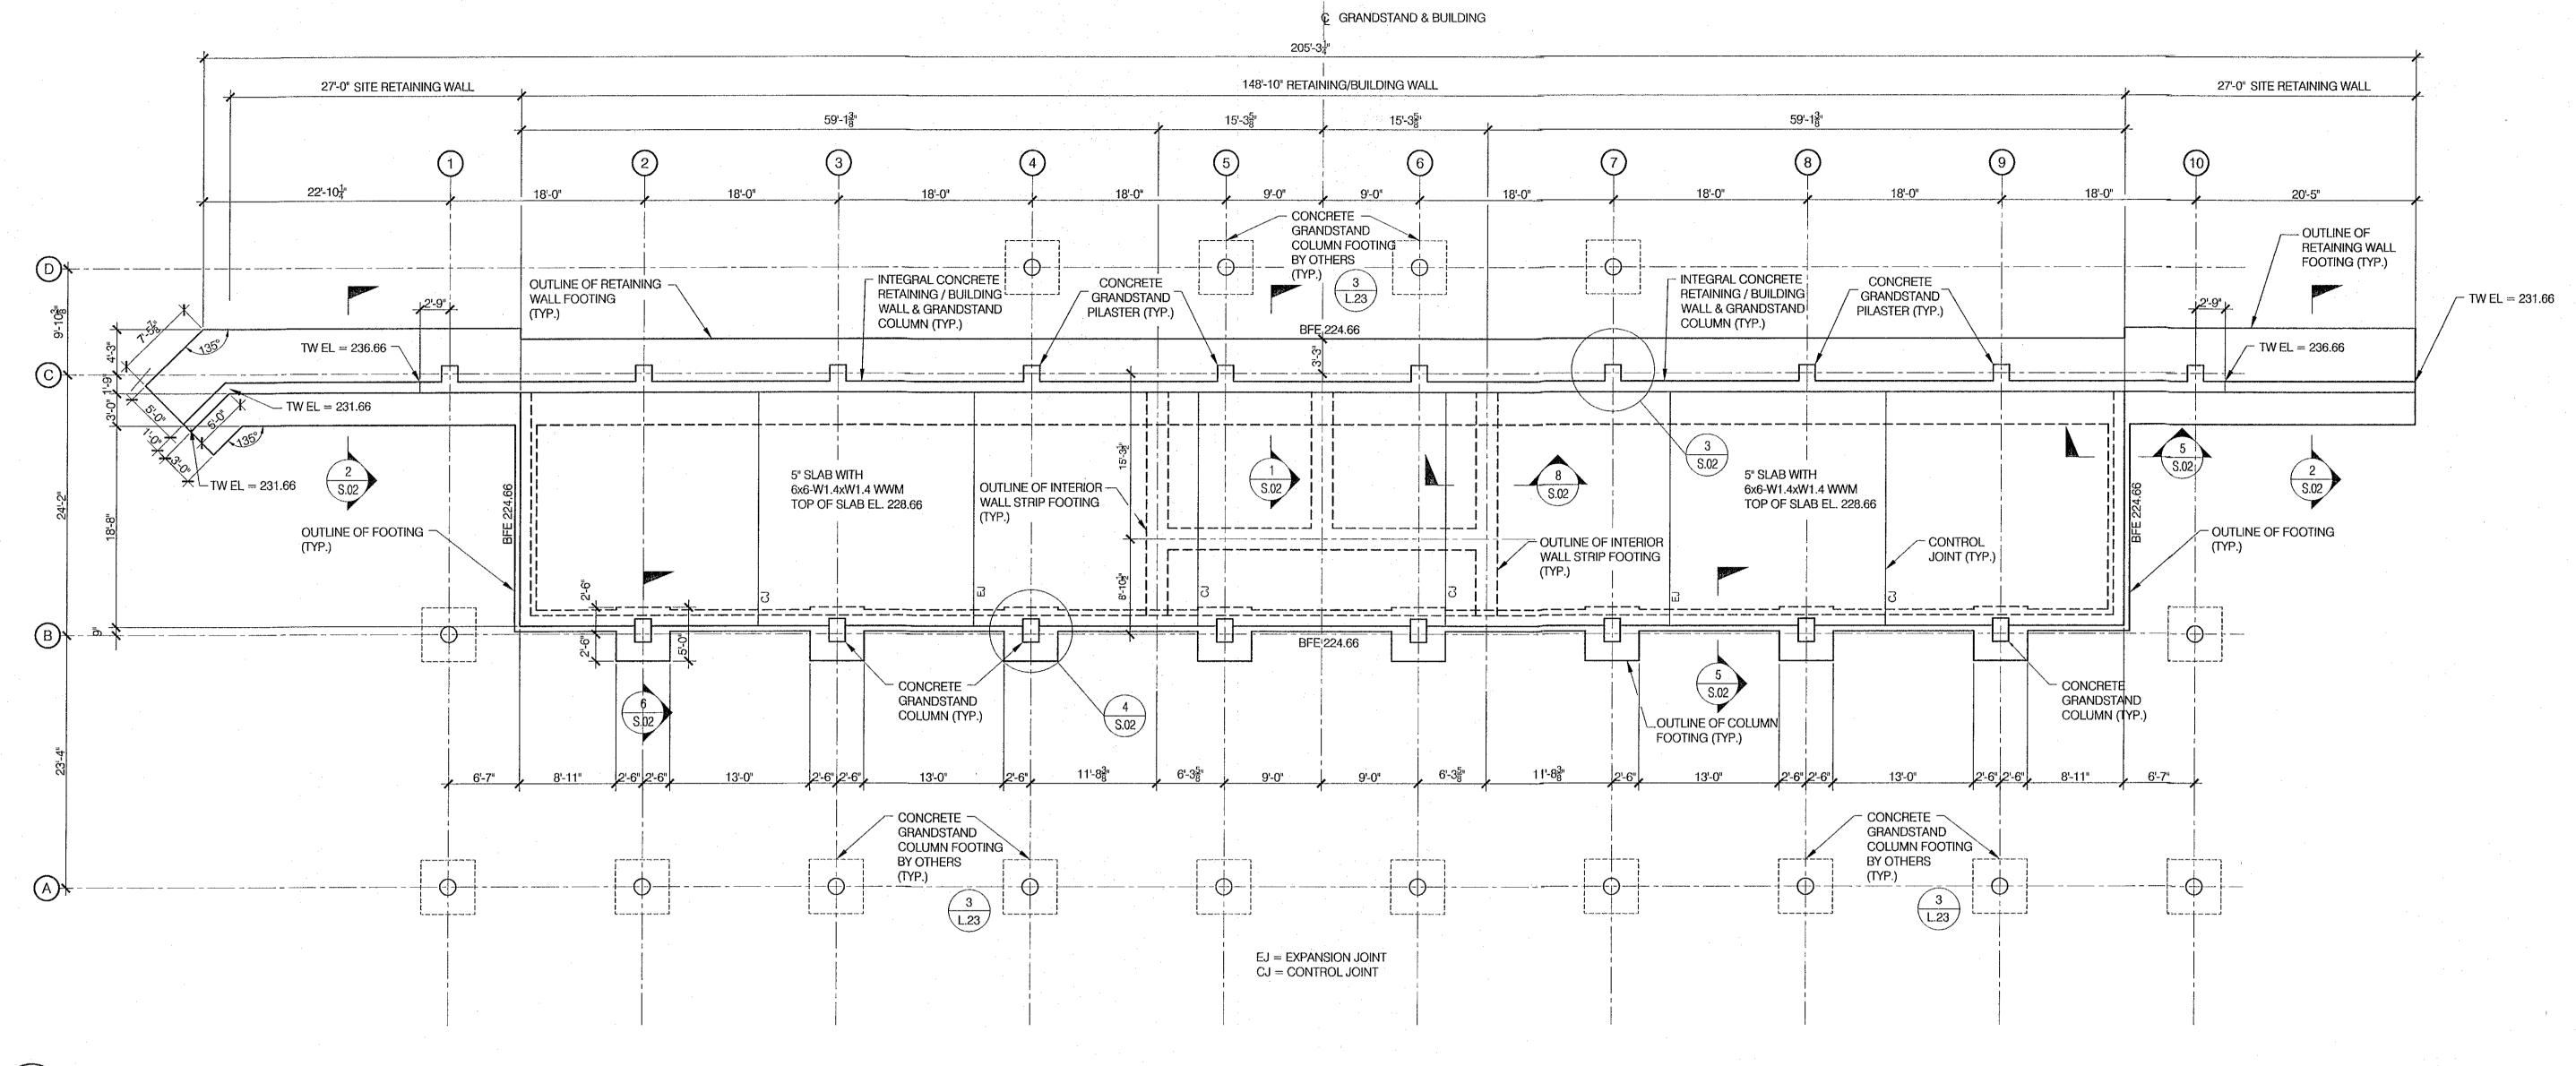

FOUNDATION PLAN
S.01 SCALE: 1/8" = 1'-0"

200472900\DRAWINGS\S01\_STANDS+TEAM ROOMS\_FDN+DETS.DWG

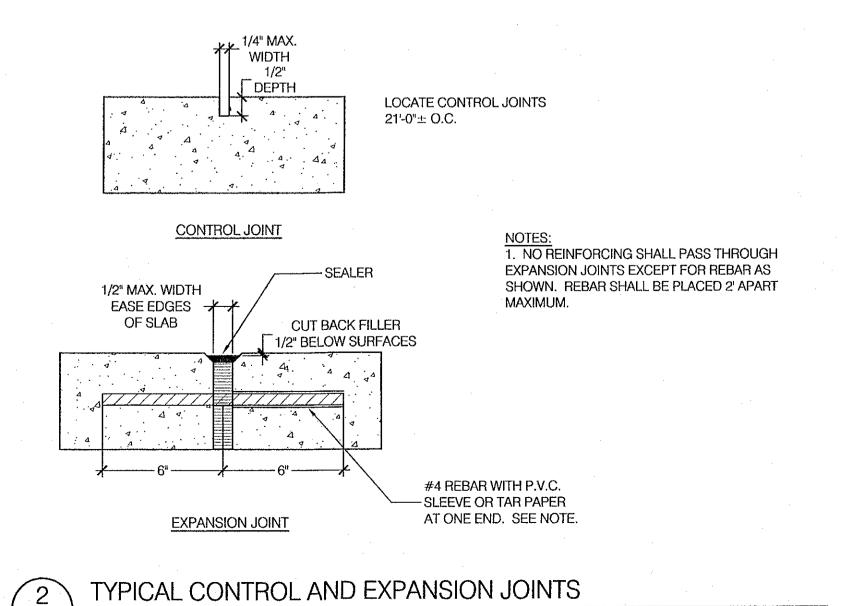

200472900\DRAWINGS\DETAILS\EXP\_JNT2.DWG

NO. REVISIONS / DESCRIPTION DATE

VOLUMER ASSOCIATES LLP
2321 Whitney Avenue
Hamden, CT 06518-3510


DESIGNED BY


Tel: 203.281.1350

Fax: 203.281.1470

SOUTH FIELDS - VETERANS MEMORIAL STADIUM RENOVATIONS WILTON ATHLETIC FIELDS COMPLEX, WILTON, CT

		TEAM	ROOM	FOUNDAT	ION	PLAN	
	DESIGNED BY	JMD	SCALE	AS NOTED		DATE 5 JUNE 2006	
_	DRAWN BY	JMD	CADD FILE	200472900\DRAWINGS\SO1FDN+DETS.DWG			
$\dashv$	CHECKED BY	AML	JOB NO.	2004-729-00	SI	HEET S 01 OF 45 SHEETS	

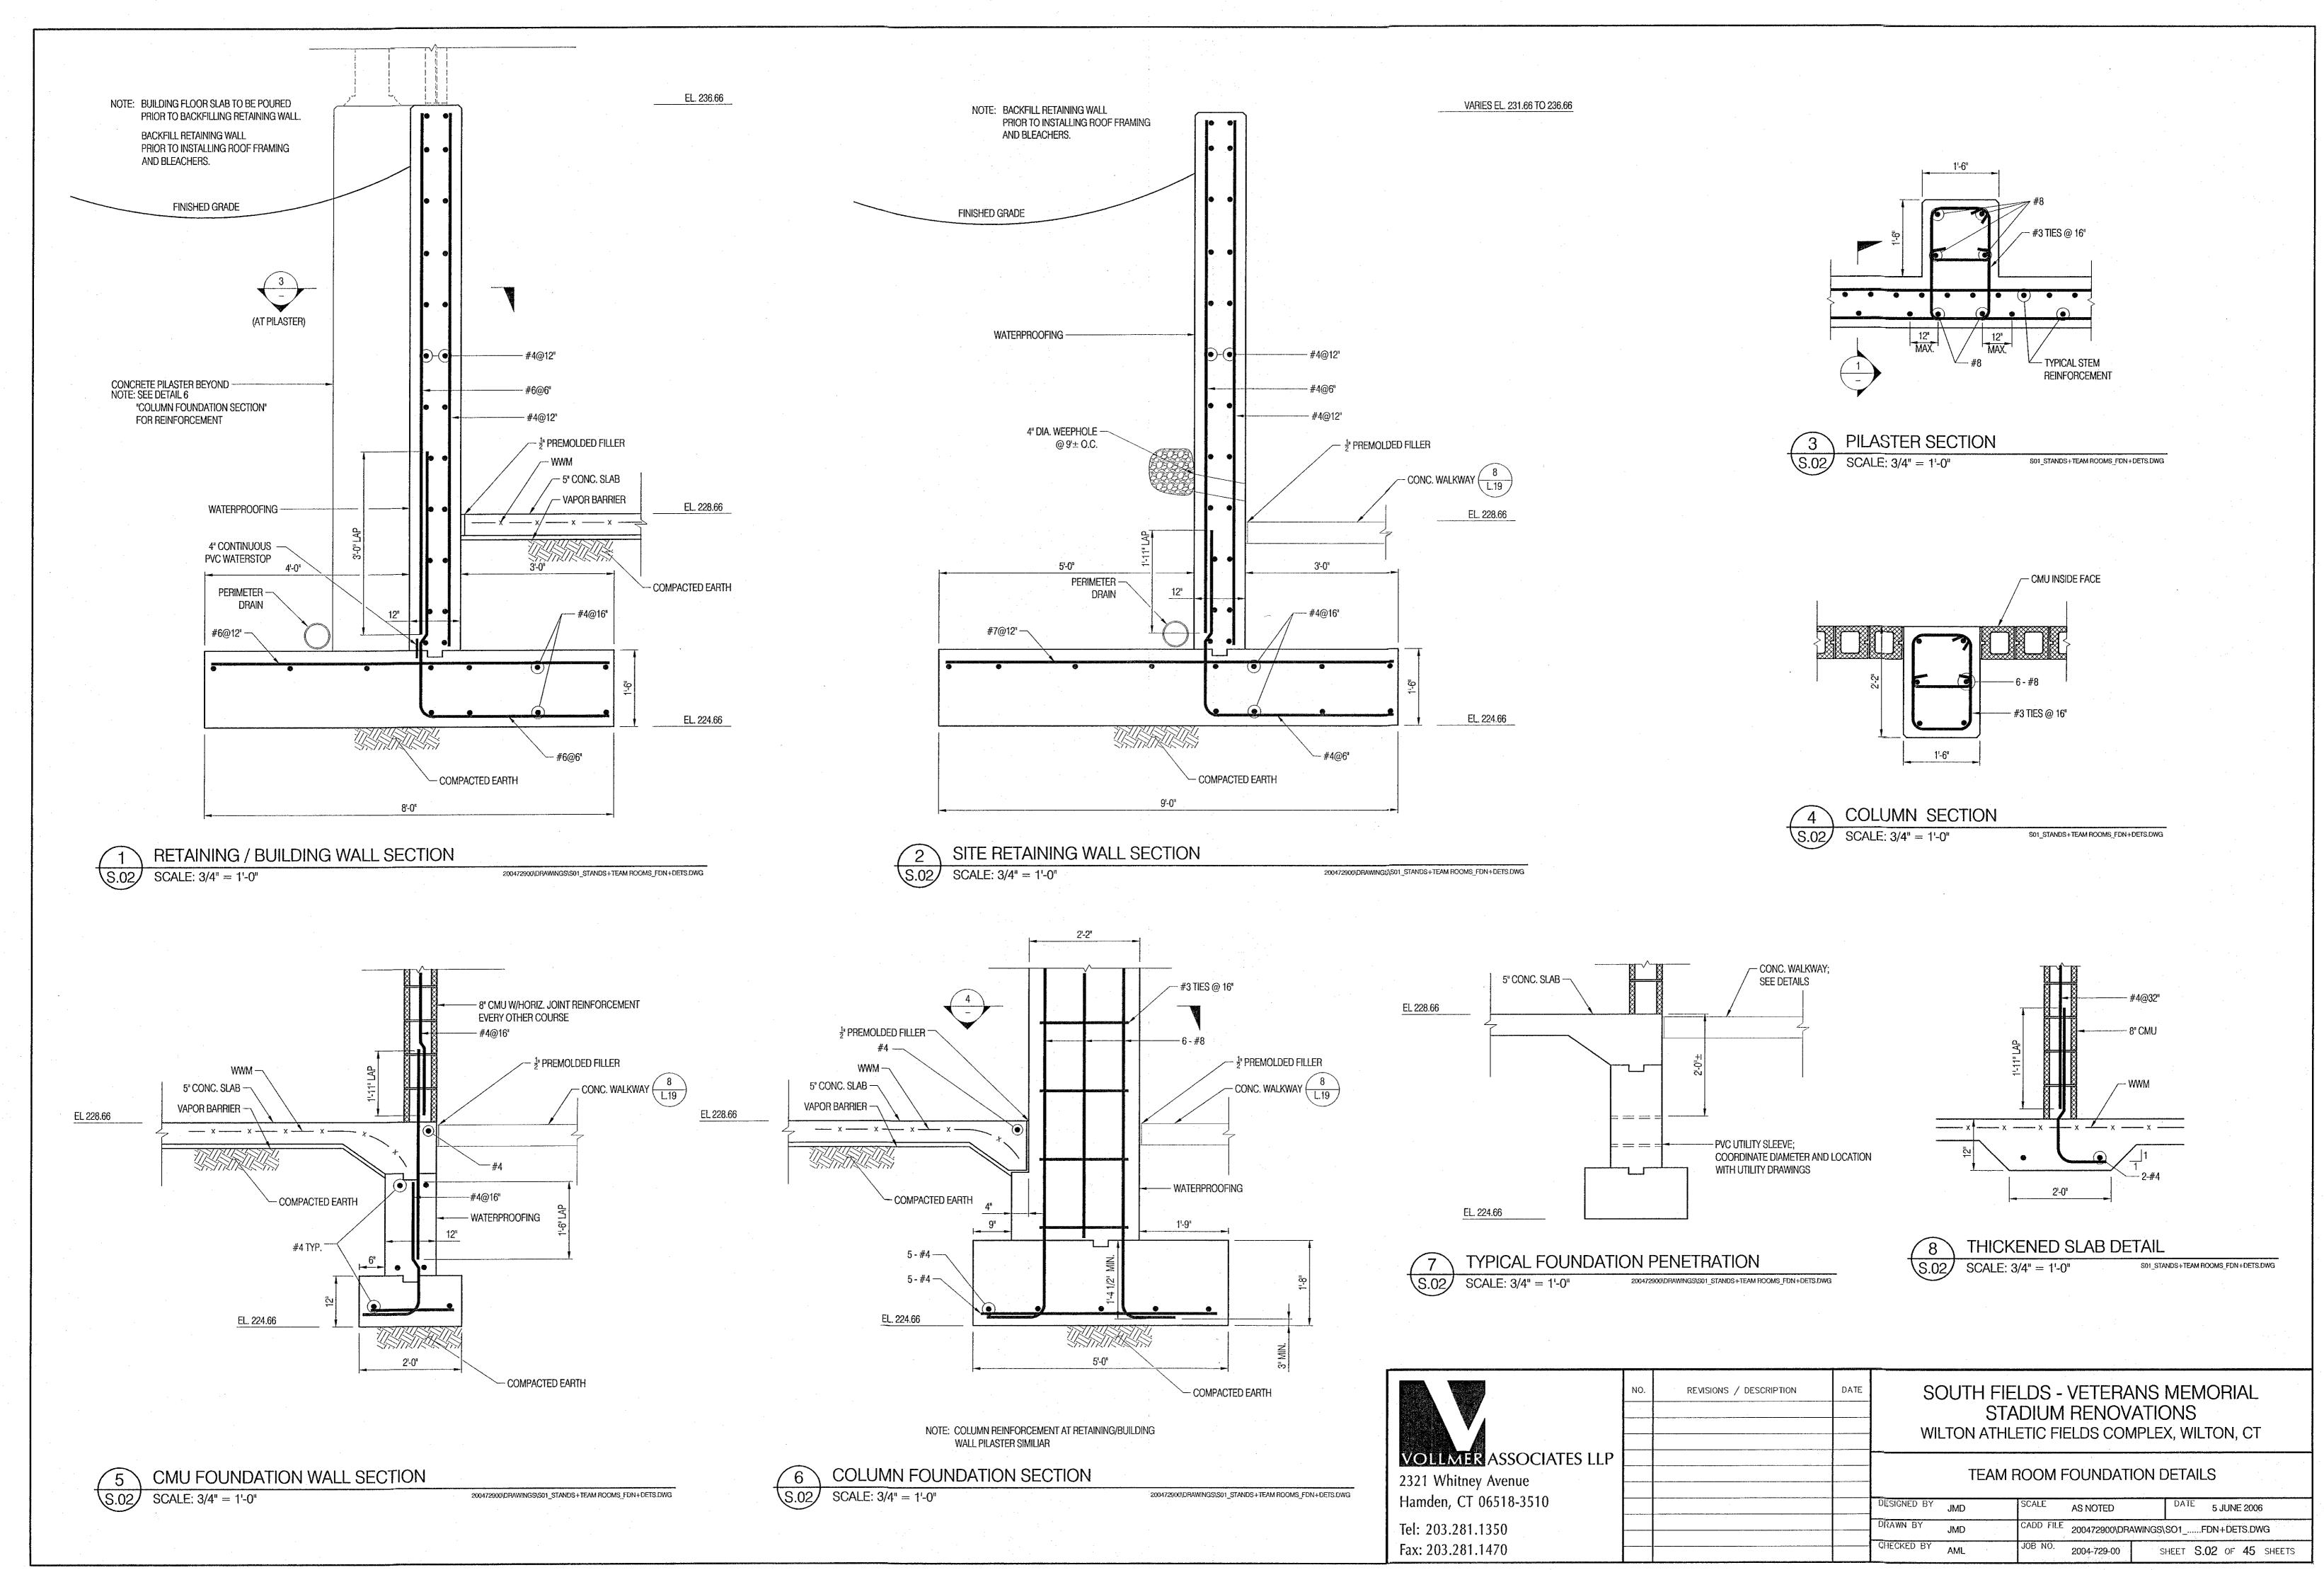

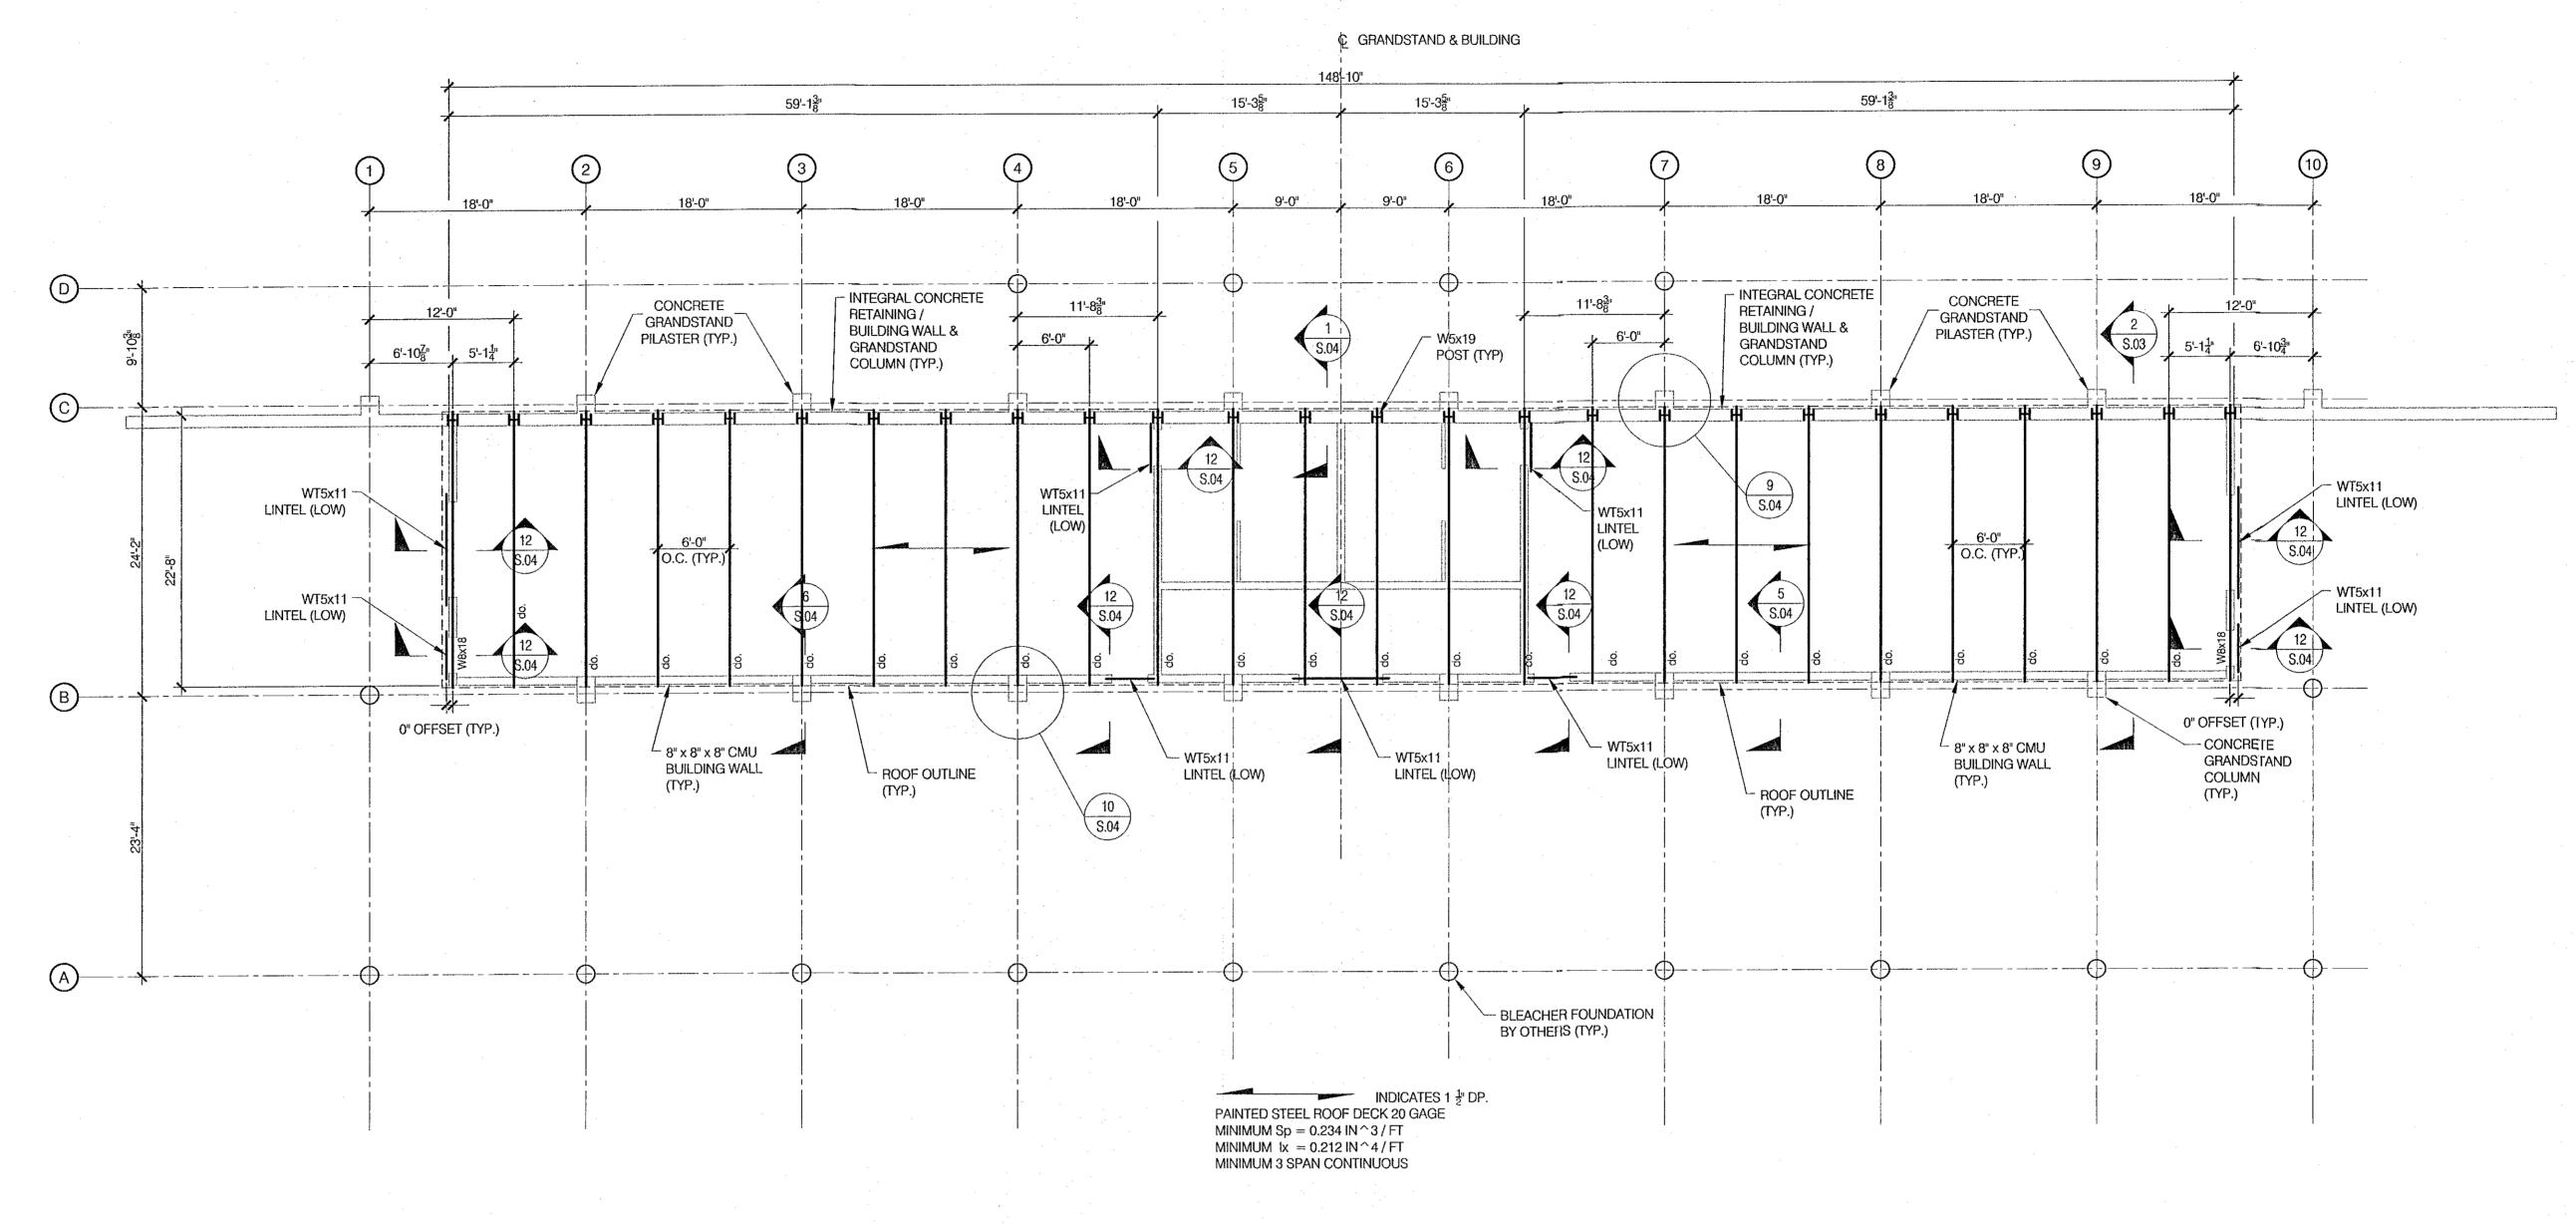

FRAMING PLAN SCALE: 1/8" = 1'-0"

> EL. 237.54 — FFE 228.66

ROOF FRAMING PROFILE AND TOP OF STEEL ELEVATIONS

200472900\DRAWINGS\S01\_STANDS+TEAM ROOMS\_FDN+DETS.DWG


	NO.	REVISIONS / DESCRIPTION	DATE	
VOLLMER ASSOCIATES LLP				
2321 Whitney Avenue				
Hamdon CT 06518-3510				DECI

SOUTH FIELDS - VETERANS MEMORIAL STADIUM RENOVATIONS WILTON ATHLETIC FIELDS COMPLEX, WILTON, CT

DATE 5 JUNE 2006 AS NOTED CADD FILE 200472900\DRAWINGS\SO1\_.....FDN+DETS.DWG SHEET S.03 OF 45 SHEETS 2004-729-00

TEAM ROOM FRAMING PLAN DESIGNED BY JMD Hamden, CI 06518-3510 DRAWN BY Tel: 203.281.1350 CHECKED BY AML Fax: 203.281.1470

200472900\DRAWINGS\S01\_STANDS+TEAM ROOMS\_FDN+DETS.DWG

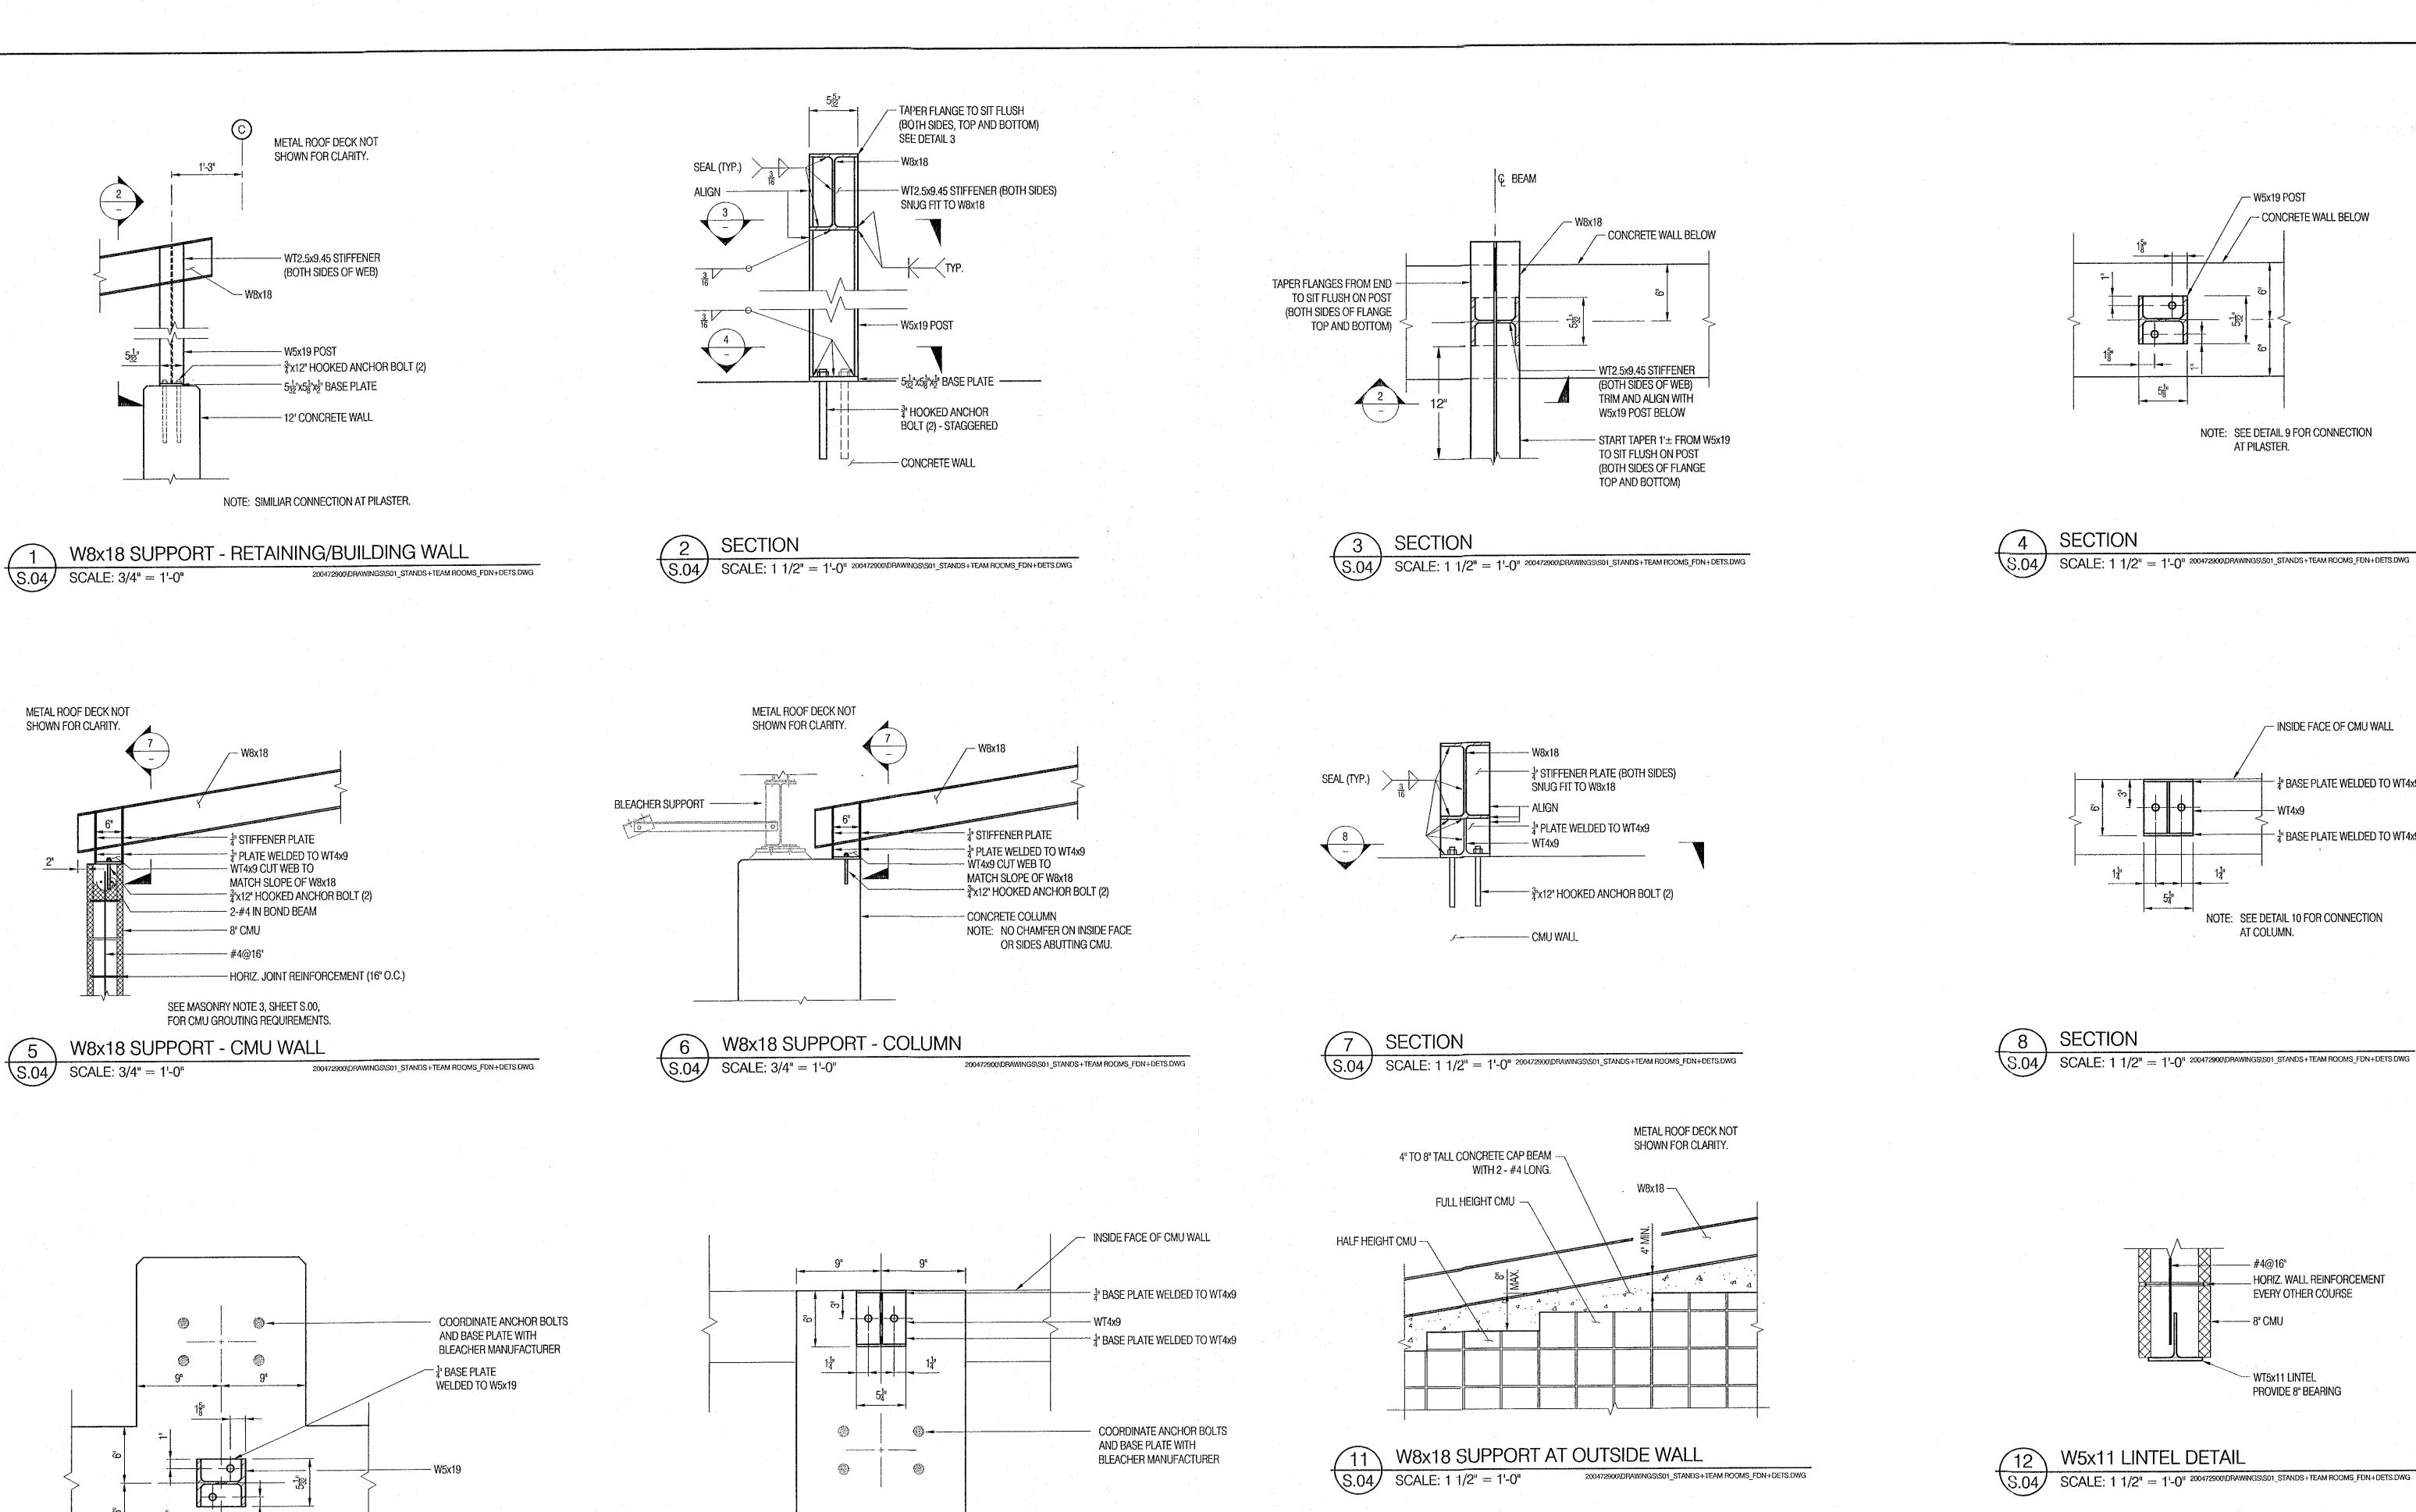

 $5\frac{1}{8}$ 

PLAN

S.04 SCALE: 1 1/2" = 1'-0"

INSIDE FACE OF WALL

SOUTH FIELDS - VETERANS MEMORIAL REVISIONS / DESCRIPTION STADIUM RENOVATIONS WILTON ATHLETIC FIELDS COMPLEX, WILTON, CT TEAM ROOM FRAMING DETAILS

- W5x19 POST

NOTE: SEE DETAIL 9 FOR CONNECTION

INSIDE FACE OF CMU WALL

- # BASE PLATE WELDED TO WT4x9

- <sup>1</sup>/<sub>4"</sub> Base Plate Welded to WT4x9

NOTE: SEE DETAIL 10 FOR CONNECTION

HORIZ. WALL REINFORCEMENT

**EVERY OTHER COURSE** 

- WT5x11 LINTEL

PROVIDE 8" BEARING

AT COLUMN.

AT PILASTER.

- CONCRETE WALL BELOW

**VOLLMER** ASSOCIATES LLP 2321 Whitney Avenue Hamden, CT 06518-3510 DESIGNED BY JMD S.04 SCALE: 1 1/2" = 1'-0" DATE 5 JUNE 2006 200472900\DRAWINGS\S01\_STANDS+TEAM ROOMS\_FDN+DETS.DWG AS NOTED 200472900\DRAWINGS\S01\_STANDS+TEAM ROOMS\_FDN+DETS.DWG CADD FILE 200472900\DRAWINGS\SO1\_.....FDN+DETS.DWG Tel: 203.281.1350 CHECKED BY AML JOB NO. 2004-729-00 Fax: 203.281.1470 SHEET S.04 OF 45 SHEETS