

TRANSMITTAL

TO: FROM:		nn, Town Planner Granoff Architects) rchitects.com	DATE: PROJECT:	May 31, 2023 Wilton Center Lofts (12 Godfrey Place)
CC:			PROJECT NO:	22013
FOR YOUR:	:			
Approval	I	Distribution to Parties	s Information	Use
Review 8	& Comment	P&Z Re-submission	Record	Other
THE FOLLO	WING:			
Drawings	S	Shop Drawings	Samples	
☐ Specifica	tions	Photographs	Product Literat	ture
Change C	Order	Disk (DXF / DWG)	Other (See Bel	ow)
VIA:				
Email		Mail	Over Night Exp	press
COPIES: 6	DATE:	May 26, 2023		
MESSAGE		osed revised Architectural and C	Civil drawings for the above-menti	ioned project for P&Z review
	along with lists	of the proposed changes made.	Six copies will also be shipped to	your office; we kindly request
	that one copy be	e distributed to each the followi	ing: P&Z, DPW, Fire Marshal, WPC	CA, Health Department, Police
		to reach out with any question,	comments, or further requirements	nts.
	Thank you			



DATE: May 31, 2023

TO: Town of Wilton Planning & Zoning Commission

FROM: Richard Granoff (Granoff Architects)

REGARDING: Wilton Center Lofts (12 Godfrey Place) - P&Z Revisions

MESSAGE:


In response to our previous meeting with the Planning & Zoning Commission on 05/22/2023, we have made the following adjustments to the proposed design on the architectural drawings:

- 1) Proposed loading space has been increased from 10'x20' to 10'x30'. Refer to sheets L100, AS100, & A100
- 2) Added clarifications on garage height clearance and drive aisle widths. Refer to sheet A100.
- 3) Reduced number of dwelling units from 42 to 40. There are now 40 dwelling units and 40 standard parking spaces plus 2 HC spaces. Refer to sheet AS100 for unit mix updates and sheet A102 for proposed floor plan updates.

WILTON CENTER LOFTS 12 GODFREY PLACE WILTON, CT



DRA	AWING INDEX	Issued For:		P&Z REV.		(207 0) //10 700
Dwg No.	<u>Title</u>	DATE		Jan. 23, 2023	Feb. 07, 2023	M21F 2007
T100	Title Sheet	-	X	X	Х	<u> </u>
	neer Drawings	\top				
PSTS	Property & Topographic Survey				X	
SE-1	Site Development Plan				X	
SE-2	Sedimentation & Erosion Control Plan				X	
SE-3	Details & Soil Data				X	
SE-4	Details				Χ	
Landscape Granoff Archit						
L100	Landscape Plan		Х	Х	Χ	
Architectu Granoff Archit	ural Drawings tects					
AS100	Architectural Site Plan & Zoning Information		Х	Х	X	
AS101	Context Images			X	X	
A100	Ground Floor Plan		X	X	X	
A101	First Floor Plan			Х	Х	
A102	Second Floor Plan			X	X	
A103	Penthouse Floor Plan			X	X	
A104	Roof Plan		Х	Х	X	
A200	Ground Floor Exterior Lighting Plan			Х	X	
A201	First Floor Exterior Lighting Plan			Х	X	
A202	Second Floor Exterior Lighting Plan			X	X	1
A203	Penthouse Floor Exterior Lighting Plan			X	X	1
A300	Building Elevations (West & East)		X	X	X	\perp
A301	Building Elevations (North & South)		X	X	X	\downarrow
A302	Exterior Renderings			X	X	\downarrow
A302A	Exterior Renderings			X	X	\downarrow
A302B	Exterior Renderings			X		\downarrow
A303	Exterior Materials			X	X	\downarrow
A304	Signage		<u> </u>	X	X	+
A400	Building Sections		X	X	X	1
L-1	Ground Floor Photometric Calculation			X	X	+
L-2	First & Second Floor Photometric Calculation			X	X	+
L-3	Penthouse Floor Photometric Calculation	I		X	X	

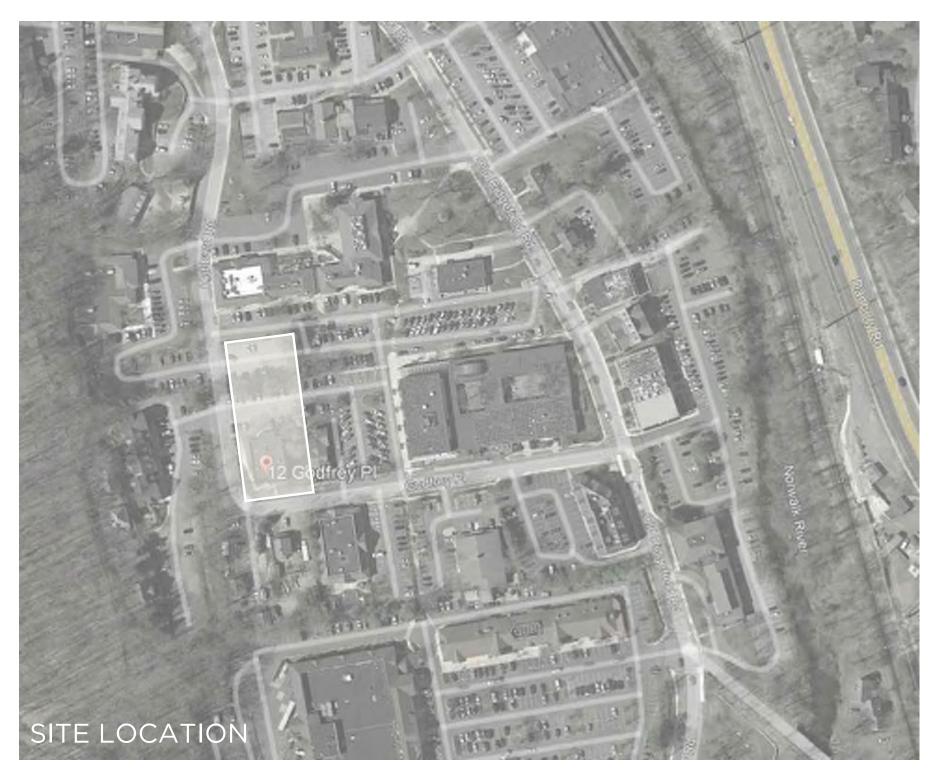



PROPERTY LOCATION MAP

NTS

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1	09.30.2022	P&Z SUBMISSION	cc
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3	01.23.2023	P&Z REVISIONS	cc
4	02.07.2023	P&Z SUBMISSION (8-30g)	cc
5	05.15.2023	P&Z REVISIONS (8-30g)	cc
6	05.26.2023	P&Z REVISIONS (8-30g)	cc

P&Z SUBMISSION (8-30G) NOT FOR CONSTRUCTION

WILTON CENTER LOFTS


PROJECT ADDRESS: 12 GODFREY PLACE WILTON, CT 06897

JOB NO.: **22013** DRAWN BY: CC/GC PROJ. MANAGER: **RG**

DATE: **02/07/2023** SCALE: AS NOTED DRAWING TITLE **COVER SHEET**

DRAWING NO.

T100

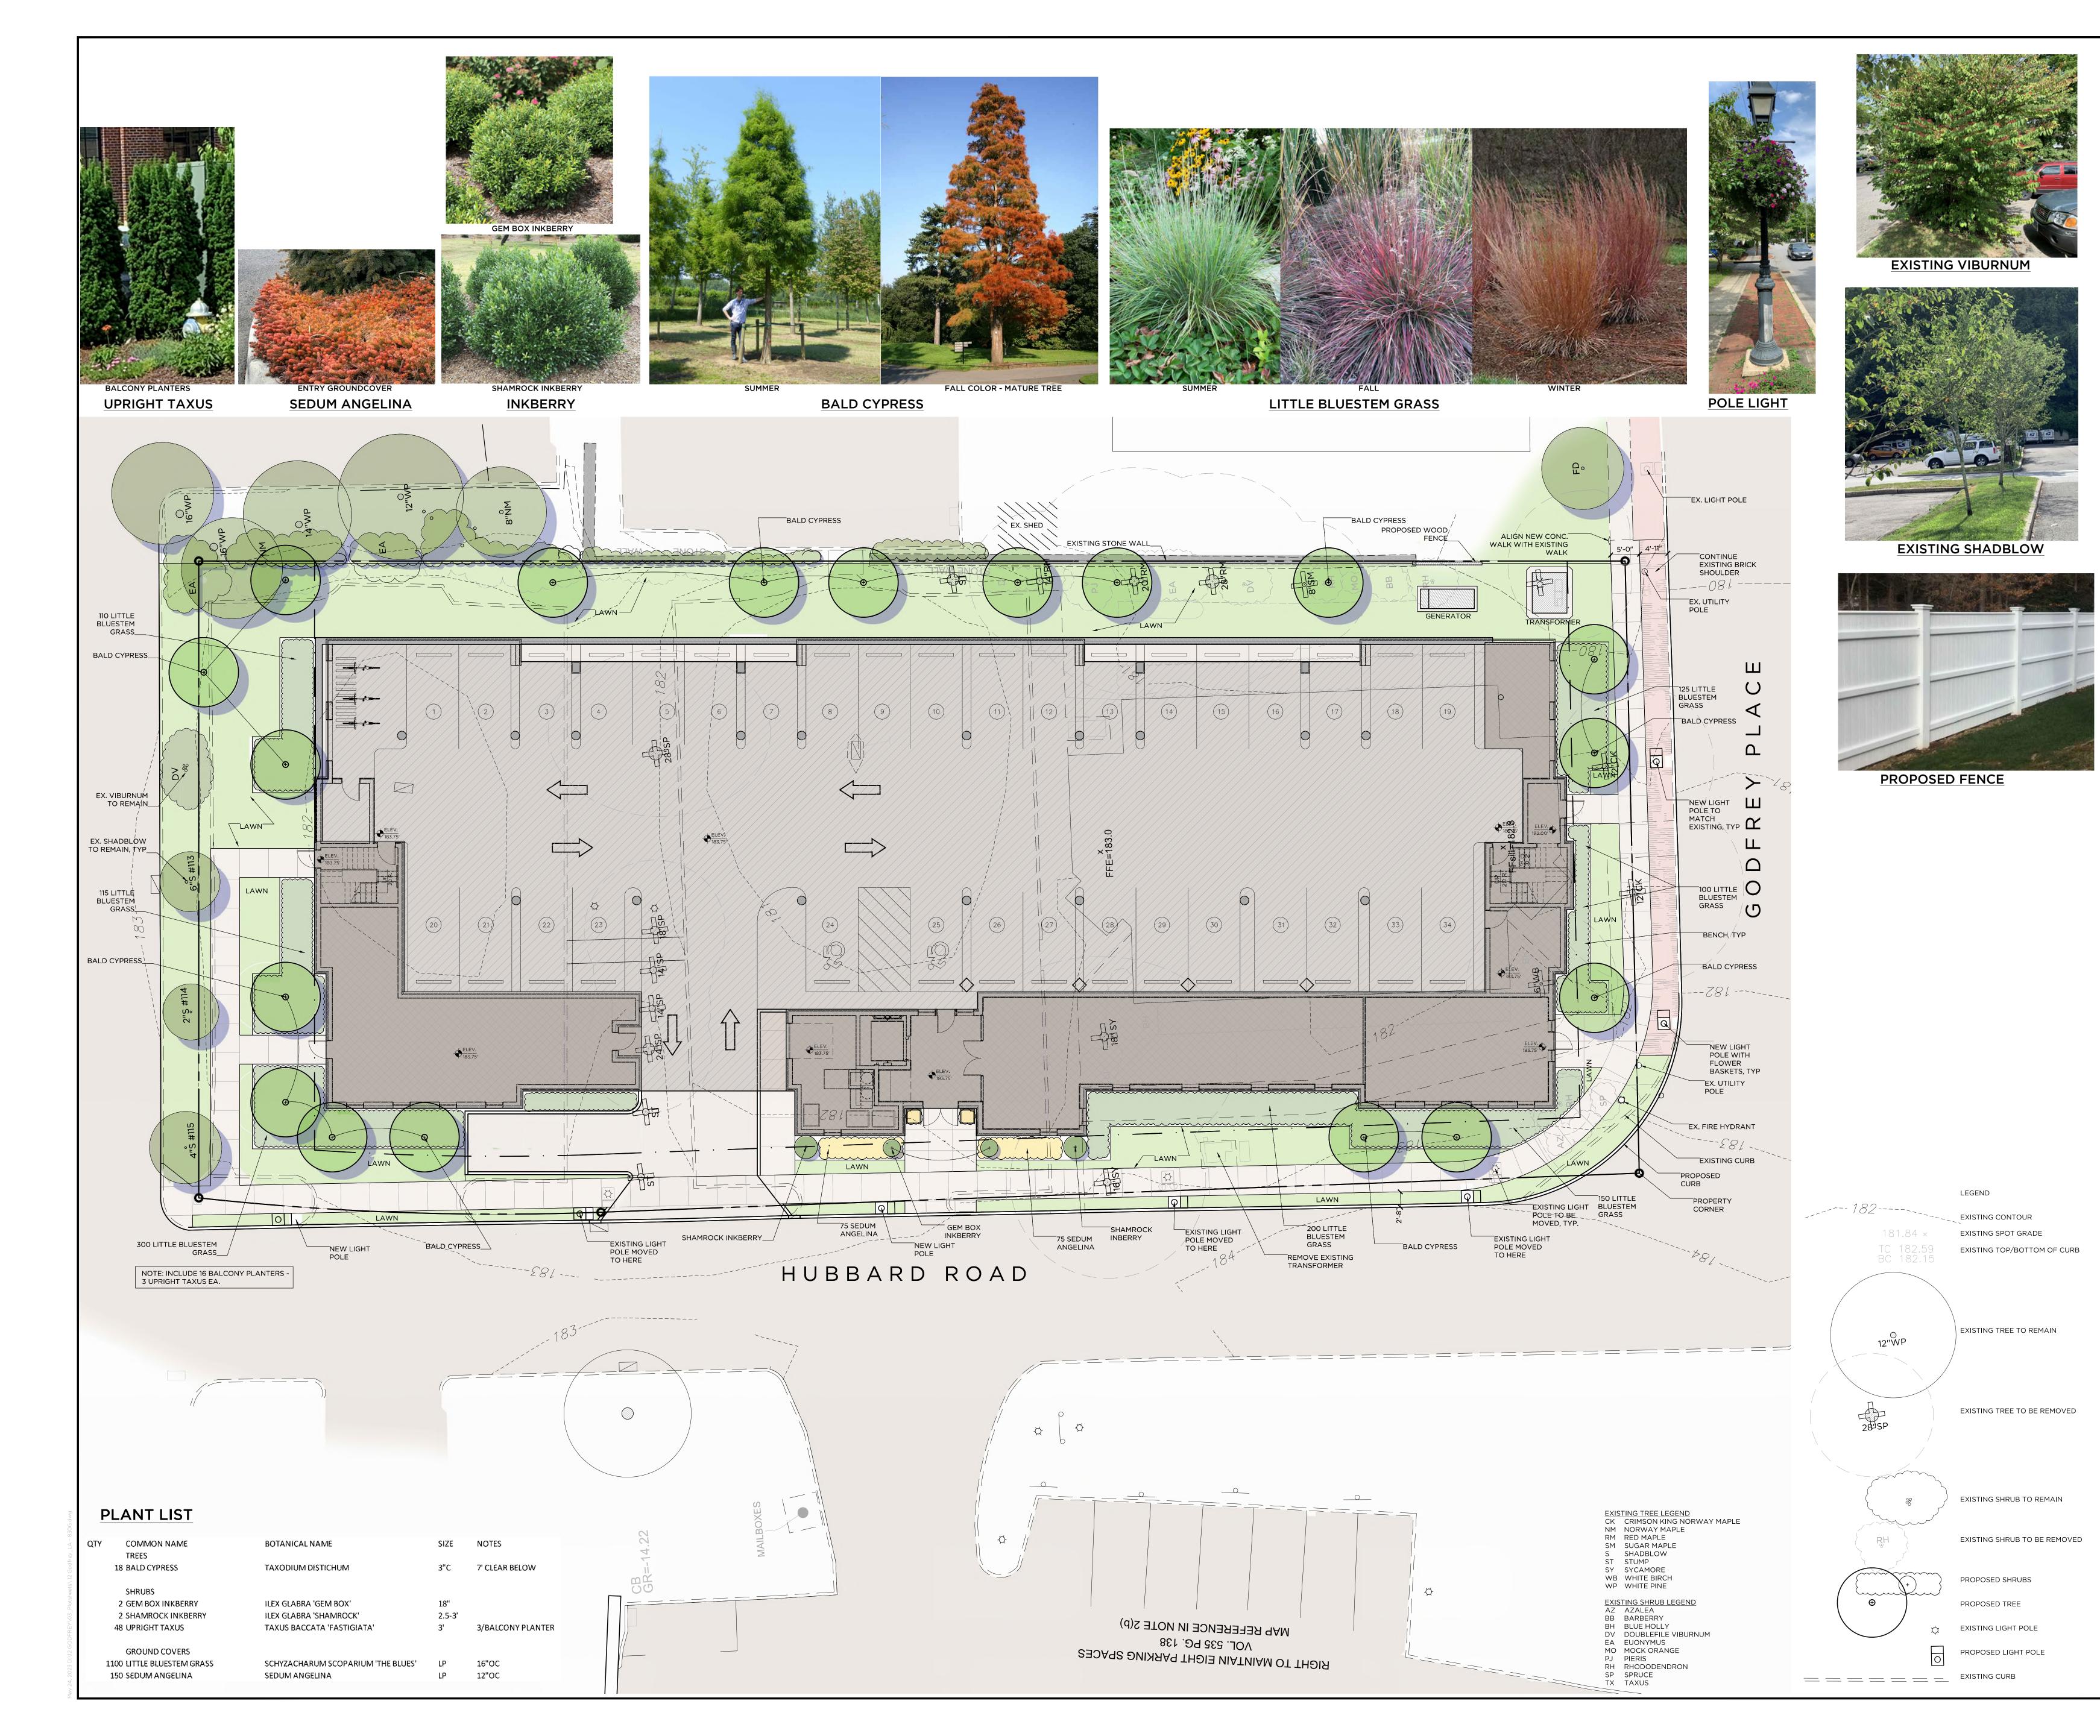


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REVISIONS

DATE REVISION DESCRIPTION

1 05.15.23 LOADING ZONE

2 05.26.23 LOADING ZONE

PHASE

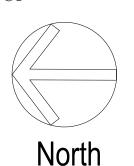PROGRESS PRINT
NOT FOR CONSTRUCTION

PROJECT NAME:

WILTON CENTER LOFTS

PROJECT ADDRESS: 12 GODFREY PLACE

12 GODFREY PLACE WILTON, CT 06897 JOB NO.: 22013

DRAWN BY: RB PROJ. MANAGER: RG


DATE: **02.06.23** SCALE: **1" = 10'**

DATE: **02.06.23**

LANDSCAPE PLAN

DRAWING NO.

_100

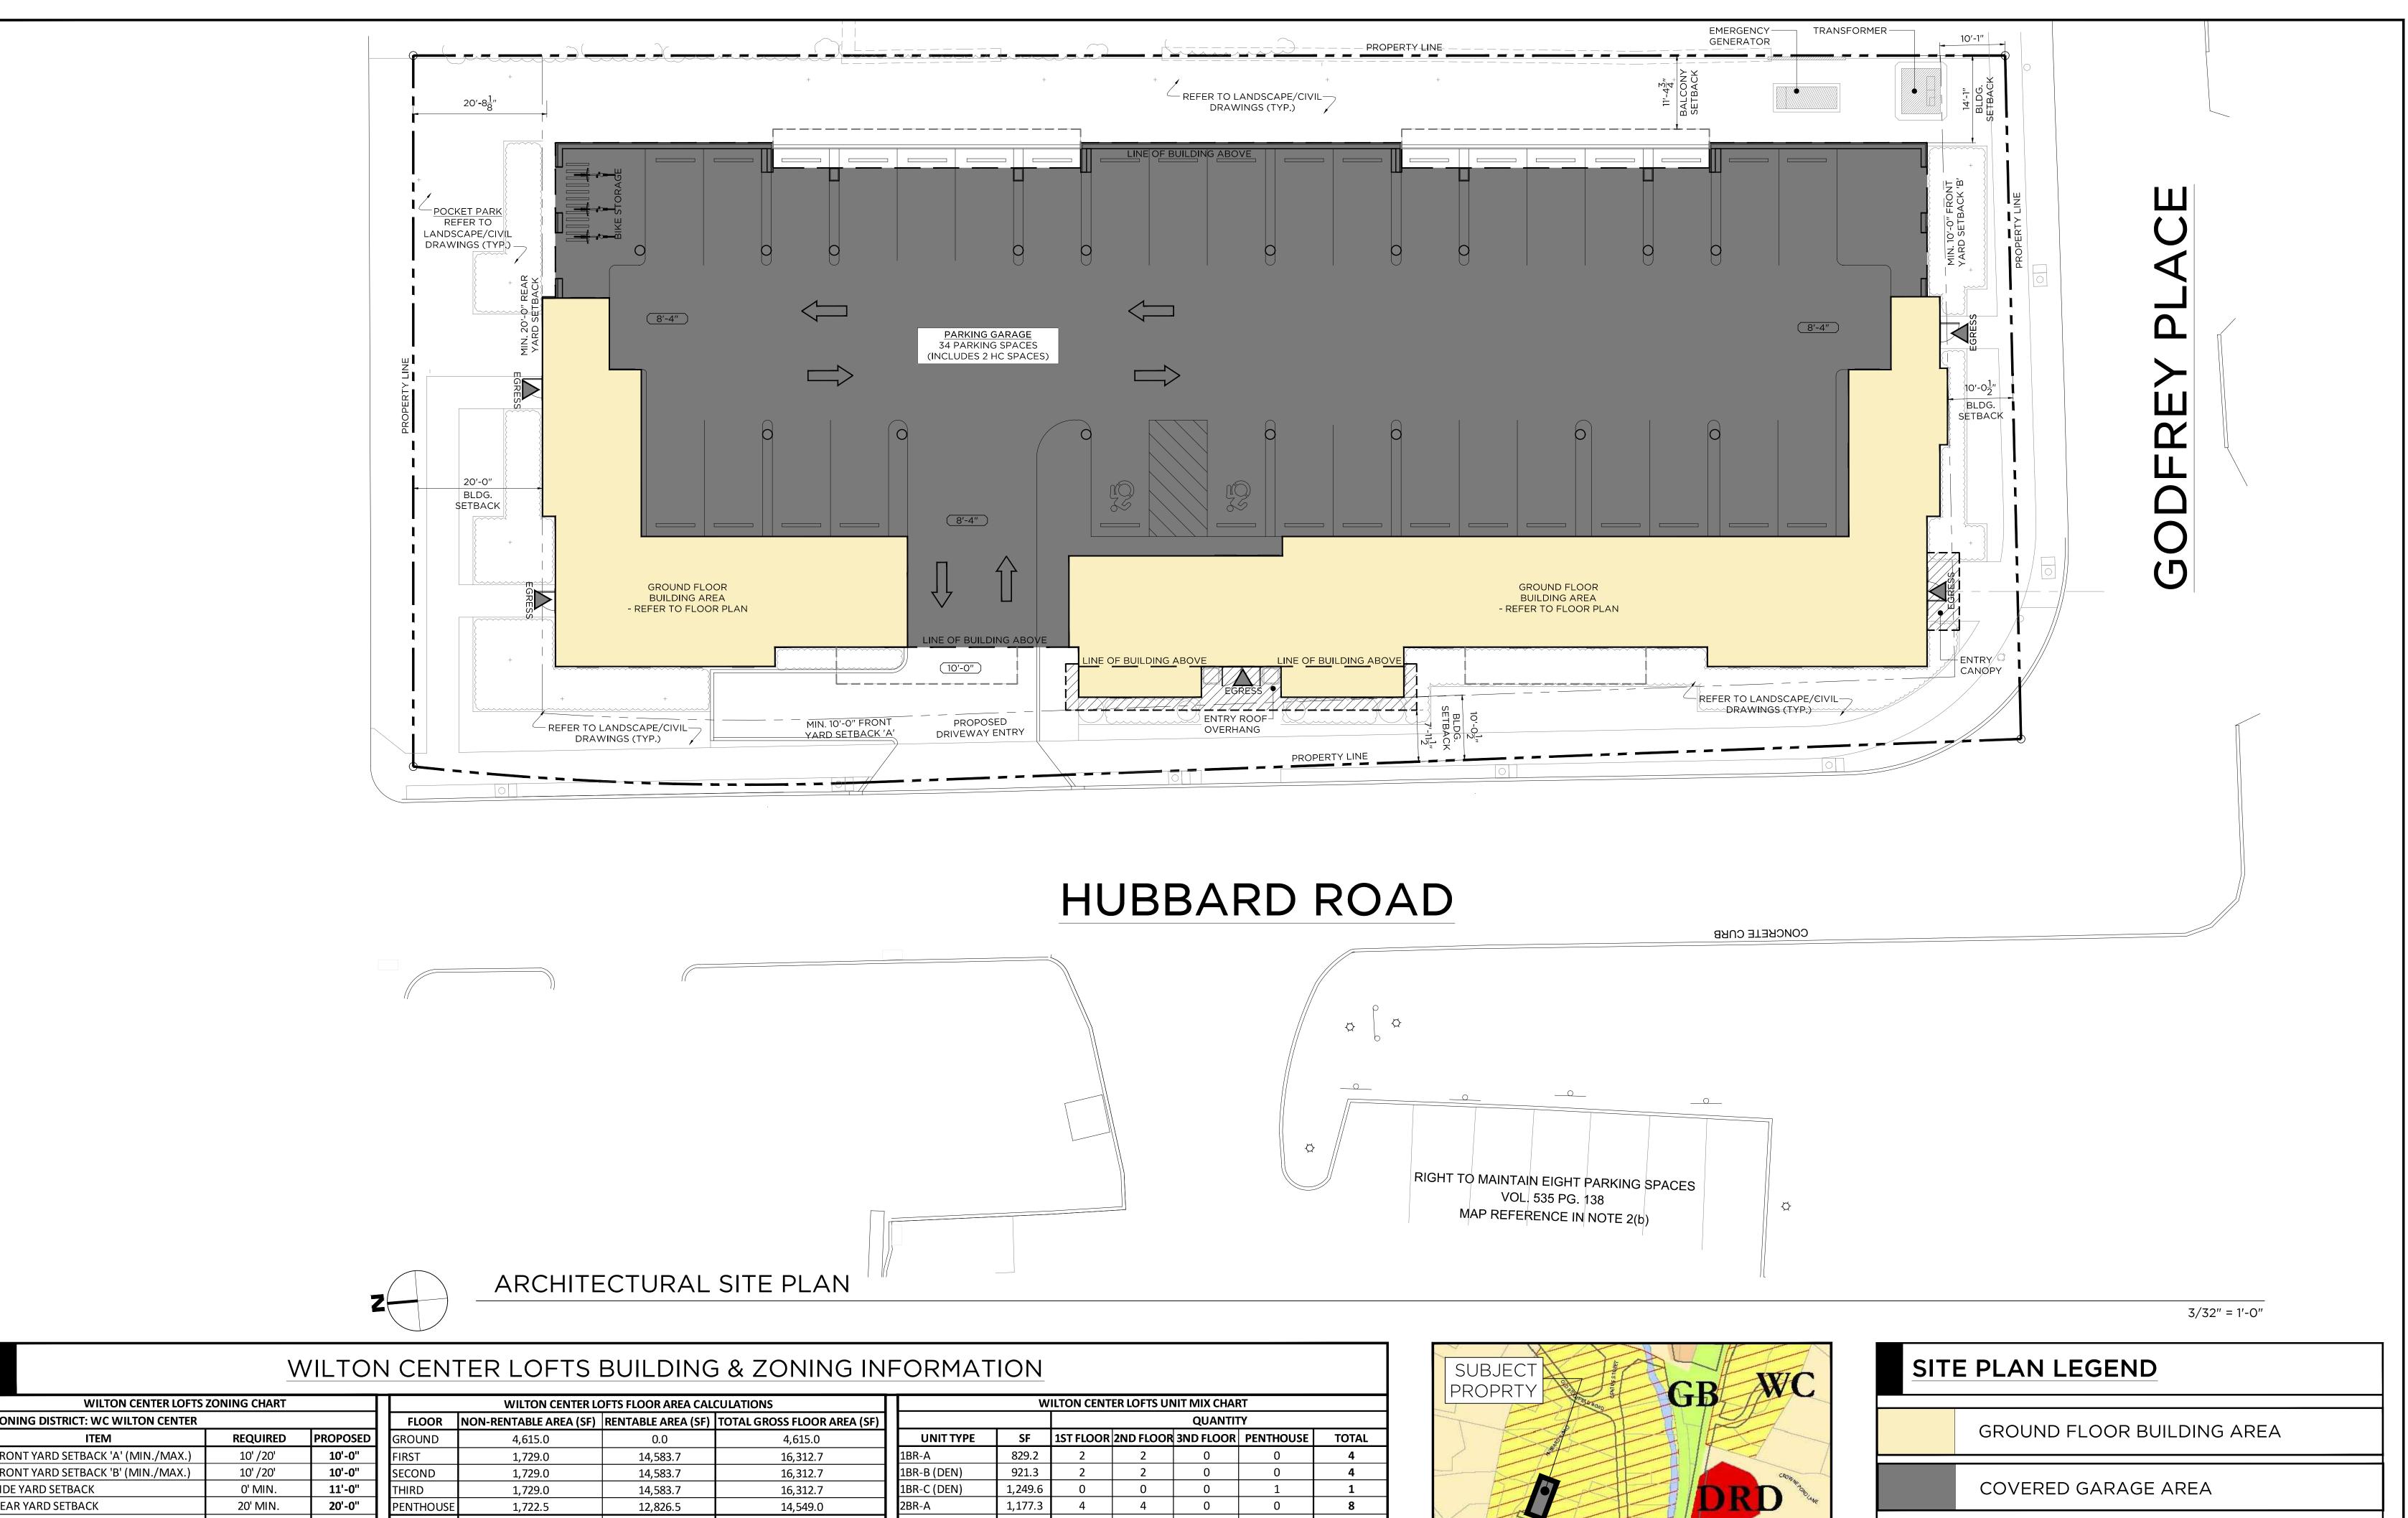

WILTON CENTER LOFTS	ZONING CHAPT					
ZONING DISTRICT: WC WILTON CENTER						
ITEM	REQUIRED	PROPOSED				
FRONT YARD SETBACK 'A' (MIN./MAX.)	10' /20'	10'-0"				
FRONT YARD SETBACK 'B' (MIN./MAX.)	10' /20'	10'-0"				
SIDE YARD SETBACK	0' MIN.	11'-0"				
REAR YARD SETBACK	20' MIN.	20'-0"				
PARKING/LOADING SETBACK	0' MIN.	14'-1"				
BUILDING HEIGHT (STORIES/FEET)	3 STORIES/42' MIN.	5/62'-5"				
BUILDING COVERAGE (%)	30% MAX.	64%*				
SITE COVERAGE (%)	80% MAX.	75%*				
LOT SIZE	N/A	27,246 SF				
LOT FRONTAGE	N/A	N/A				
LOT WIDTH	N/A	N/A				
FLOOR AREA RATION (F.A.R.)	0.5 MAX.	2.50				
* REFER TO CIVIL DRAWINGS						

NUMBER OF PROPOSED ADU'S 60% MAX. 80% MAX.

MEDIAN INCOME | MEDIAN INCOME

PROPOSED AFFORDABLE

DWELLING UNITS (8-30g)

- MINIMUM 30% ADU'S REQUIRED (8-30g):

- (12) ADU'S PROPOSED: SEE BELOW FOR MIX

(40) UNITS x 30% = (12) ADU'S

1BR-B (DEN) 1BR-C (DEN)

2BR-B (DEN) 2BR-C (DEN) 2BR-D (DUPLEX) 2BR-E (DEN) 2BR-F (DEN) 3BR-A (DUPLEX)


TOTAL: 13 UNITS

	WILTON CENTER LOFTS FLOOR AREA CALCULATIONS									
FLOOR	NON-RENTABLE AREA (SF)	RENTABLE AREA (SF)	TOTAL GROSS FLOOR AREA (SF)							
GROUND	4,615.0	0.0	4,615.0							
FIRST	1,729.0	14,583.7	16,312.7							
SECOND	1,729.0	14,583.7	16,312.7							
THIRD	1,729.0	14,583.7	16,312.7							
PENTHOUSE	1,722.5	12,826.5	14,549.0							
TOTAL	11,524.5	56,577.6	68,102.1							
FLOOR AREA	FLOOR AREA RATIO (F.A.R.) = TOTAL GROSS FLOOR AREA / LOT AREA									
FLOOR AREA	RATIO (F.A.R.) = 68,102.1 SF	/ 27,246.6 SF		FLOOR AREA RATIO (F.A.R.) = 68,102.1 SF / 27,246.6 SF						

FLOOR AREA RATIO (F.A.R.) = 2.50

		WILTON CENTER LOFTS UNIT MIX CHART							
				QUANTITY					
1	UNIT TYPE	SF	1ST FLOOR	2ND FLOOR	3ND FLOOR	PENTHOUSE	TOTAL		
	1BR-A	829.2	2	2	0	0	4		
	1BR-B (DEN)	921.3	2	2	0	0	4		
	1BR-C (DEN)	1,249.6	0	0	0	1	1		
	2BR-A	1,177.3	4	4	0	0	8		
	2BR-B (DEN)	1,474.4	1	1	1	0	3		
1	2BR-C (DEN)	1,582.3	1	1	1	0	3		
ı	2BR-D (DUPLEX)	1,465.8	0	0	4	0	4		
1	2BR-E (DEN)	1,409.5	0	0	0	1	1		
1	2BR-F (DEN)	1,750.5	0	0	2	0	2		
ı	3BR-A (DUPLEX)	2,330.5	0	0	4	0	4		
ı	3BR-B	1,504.1	0	0	0	2	2		
ı	3BR-C	1,658.4	2	2	0	0	4		
ı	TOTAL		12	12	12	4	40		
					_				
	UNIT TYPE	TOTAL	PERCENT			PARKING	COUNT		

TOTAL		12	12	12	4	40
UNIT TYPE	TOTAL	PERCENT			PARKING	COUNT
1BR	4	10.00%			LOCATION	COUNT
1BR (DEN)	5	12.50%			ON-SITE	34*
2BR	8	20.00%			OFF-SITE	8
2BR (DEN)	9	22.50%			TOTAL	42
2BR (DUPLEX)	4	10.00%			* INCLUDES (2) H.C. SPACES &	
3BR	6	15.00%			(8) E.V. CHARGIN	
3BR (DUPLEX)	4	10.00%				
TOTAL	40	100.00%			SPACES/UNIT	1.00

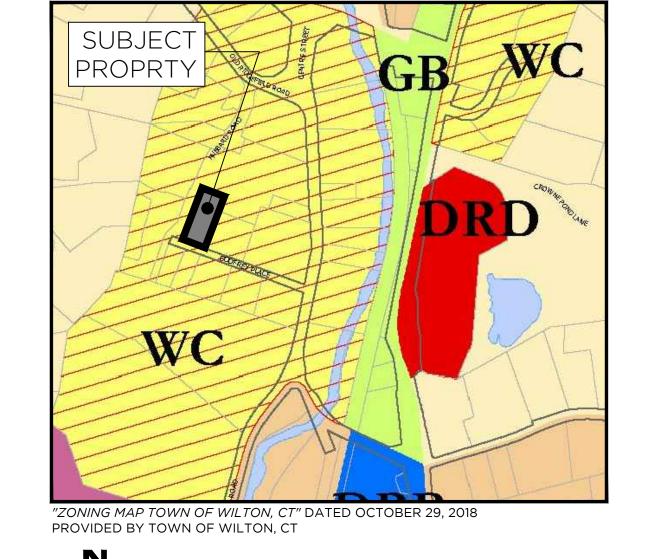

ZONING MAP

NTS

SITI	SITE PLAN LEGEND							
	GROUND FLOOR BUILDING AREA							
	COVERED GARAGE AREA							
	CANTILEVERED BALCONY ABOVE							
	ENTRY ROOF OVERHANG/CANOPY ABOVE							
EGRESS	BUILDING EGRESS EXIT POINT							

, , ,	MITTALS/RE'	VISIONS	
#	DATE	DESCRIPTION	BY
1	09.30.2022	P&Z SUBMISSION	CC
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4	02.07.2023	P&Z SUBMISSION (8-30g)	cc
5	05.15.2023	P&Z REVISIONS (8-30g)	CC
6	05.26.2023	P&Z REVISIONS (8-30g)	CC

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WILTON CENTER LOFTS

PROJECT ADDRESS: 12 GODFREY PLACE WILTON, CT 06897

JOB NO.: **22013** DRAWN BY: CC/GC PROJ. MANAGER: **RG**

DATE: **02/07/2023** SCALE: AS NOTED DRAWING TITLE

ARCHITECTURAL SITE PLAN & ZONING INFORMATION


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■ THE IVY AT WILTON CENTER - 3 HUBBARD ROAD WILTON, CT



■ 23 HUBBARD ROAD WILTON, CT




■ 148 OLD RIDGEFIELD ROAD, WILTON CT

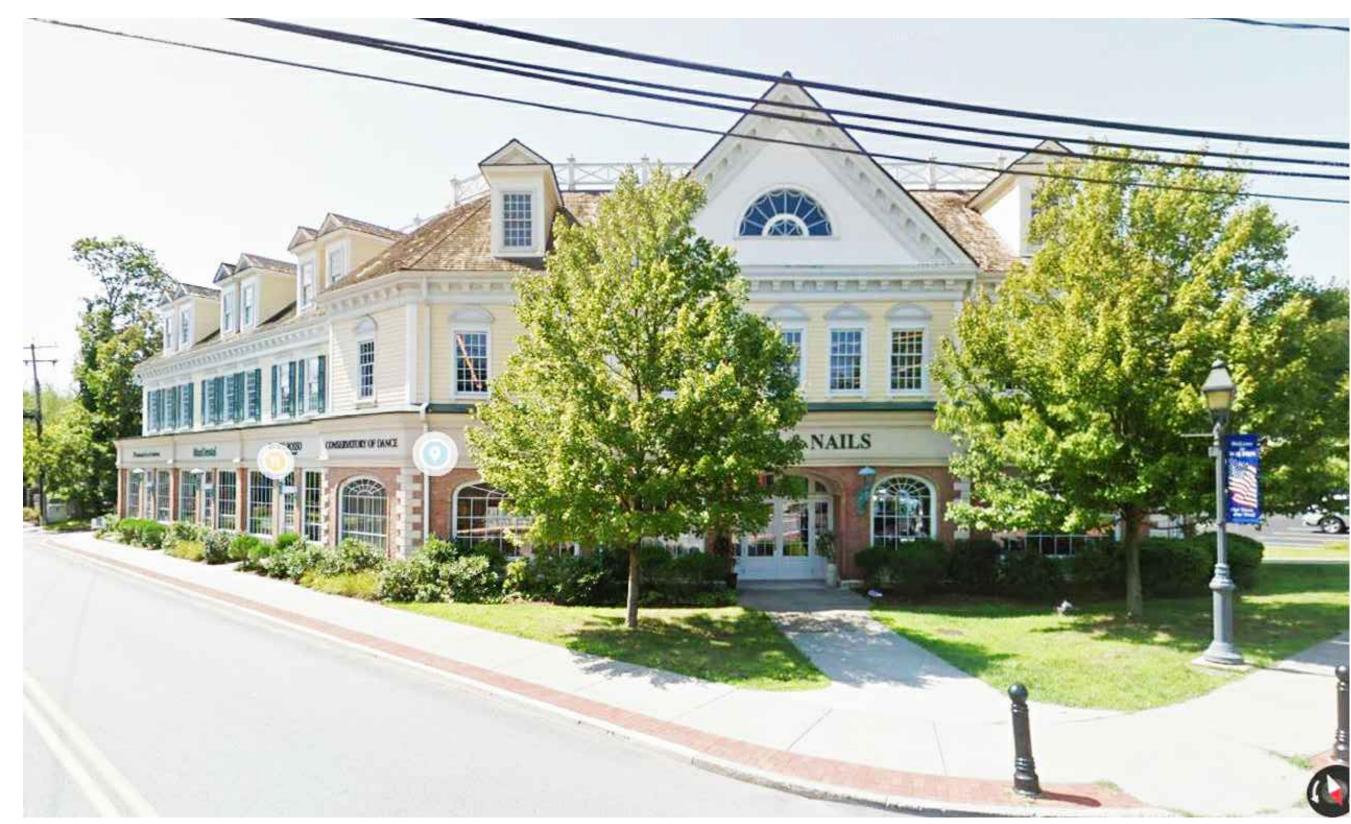

■ 195 DANBURY ROAD, WILTON CT (OFFICE)



■ 200 DANBURY ROAD WILTON, CT

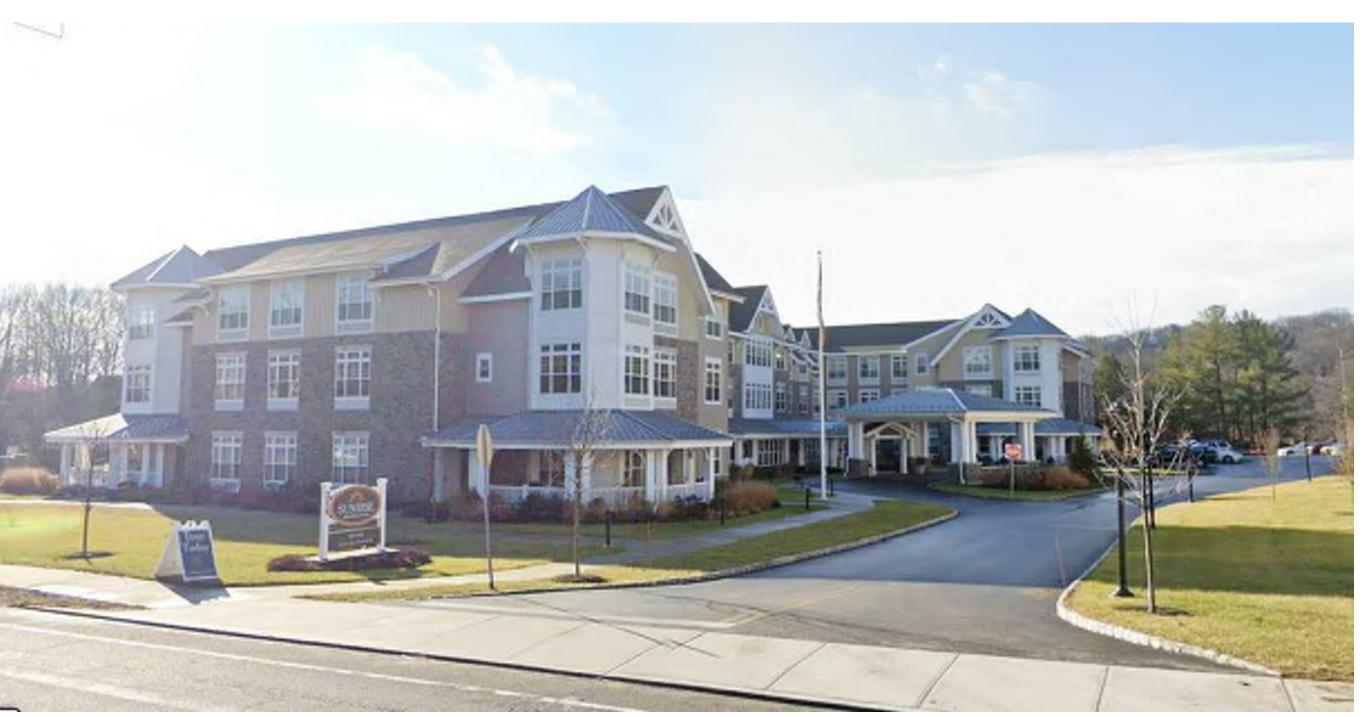

■ SUNRISE SENIOR LIVING 211 DANBURY ROAD WILTON, CT

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WILTON CENTER LOFTS

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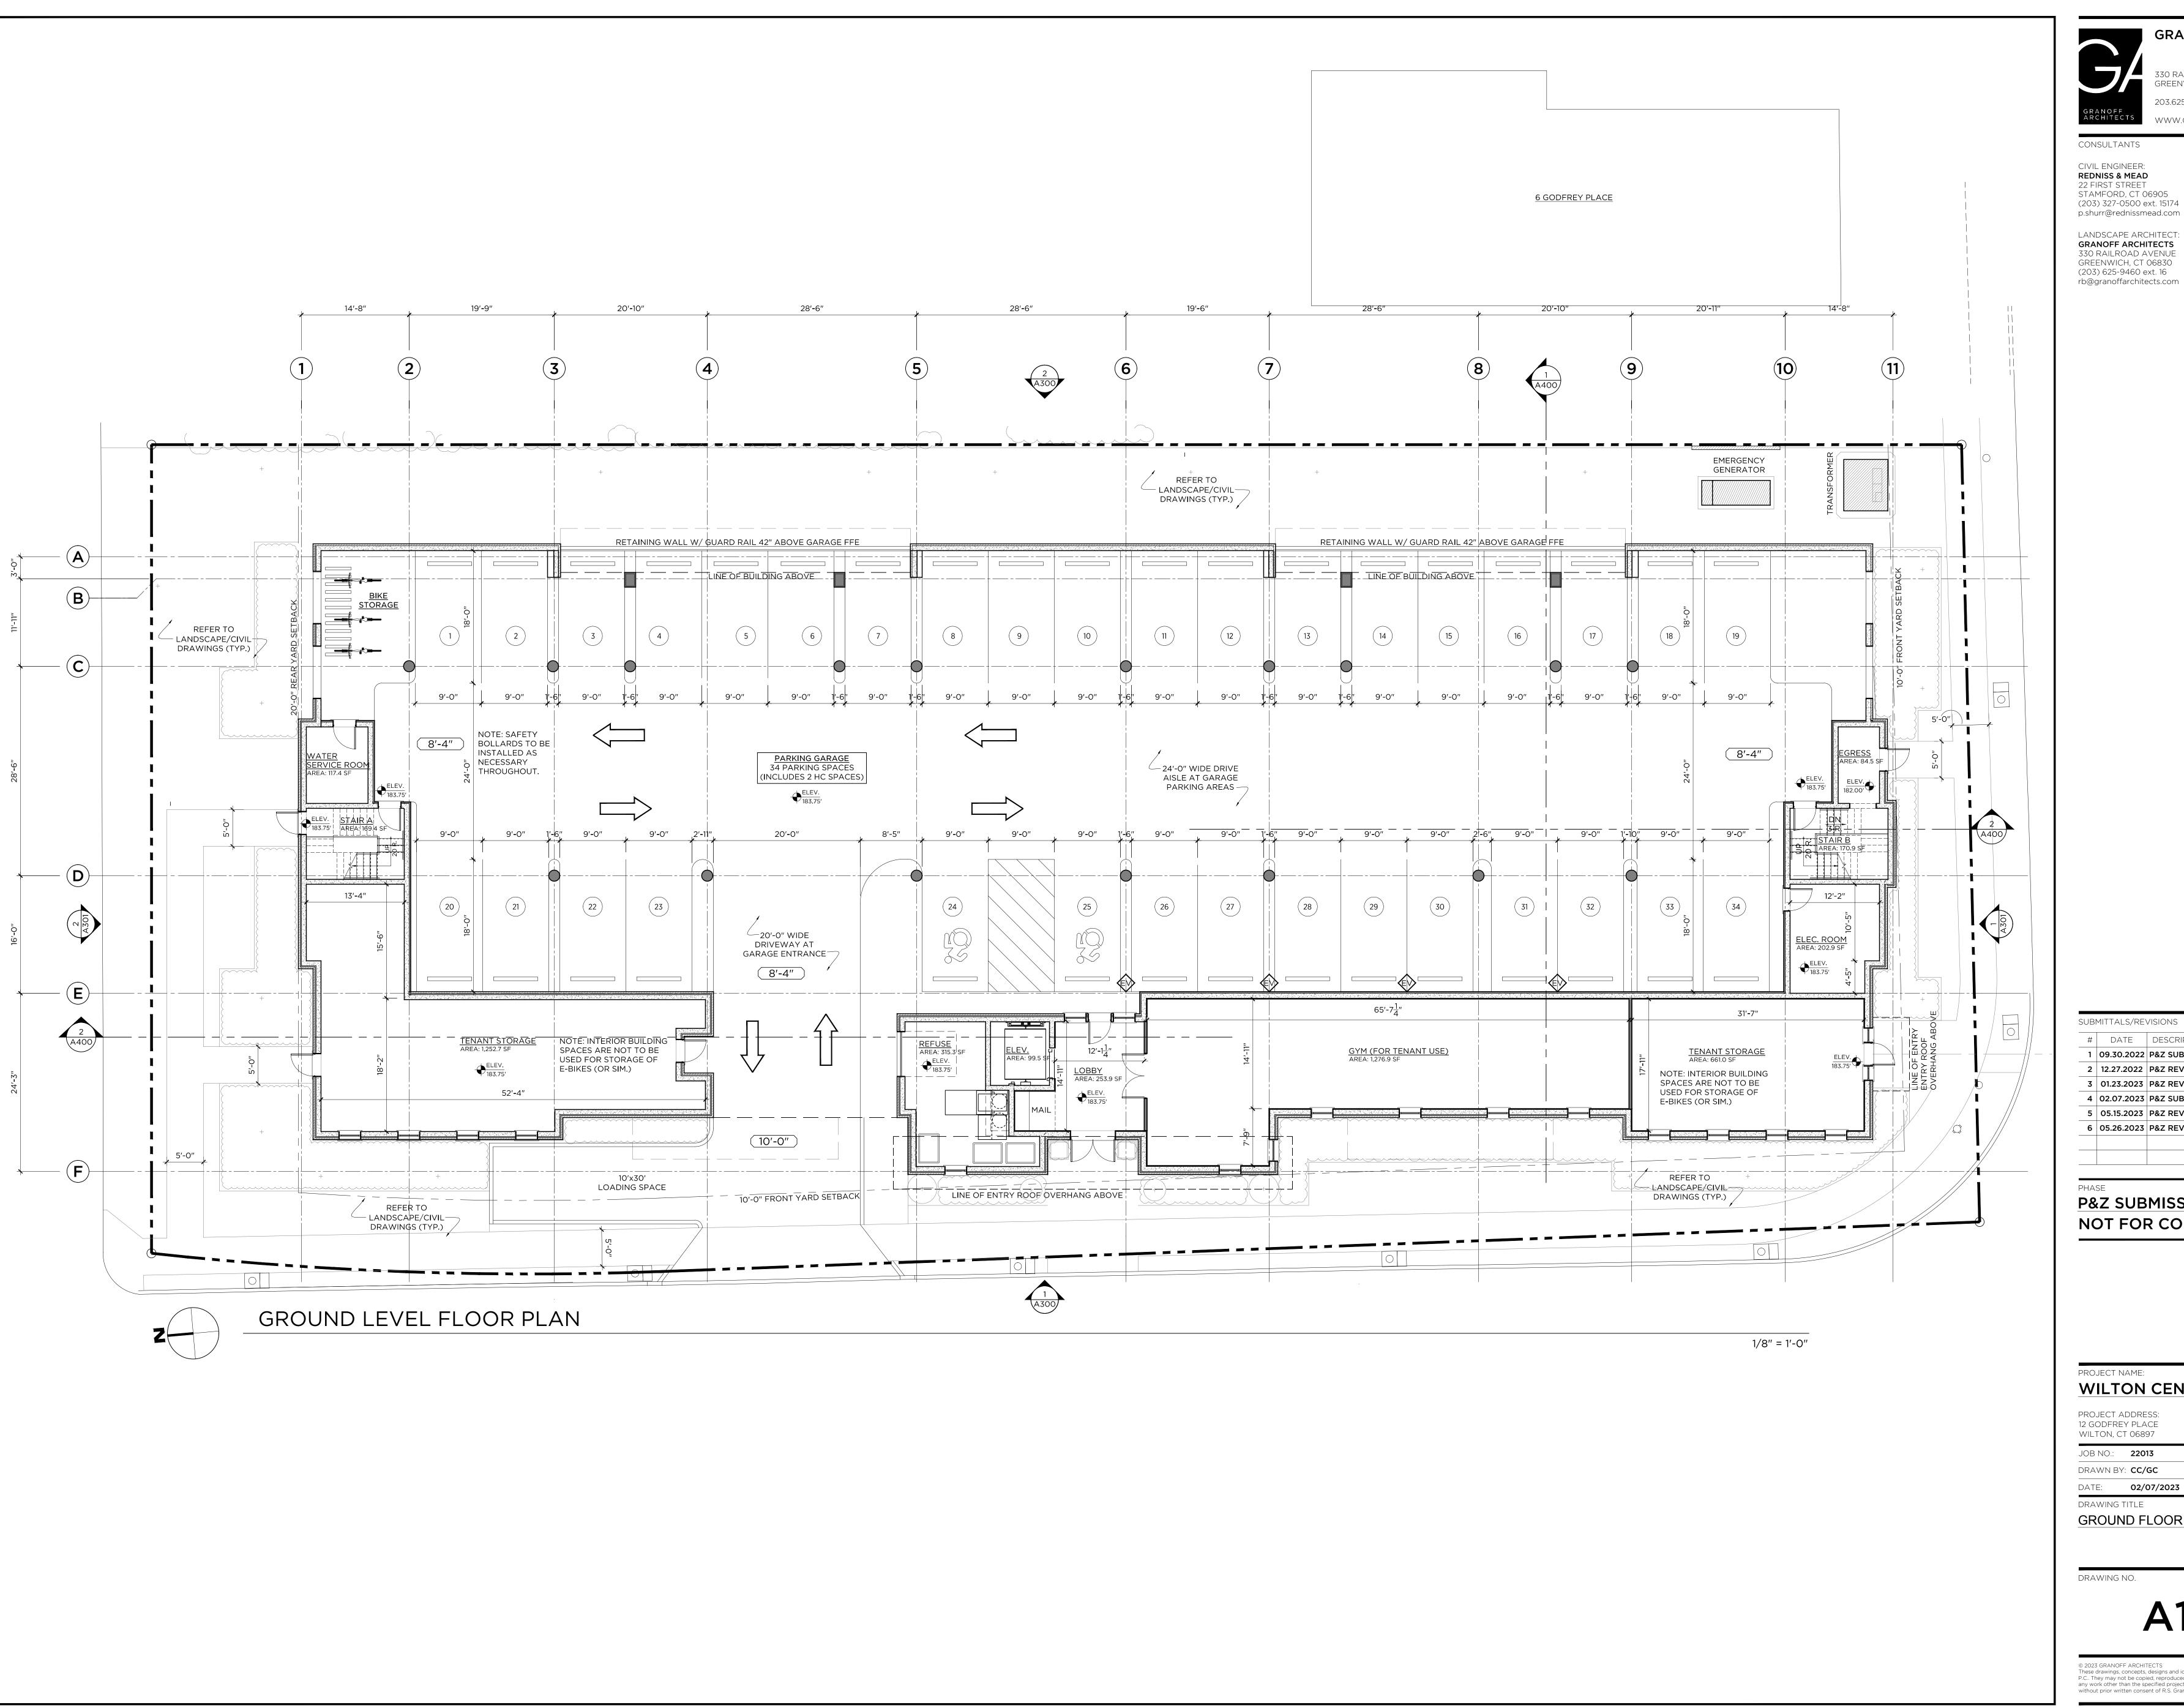
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PROJECT NAME:

WILTON CENTER LOFTS

PROJECT ADDRESS: 12 GODFREY PLACE

WILTON, CT 06897 JOB NO.: **22013**

DRAWN BY: **CC/GC** PROJ. MANAGER: **RG** DATE: **02/07/2023** SCALE: AS NOTED

DRAWING TITLE

GROUND FLOOR PLAN

DRAWING NO.



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WILTON CENTER LOFTS

12 GODFREY PLACE WILTON, CT 06897

JOB NO.: **22013**

DRAWN BY: **CC/GC** PROJ. MANAGER: **RG** DATE: **02/07/2023** SCALE: AS NOTED

TYPICAL FIRST & SECOND FLOOR

DRAWING NO.



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P&Z SUBMISSION (8-30G)

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WILTON CENTER LOFTS

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JOB NO.: **22013**

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THIRD FLOOR PLAN



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WILTON CENTER LOFTS

12 GODFREY PLACE WILTON, CT 06897


JOB NO.: **22013**

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DRAWING TITLE

PENTHOUSE FLOOR PLAN

DRAWING NO.

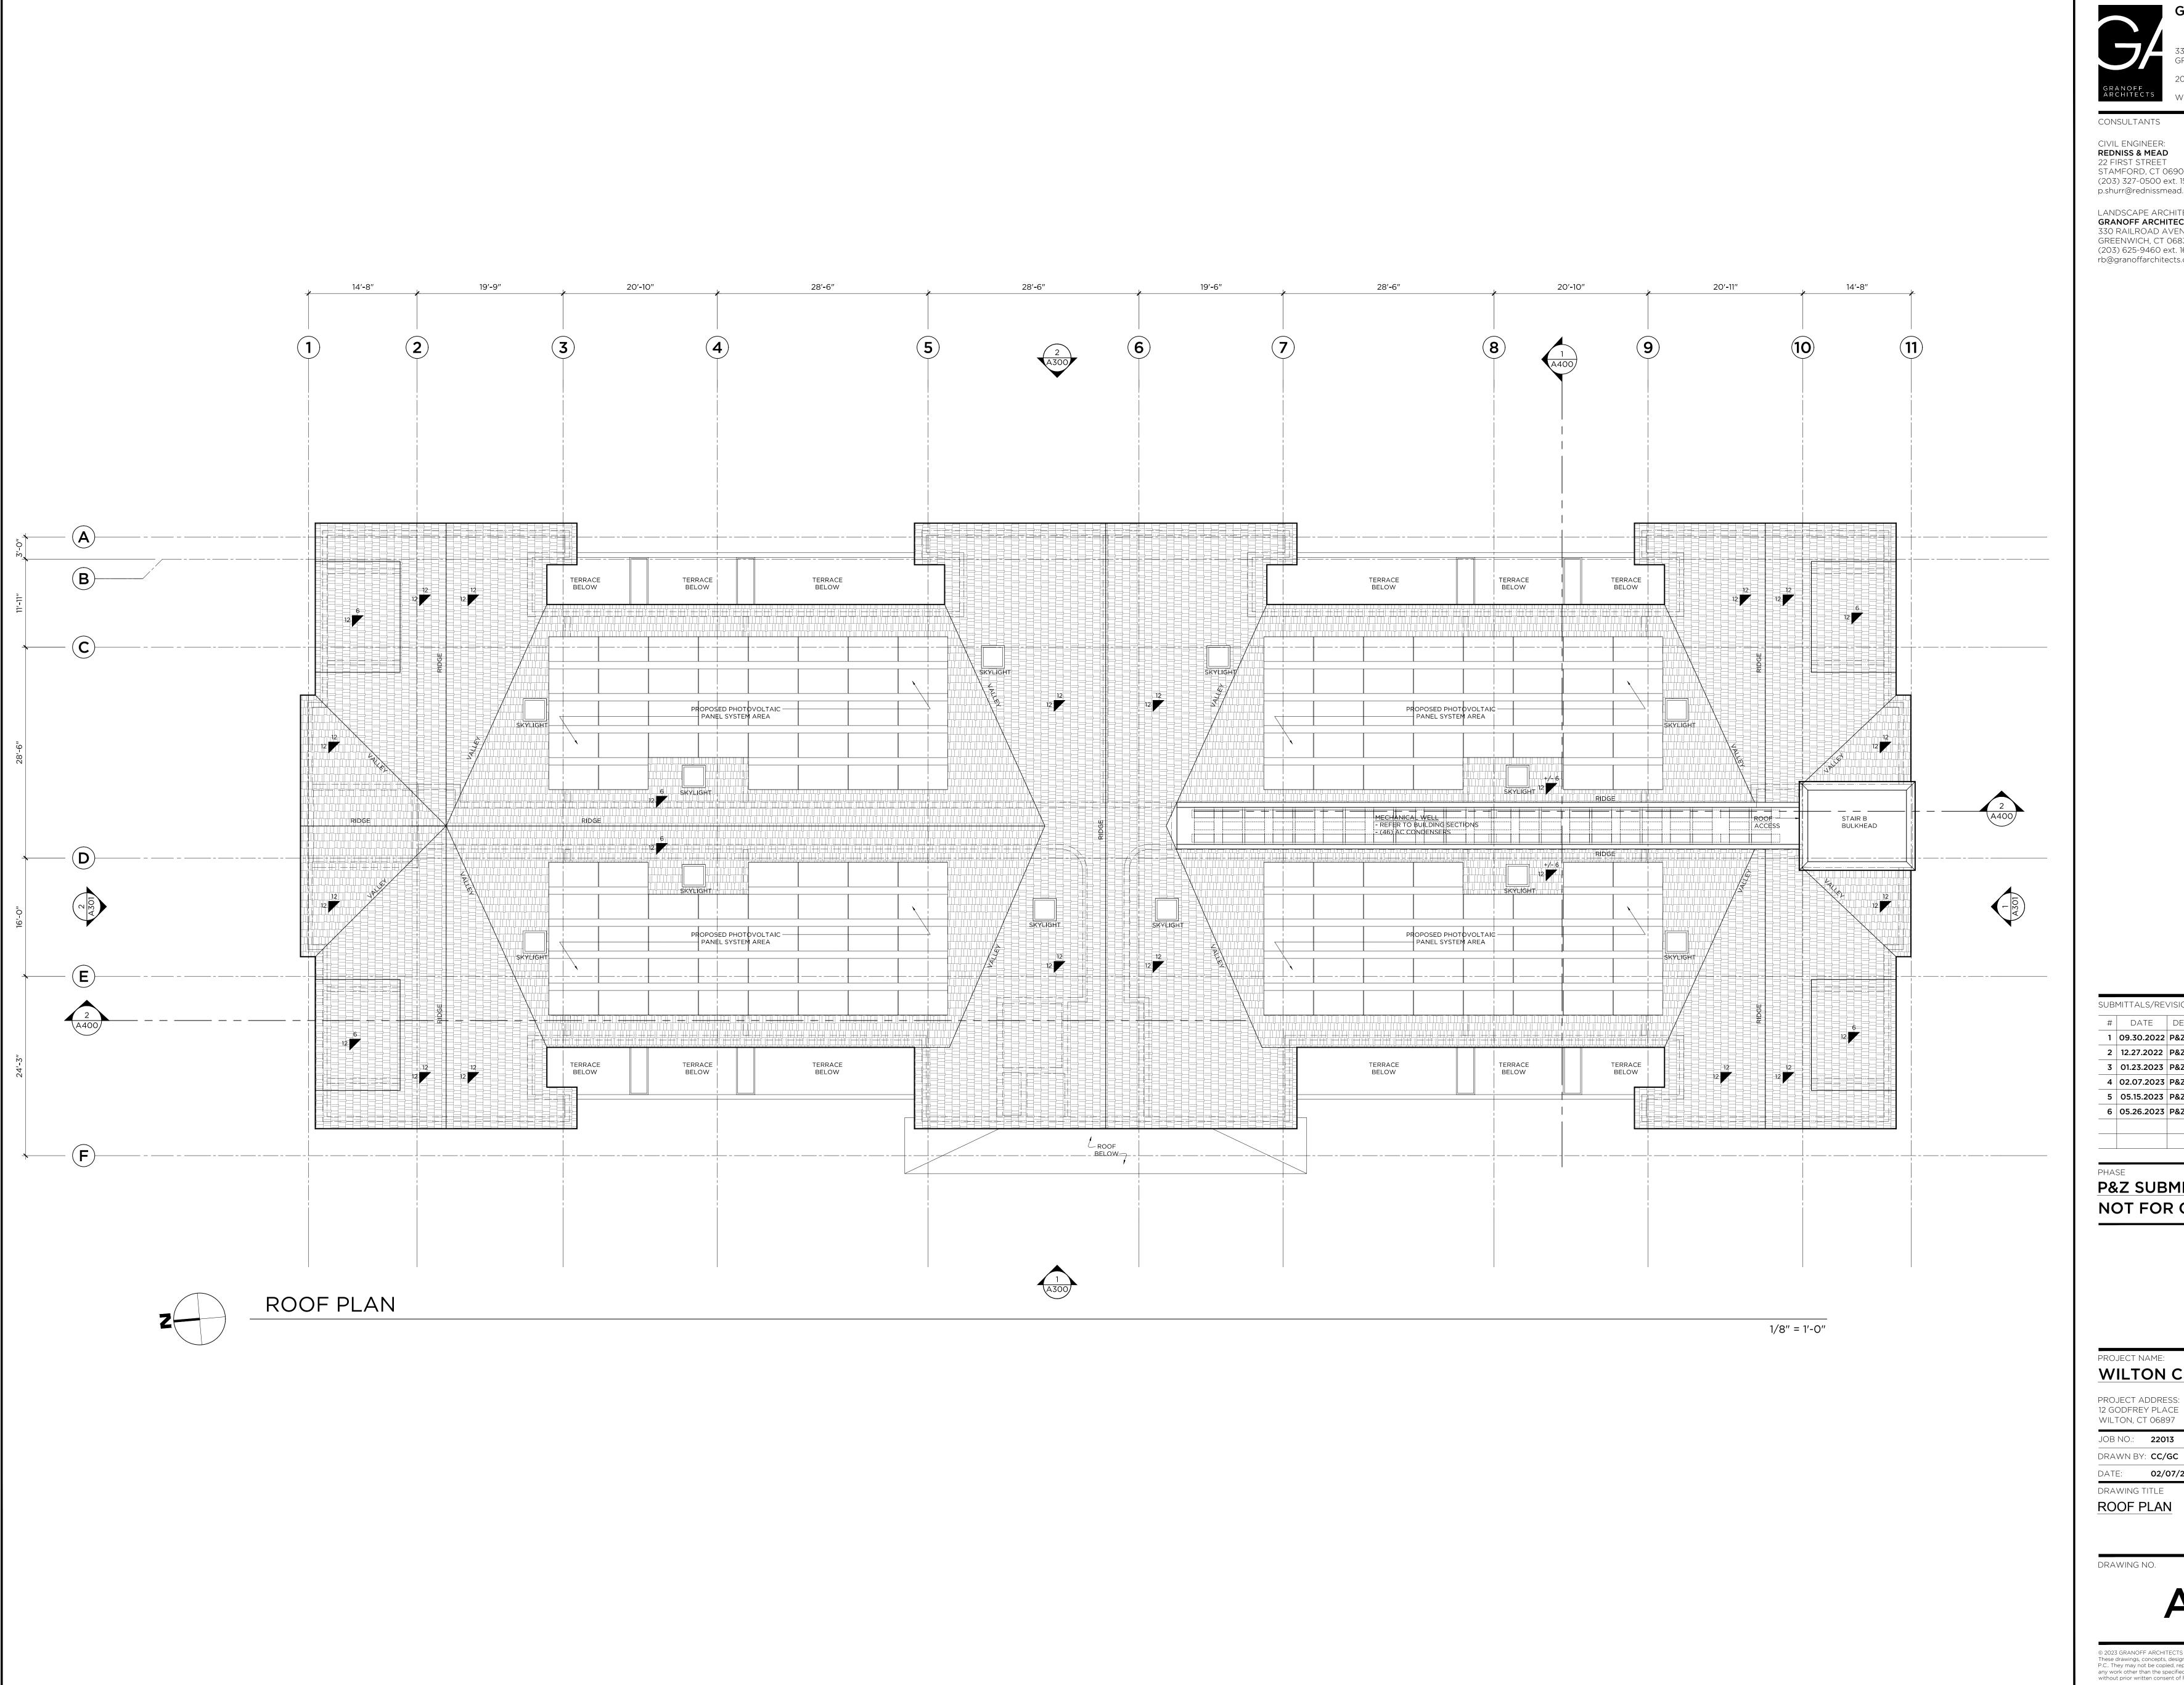

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WILTON CENTER LOFTS


12 GODFREY PLACE

JOB NO.: **22013**

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ROOF PLAN



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WILTON CENTER LOFTS
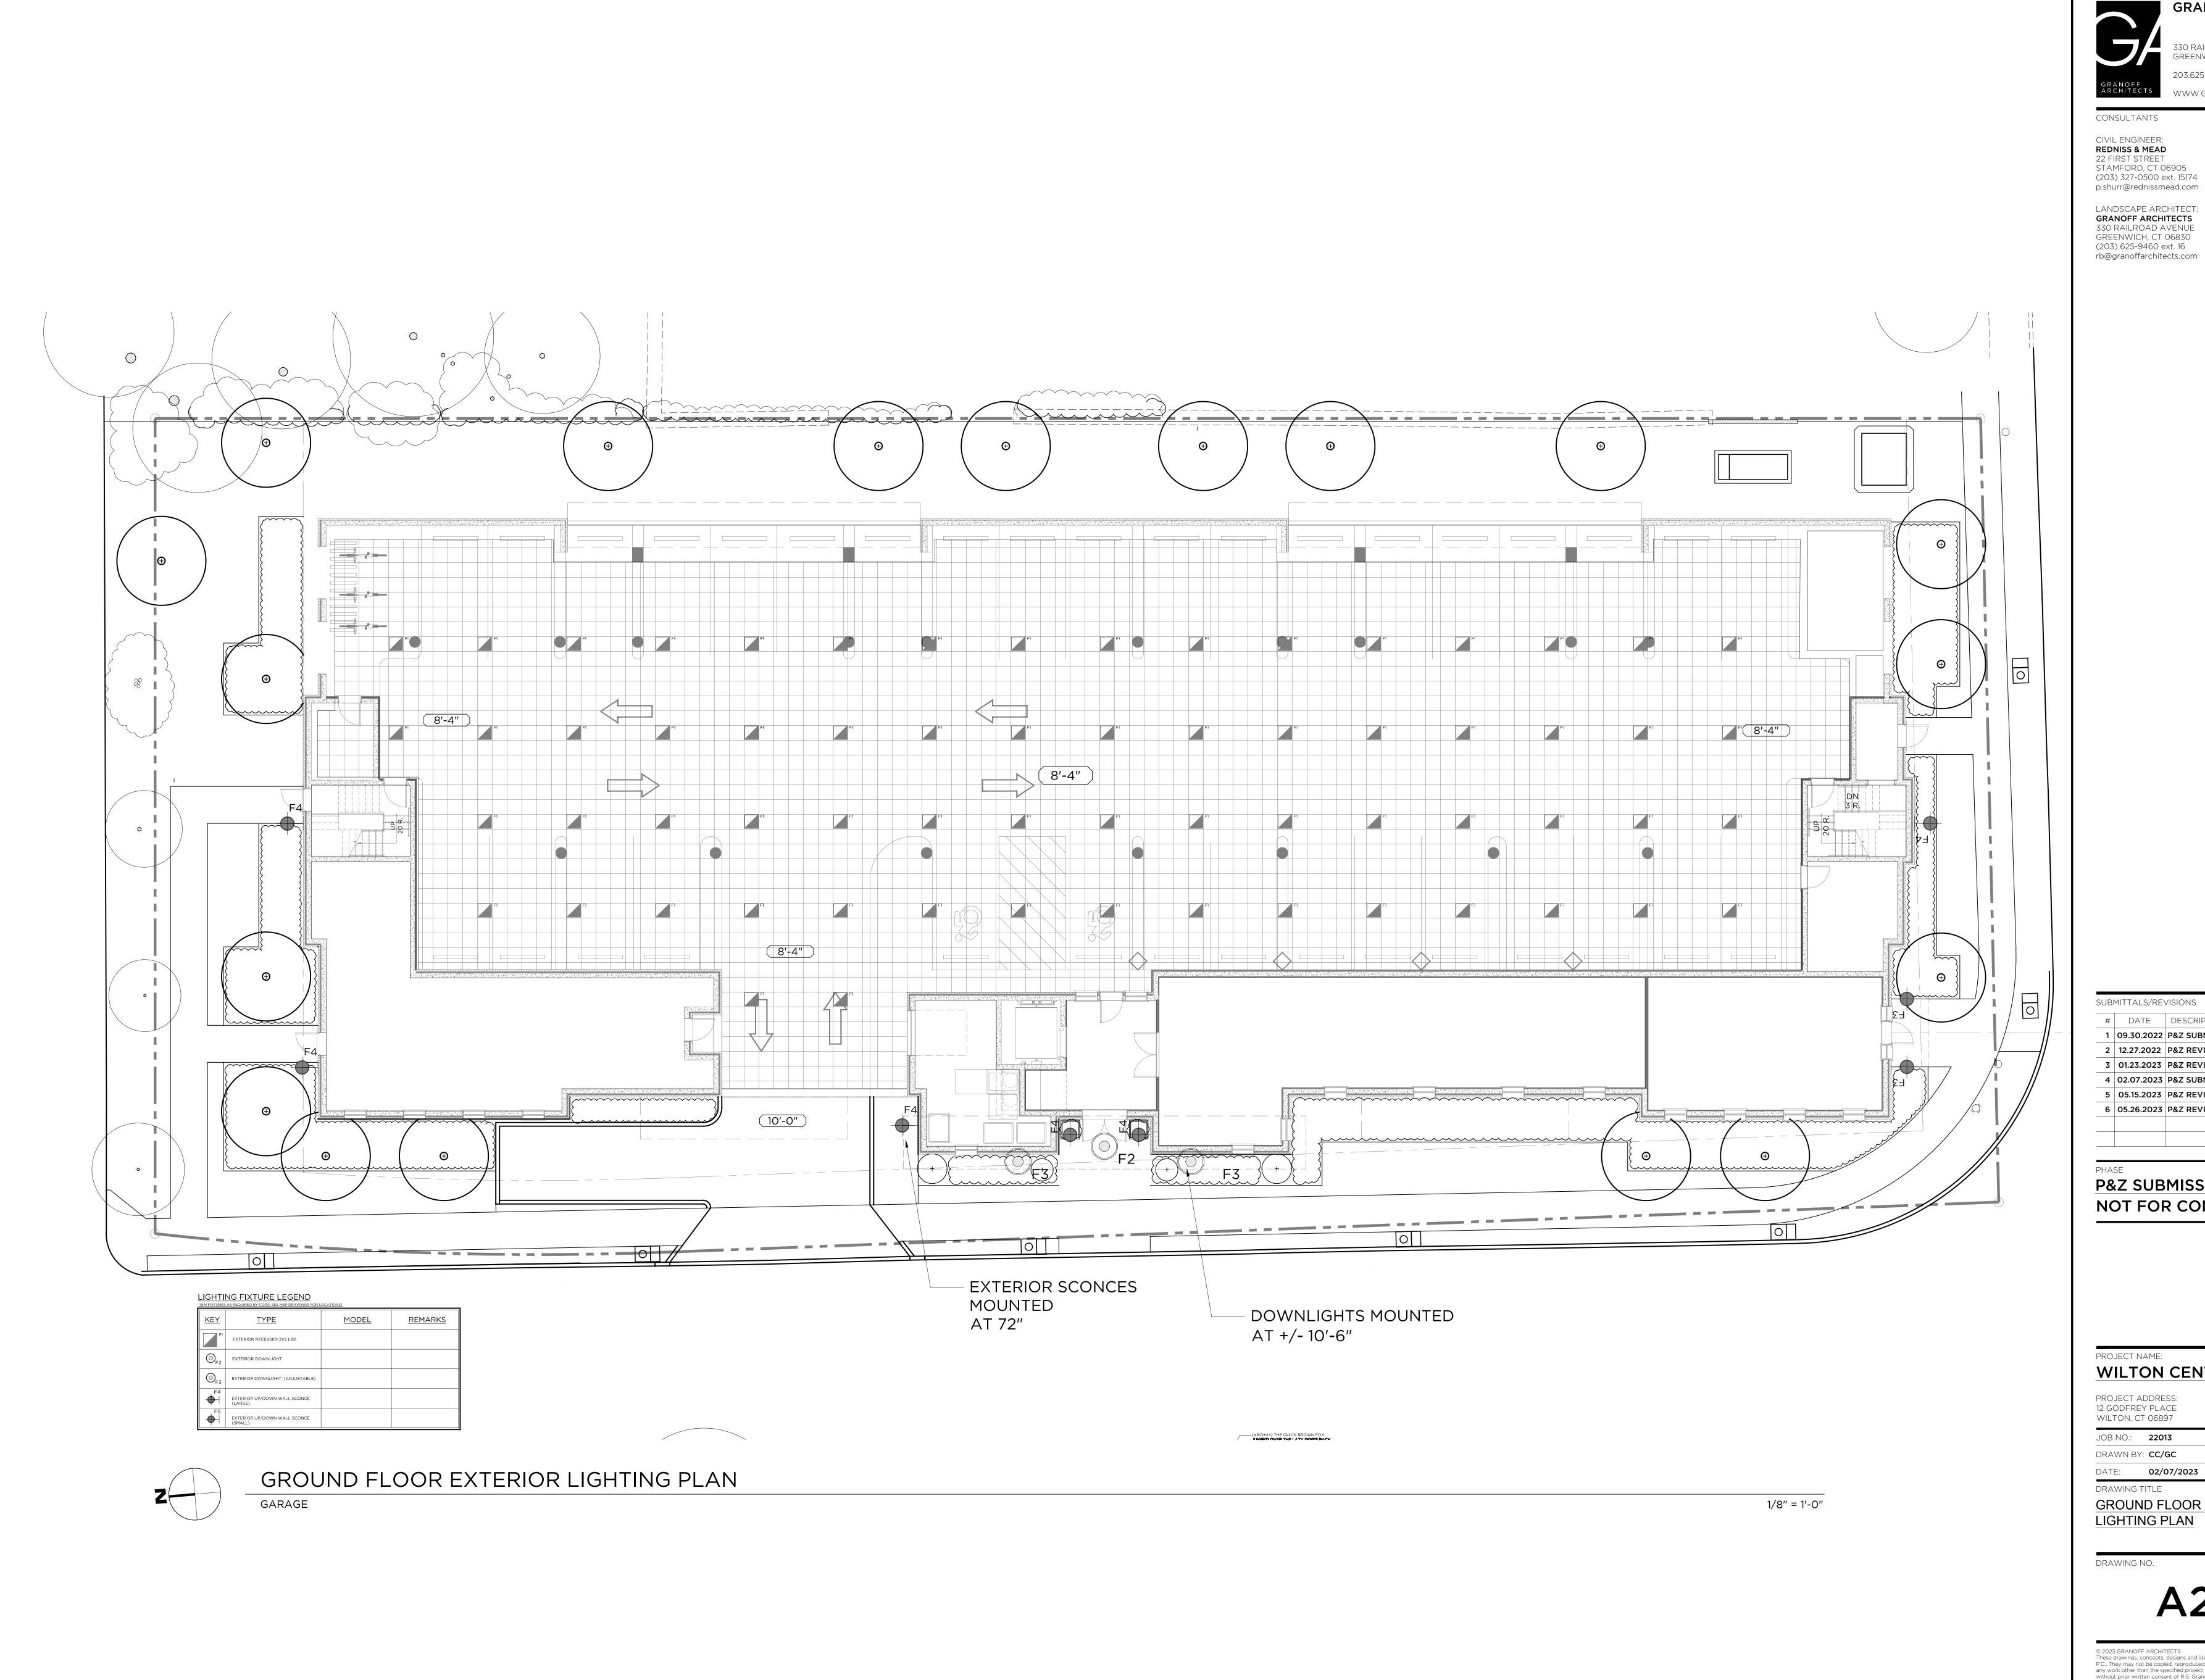
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JOB NO.: **22013** DRAWN BY: CC/GC PROJ. MANAGER: **RG**

DATE: **02/07/2023** SCALE: AS NOTED DRAWING TITLE

GROUND FLOOR EXTERIOR LIGHTING PLAN



LIGHTING FIXTURE LEGEND

<u>TYPE</u>

EXTERIOR RECESSED 2X2 LED

EXTERIOR DOWNLIGHT (ADJUSTABLE)

EXTERIOR UP/DOWN WALL SCONCE

MODEL

FIRST FLOOR EXTERIOR LIGHTING PLAN

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FIRST FLOOR EXTERIOR LIGHTING

DRAWING NO.


1/8" = 1'-0"

A201





KEY	<u>TYPE</u>	MODEL	REMARKS
F1	EXTERIOR RECESSED 2X2 LED		
⊙ _{F2}	EXTERIOR DOWNLIGHT		
⊙ _{F3}	EXTERIOR DOWNLIGHT (ADJUSTABLE)		
F4	EXTERIOR UP/DOWN WALL SCONCE (LARGE)		
F5	EXTERIOR UP/DOWN WALL SCONCE (SMALL)		

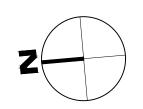

SECOND FLOOR EXTERIOR LIGHTING PLAN

1/8" = 1'-0"

GRANOFF ARCHITECTS

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CONSULTANTS

CIVIL ENGINEER: **REDNISS & MEAD** 22 FIRST STREET STAMFORD, CT 06905 (203) 327-0500 ext. 15174 p.shurr@rednissmead.com

LANDSCAPE ARCHITECT: **GRANOFF ARCHITECTS**330 RAILROAD AVENUE GREENWICH, CT 06830 (203) 625-9460 ext. 16 rb@granoffarchitects.com

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1	09.30.2022	P&Z SUBMISSION	
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3	01.23.2023	P&Z REVISIONS	
4	02.07.2023	P&Z SUBMISSION (8-30g)	
5	05.15.2023	P&Z REVISIONS (8-30g)	
6	05.26.2023	P&Z REVISIONS (8-30g)	

P&Z SUBMISSION (8-30G) NOT FOR CONSTRUCTION

WILTON CENTER LOFTS

PROJECT ADDRESS: 12 GODFREY PLACE WILTON, CT 06897

JOB NO.: **22013**

DRAWN BY: CC/GC PROJ. MANAGER: **RG** DATE: **02/07/2023** SCALE: AS NOTED

DRAWING TITLE

SECOND FLOOR EXTERIOR LIGHTING PLAN

DRAWING NO.

A202





KEY	TYPE	MODEL	REMARKS
F1	EXTERIOR RECESSED 2X2 LED		
⊙ _{F2}	EXTERIOR DOWNLIGHT		
⊙ _{F3}	EXTERIOR DOWNLIGHT (ADJUSTABLE)		
F4	EXTERIOR UP/DOWN WALL SCONCE (LARGE)		
F5	EXTERIOR UP/DOWN WALL SCONCE (SMALL)		



PENTHOUSE EXTERIOR LIGHTING PLAN

1/8" = 1'-0"

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WILTON CENTER LOFTS

PROJECT ADDRESS: 12 GODFREY PLACE WILTON, CT 06897

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DRAWN BY: CC/GC PROJ. MANAGER: **RG** DATE: **02/07/2023** SCALE: AS NOTED

DRAWING TITLE THIRD FLOOR EXTERIOR LIGHTING

DRAWING NO.



(14) ALUMN. RAILING SYSTEM HORIZ.

PREFINISHED (TRUEXTERIOR OR APPROVED EQ.) POLYASH BEADBOARD V-GROOVE SOFFIT

GREY

GREY

RECANGULAR EXTERIOR WALL SCONCE SEE LIGHTING PLAN FOR DETAILS

RECANGULAR EXTERIOR WALL SCONCE SEE LIGHTING PLAN FOR DETAILS

(16) POLYASH V-GROOVE SOFFIT

(15) POLY ASH BRACKETS

(17) METAL CHIMNEY CAP (18) EXT. WALL SCONCE 4"

(19) EXT. WALL SCONCE 6"

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2 12.27.2022 P&Z REVISIONS CC
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4 02.07.2023 P&Z SUBMISSION (8-30g) CC
5 05.15.2023 P&Z REVISIONS (8-30g) CC
6 05.26.2023 P&Z REVISIONS (8-30g) CC

P&Z SUBMISSION (8-30G)
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PROJECT NAME:

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DATE: 02/07/2023 SCALE: AS NOTED


DRAWING TITLE

WEST & EAST ELEVATION

DRAWING NO.

1300



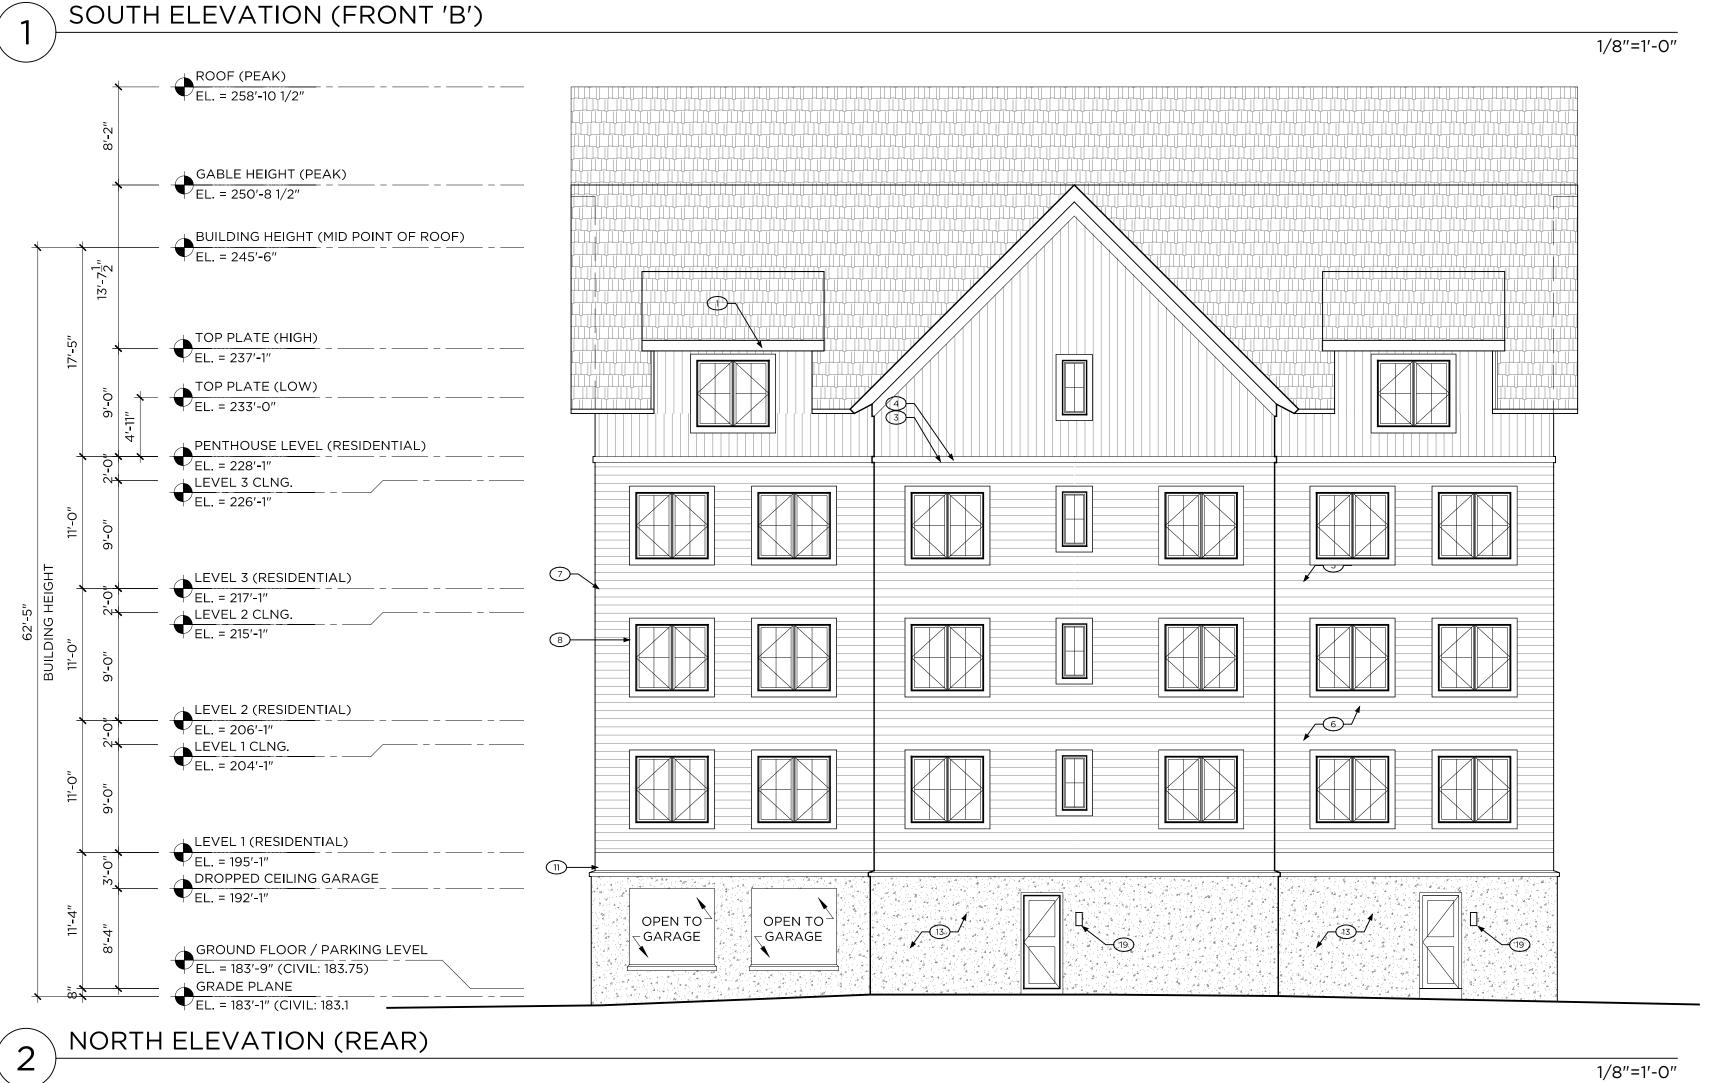

EM#	COMPONENT	MATERIAL AND FINISH	NOTES
1 MET.	TAL ROOFING	ASPHALT SHINGLE ROOF	CHARCOAL
2 HAL	_F ROUND GUTTER SYSTEM	HALF ROUND GUTTER W/ DOWNSPOUTS - PAINTED WHITE TO MATCH TRIM	
3 1x FA	FASCIA BOARD	1x POLY ASH (BORAL 'TRUEXTERIOR' OR SIM.) FASCIA BOARD - PAINTED (COLOR - T.B.D.)	
4 12" F	FRIEZE BOARD	1x POLY ASH (BORAL 'TRUEXTERIOR' OR SIM.) FASCIA BOARD - PAINTED (COLOR - T.B.D.)	
5 POL	Y ASH NICKEL GAP SIDING	PREFINISHED (TRUEXTERIOR OR APPROVED EQ.) W/ 7" EXPOSURE (COLOR: T.B.D.)-VERTICAL	WHITE- VERTICAL ORIENTATION
6 POL	Y ASH NICKEL GAP SIDING	PREFINISHED (TRUEXTERIOR OR APPROVED EQ.) W/ 7" EXPOSURE (COLOR: T.B.D.)-HORIZONTAL	WHITE- HORIZONTAL ORIENTATION
7 TRA	ANSITION TRIM	$\frac{5}{4}$ x6 POLY ASH TRIM BOARD (BORAL 'TRUEXTERIOR' OR SIM.) - PAINTED (COLOR - T.B.D.)	
8 WIN	NDOW TRIM	$\frac{5}{4}$ x6 POLY ASH TRIM BOARD (BORAL 'TRUEXTERIOR' OR SIM.) - PAINTED (COLOR - T.B.D.)	
9 POL	_Y ASH RAILING SYSTEM	RAILING SYSTEM (BORAL 'TRUEXTERIOR' OR SIM.) - PAINTED (COLOR - T.B.D.)	
10 5 ½"	CORNER TRIM BOARD	POLY ASH TRIM BOARD (BORAL 'TRUEXTERIOR' OR SIM.) - PAINTED (COLOR - T.B.D.)	
11 18" V	WATERTABLE TRIM BOARD	1x POLY ASH (BORAL 'TRUEXTERIOR' OR SIM.) FASCIA BOARD - PAINTED (COLOR - T.B.D.)	
12 SLO	OPED MASONRY CAP	CAST-STONE MASONRY	
13 CON	NCRETE BASE	STUCCO/CEMENT PARGE	GREY
14 ALUI	JMN. RAILING SYSTEM HORIZ.		
15 POL	Y ASH BRACKETS		
16 POL	YASH V-GROOVE SOFFIT	PREFINISHED (TRUEXTERIOR OR APPROVED EQ.) POLYASH BEADBOARD V-GROOVE SOFFIT	
17 META	AL CHIMNEY CAP		
18 EXT.	. WALL SCONCE 4"	RECANGULAR EXTERIOR WALL SCONCE SEE LIGHTING PLAN FOR DETAILS	GREY
(19) EXT.	. WALL SCONCE 6"	RECANGULAR EXTERIOR WALL SCONCE SEE LIGHTING PLAN FOR DETAILS	GREY



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1 (09.30.2022	D&7 SURMISSION	
		FAZ SUBINISSIUN	CC
2	12.27.2022	P&Z REVISIONS	cc
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6	05.26.2023	P&Z REVISIONS (8-30g)	cc

P&Z SUBMISSION (8-30G)

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PROJECT NAME:

WILTON CENTER LOFTS

PROJECT ADDRESS: 12 GODFREY PLACE WILTON, CT 06897

JOB NO.: **22013**

DRAWN BY: **CC/GC** PROJ. MANAGER: **RG** DATE: **02/07/2023** SCALE: AS NOTED

DRAWING TITLE

SOUTH & NORTH ELEVATIONS

DRAWING NO.



RENDERING-WEST ELEVATION



■ RENDERING-MAIN ENTRY WEST ELEVATION

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WILTON CENTER LOFTS

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JOB NO.: **22013** DRAWN BY: CC/GC

PROJ. MANAGER: **RG** DATE: **02/07/2023** SCALE: AS NOTED DRAWING TITLE

EXTERIOR RENDERINGS

DRAWING NO.

A302



■ RENDERING-CORNER GODFREY AND HUBBARD

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PHASE

P&Z SUBMISSION (8-30G)
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DATE: 02/07/2023 SCALE: AS NOTED

DRAWING TITLE


EXTERIOR RENDERINGS

DRAWING NO.

Δ302Δ



■ ASPHALT ROOF SHINGLES - CHARCOAL

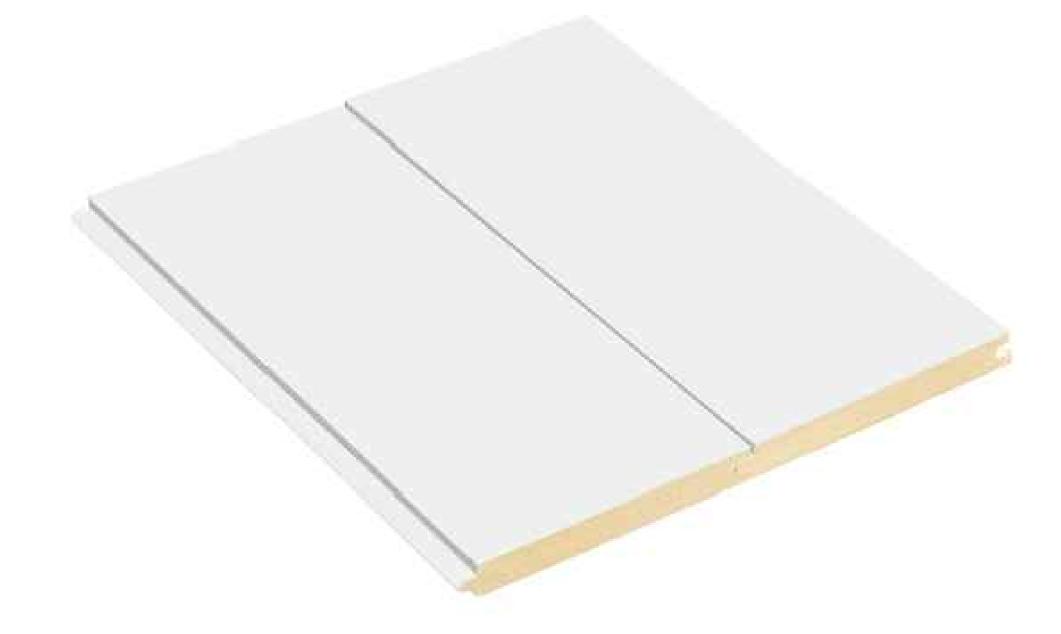

■ POLYASH (TRUEXTERIOR) NICKEL GAP SIDING WHITE



■ ALUMINUM CLAD WOOD CASEMENT WINDOW-2 OVER 2-CHARCOAL



■ GALVANIZED HALF ROUND GUTTERS




■ 1X POLYAASH TRIM FOR FASCIA RAILINGS AND TRIM



■ METAL LINEAR BAR RAILING HORIZONTAL -CHARCOAL



■ LINEAR EXTERIOR WALL SCONCE-CHARCOAL

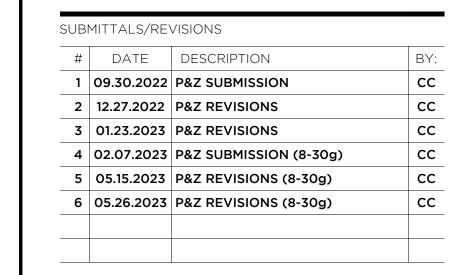

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PHAS

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DRAWING TITLE

EXTERIOR MATERIALS


DRAWING NO.

A303

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■ CEMENT PARGE/STUCCO BASE - LIGHT GRAY



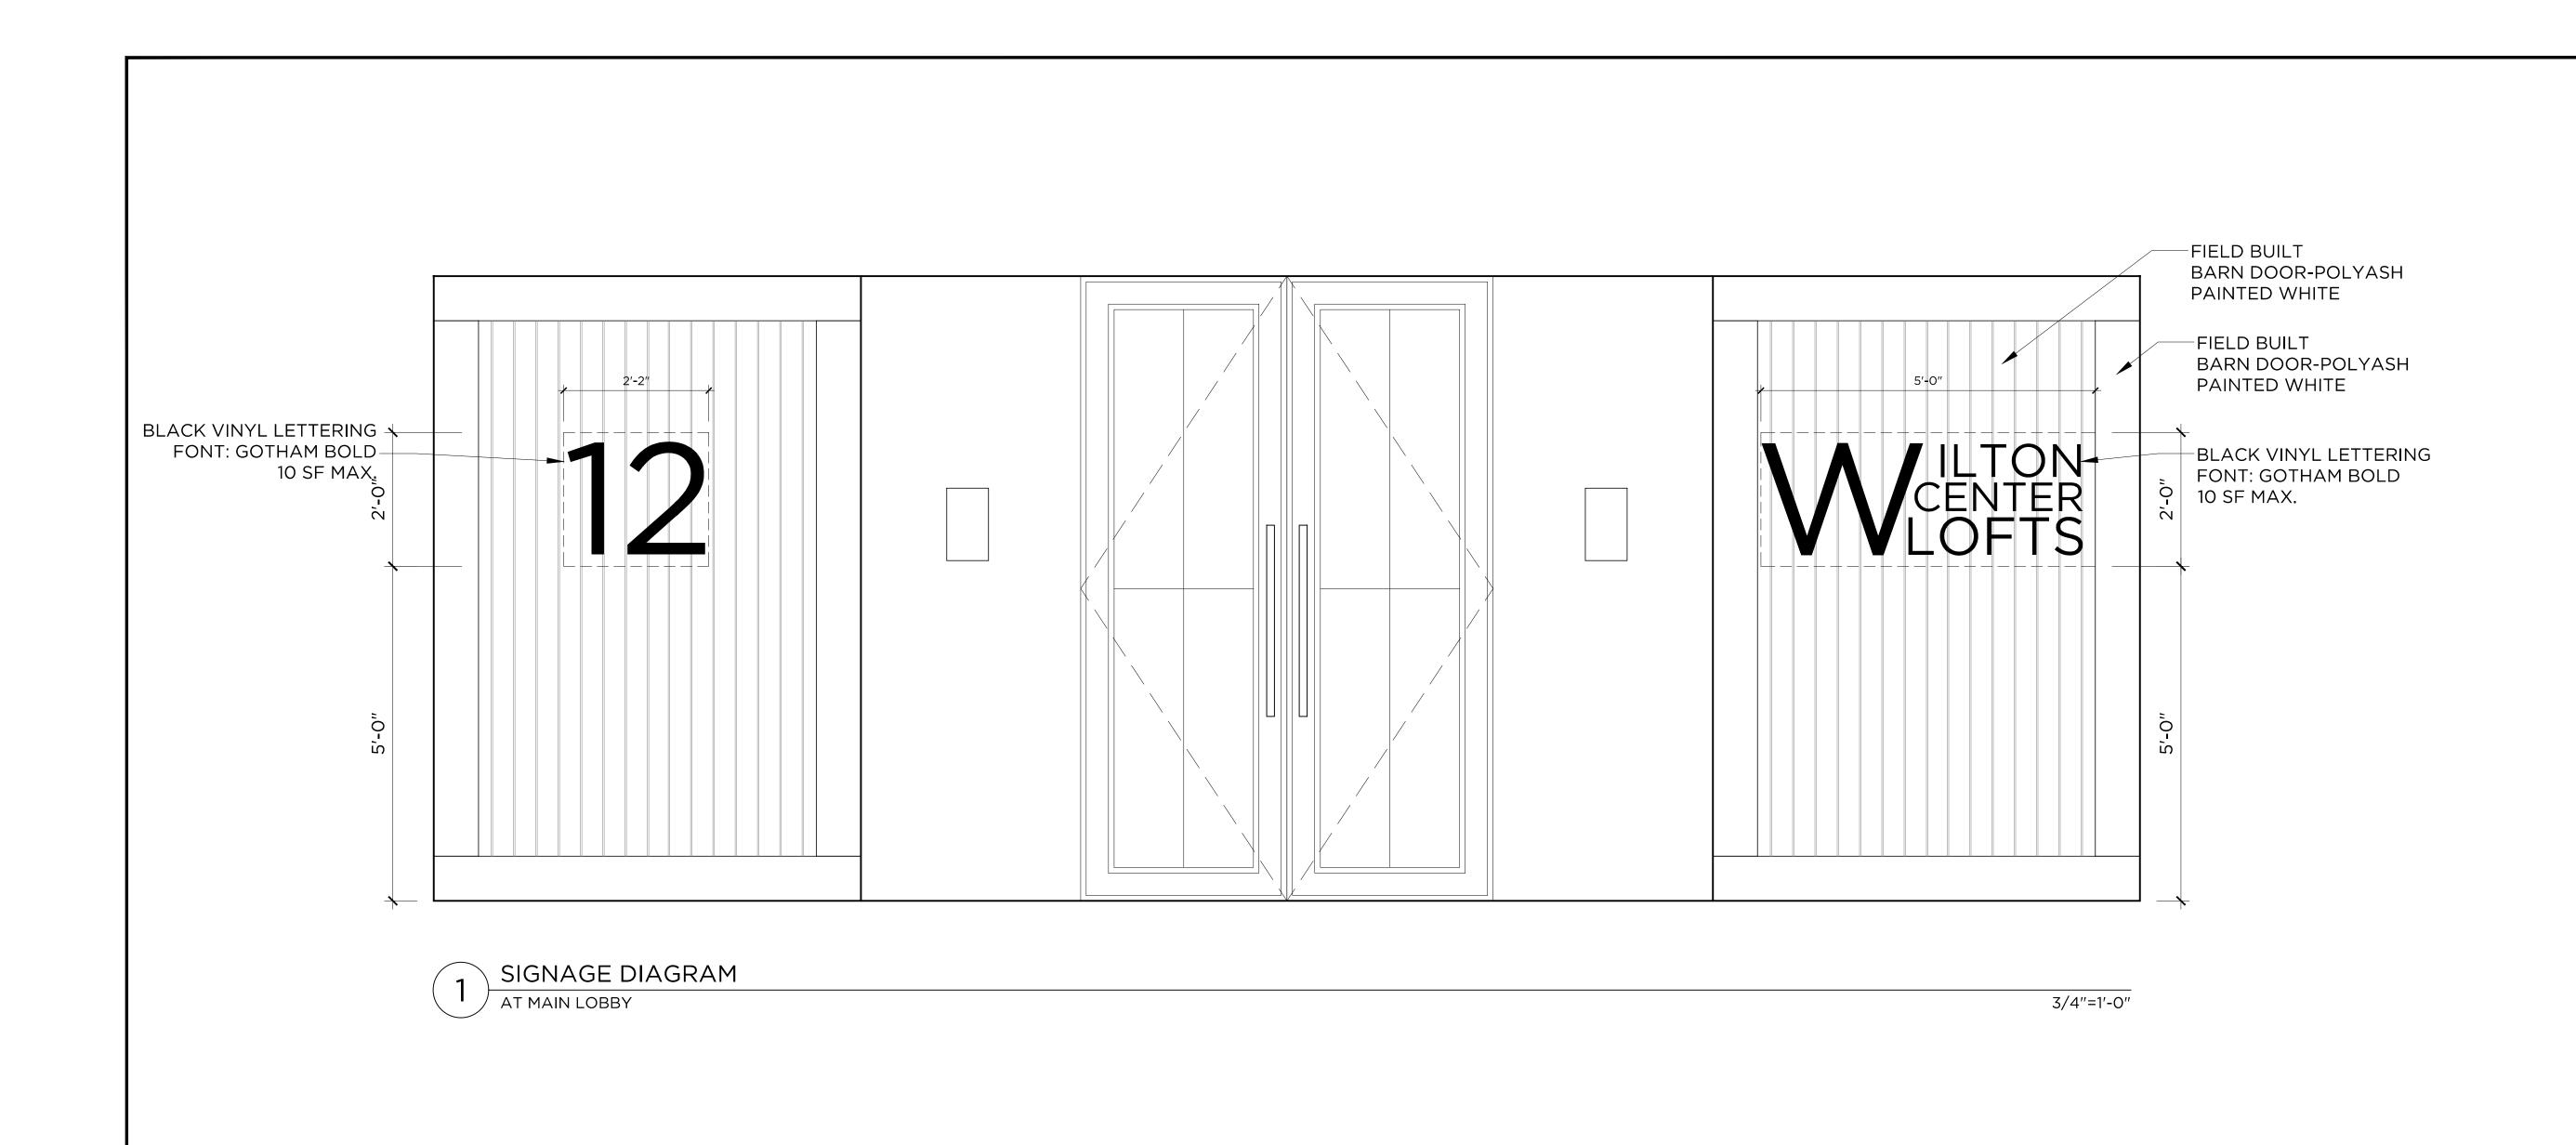

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P&Z SUBMISSION (8-30G) NOT FOR CONSTRUCTION

PROJECT NAME:


WILTON CENTER LOFTS

PROJECT ADDRESS: 12 GODFREY PLACE WILTON, CT 06897

JOB NO.: **22013** DRAWN BY: **CC/GC** PROJ. MANAGER: **RG** DATE: **02/07/2023** SCALE: AS NOTED

DRAWING TITLE SIGNAGE

DRAWING NO.

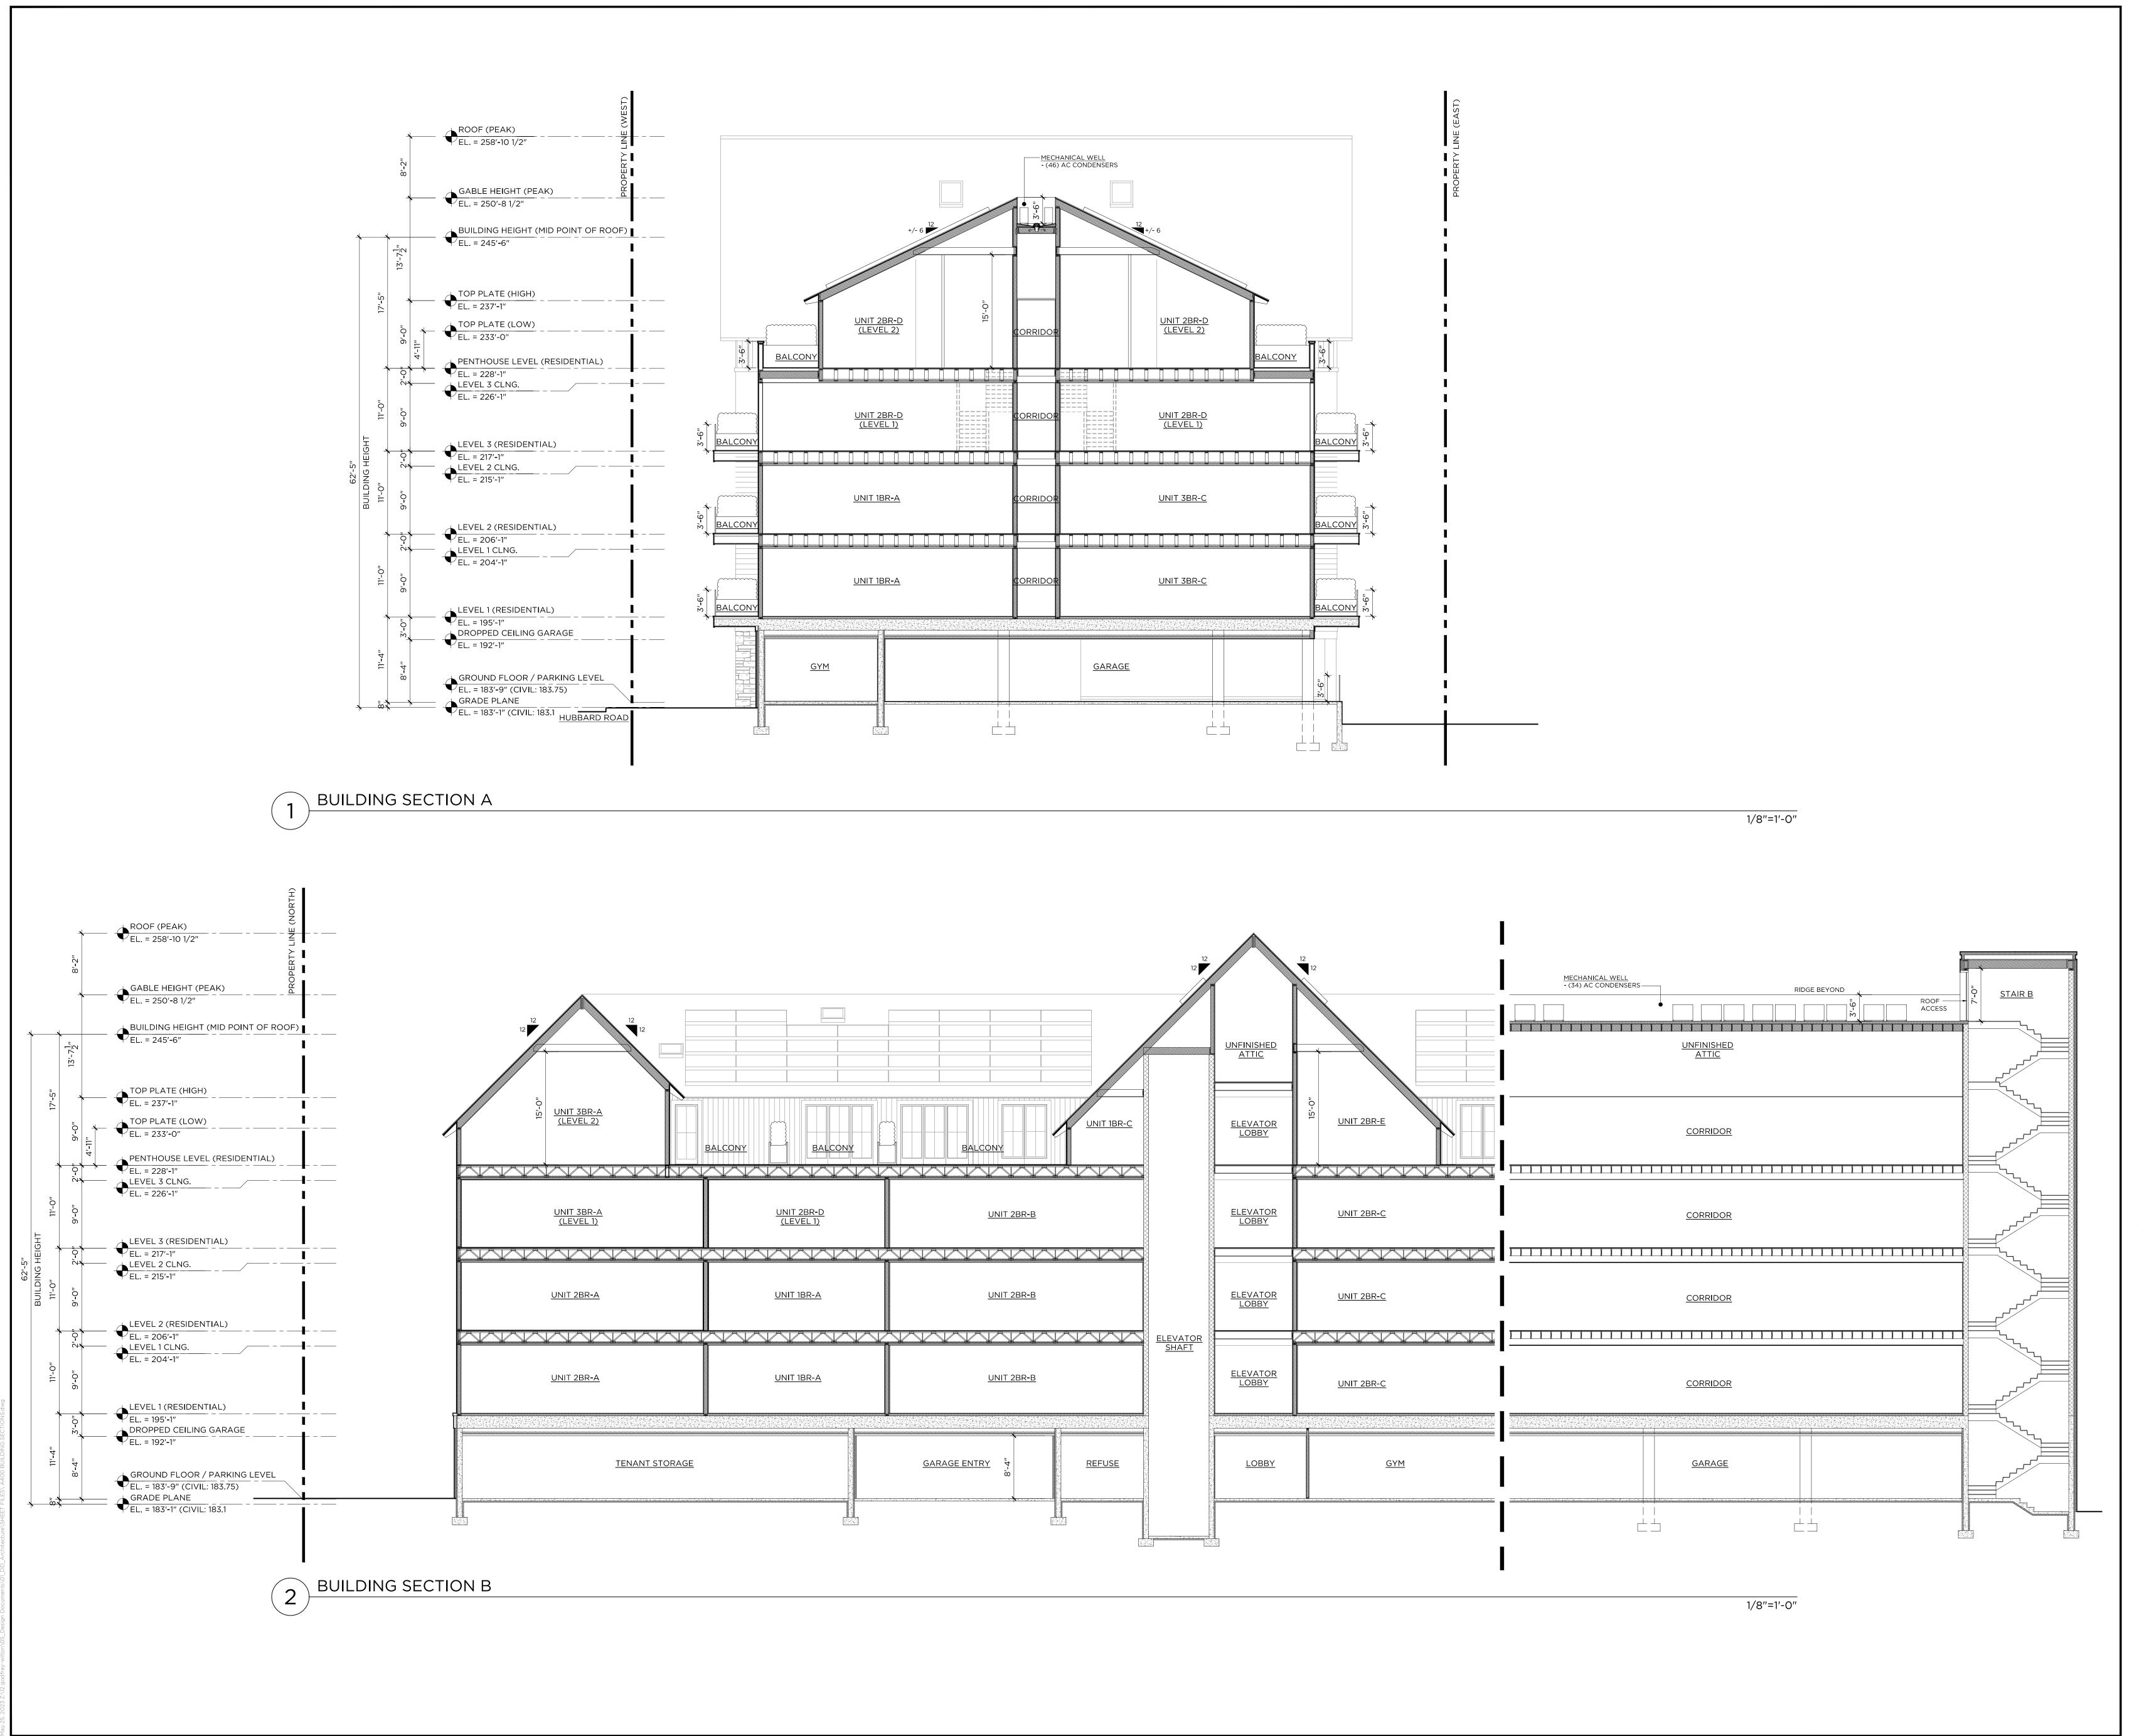

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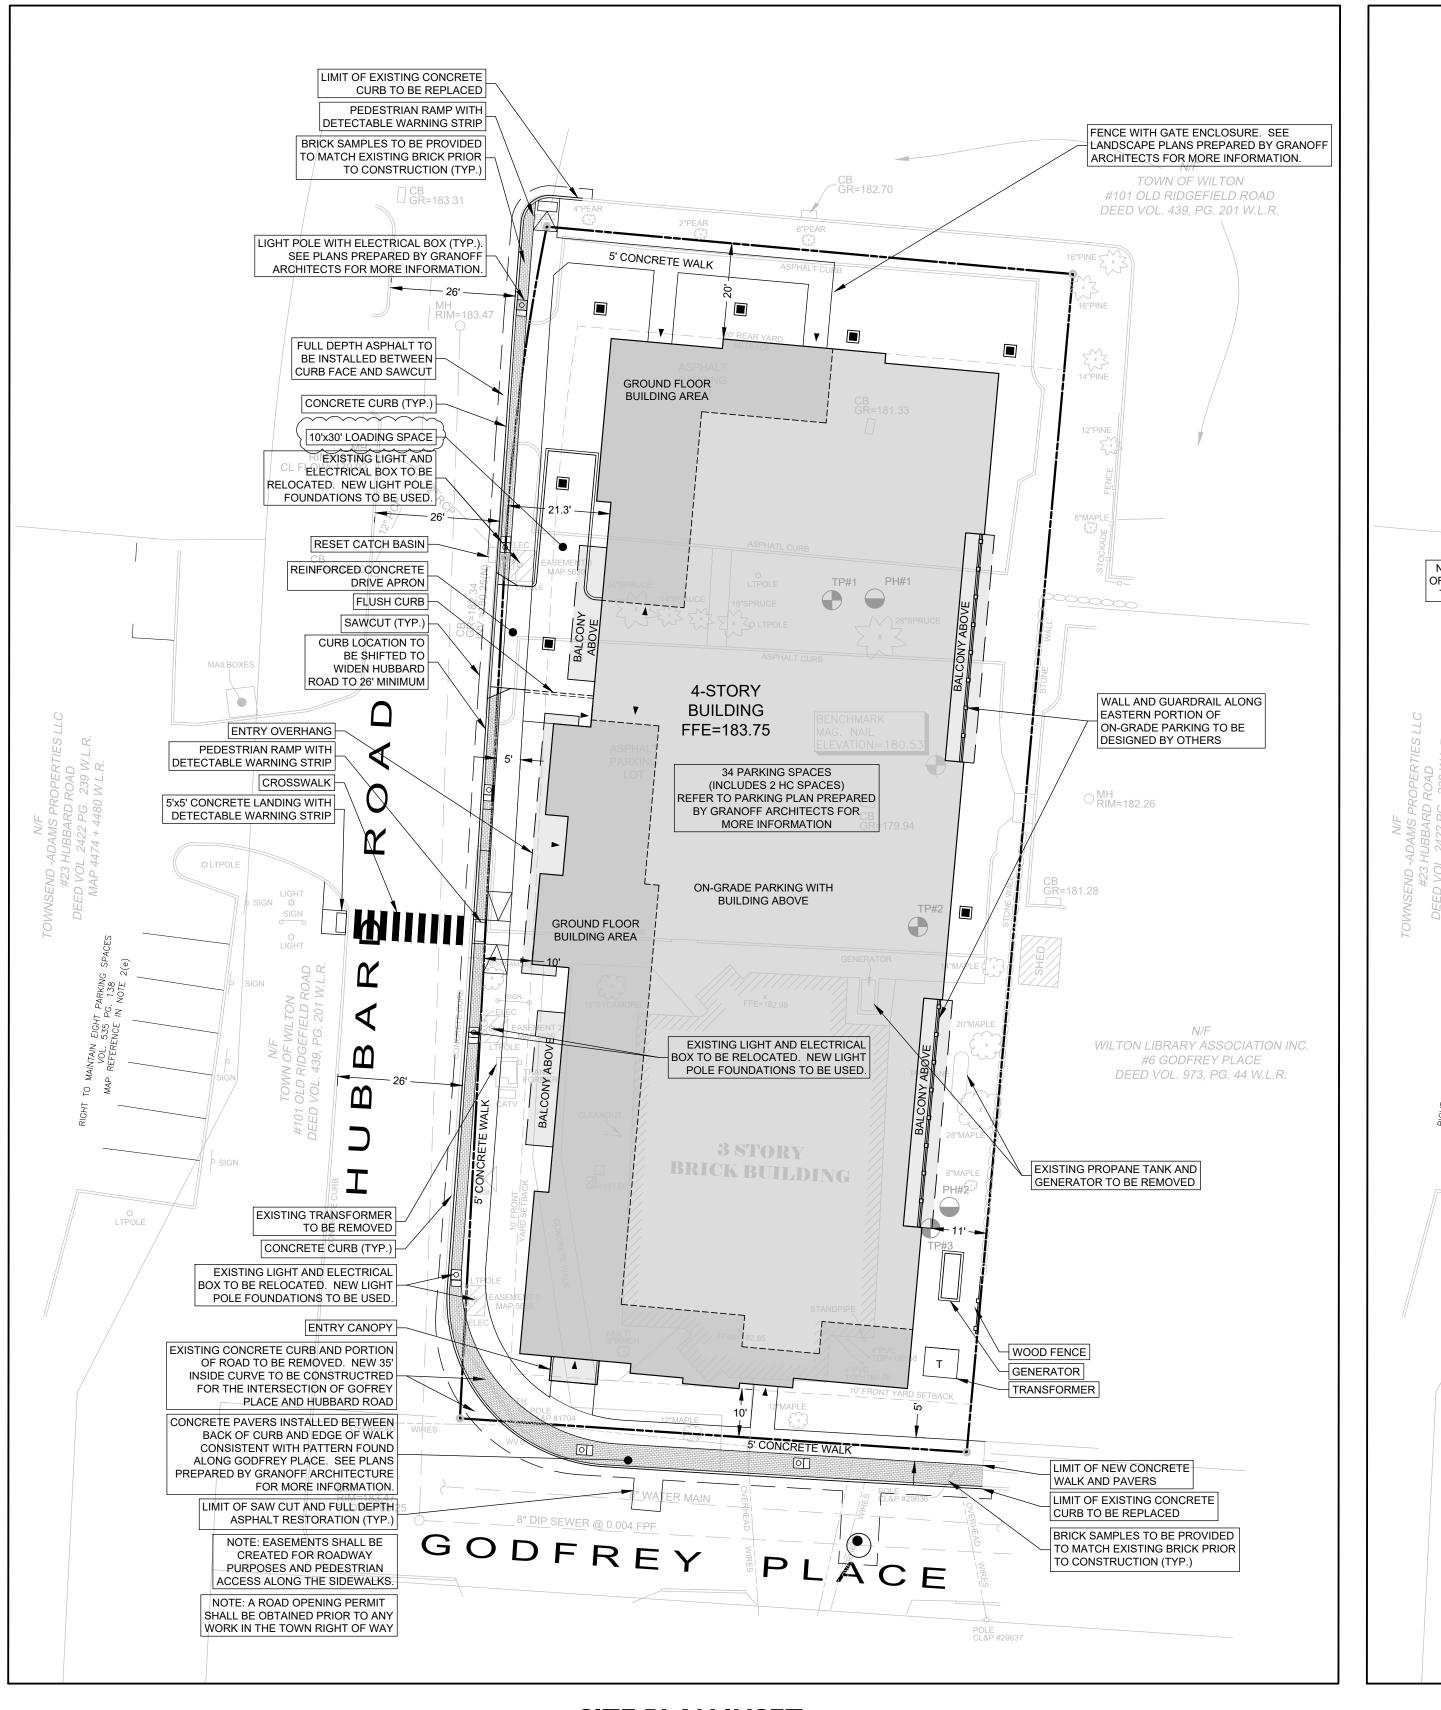
DATE: 02/07/2023 SCALE: AS NOTED

DRAWING TITLE

BUILDING SECTIONS

DRAWING NO.

4400



22 LF OF 6" PVCP @ 0.020 FPF AREA DRAIN (AD#3) JUNCTION BOX (JB#3) INV.OUT=180.50 (AD#2) INV.IN=179.40 (AD#1) SUMP=178.50 INV IN=179 40 (AD#2) 27 LF OF 6" PVCP @ 0.020 FPF INV.OUT=179.30 (INF#1 30 LF OF 6" PVCP @ 0.028 FPF AREA DRAIN (AD#2) 40 LF OF 6"PVCP@ 0.020 FPF INV.IN=179.95 (AD#3) INV.OUT=179.85 (JB#3) SUMP=177.85 DEED VOL. 439. PG. 201 W.L.R TC=183.85 BC=183.35 AREA DRAIN (AD#1) RIM=182 50 INV.OUT=180.25 (JB#3 TC=183.64 SUMP=178.25 BC=183.14 6 LF OF 6" PVCP @ ¹/₄" PER FOOT MIN. 183.75 JUNCTION BOX (JB#2) RIM=183.60 INV.IN=180.80 (JB#1) INV.IN=180.80 (FOOT) INV.OUT=180.70 (EX.MH) FOOTING DRAIN INV.=180.95 (MIN.) -26 LF OF 6" PVCP @ $\frac{1}{4}$ " PER FOOT MIN. INV.=180.00 ACCESS MANHOLE (TYP.) 28 LF OF 6" PVCP @ 0.025 FPF TC=183.10 BC=182.60 TW=183.75 BW=183.50 NOTE: NO FOOTING DRAINS OR SUMPS SHALL DISCHARGE TL=182.52 TO THE SANITARY SEWER. 31 LF OF 6" PVCP @ 0.015 FPF RETAIN-IT UNITS (INF#1 JUNCTION BOX (JB#1) RIM=183°35 GRADF=183 75 INV.OUT=180.50 (INF#1) 183.20 TOP UNIT=182.65 BOTT UNIT=177.00 INV.OUT=181.25 (EX.CB) BOTT. STONE=176.50 INV.IN=178.90 (AD#4) BUILDING INV.IN=179.70(ROOF FFE=183.75 INVIN=179.70 (JB#1) INV.IN=178.50 (JB#3) TC=183.30 EX.=182.00 BC=182.80 TC=183.40 29 LF OF 6" PVCP @ $\frac{1}{4}$ " PER FOOT MIN. 29 LF OF 6" PVCP @ 0.020 FPF INV.=181.25 AREA DRAIN (AD#4) RIM=182.00 TC=183.65 INV.OUT=179.50 (INFIL#1 BC=183.15 SUMP=177.50 WILTON LIBRARY ASSOCIATION INC #6 GODFREY PLACE DEED VOL. 973. PG. 44 W.L.R. BW=181.00 EX.=180.80 BW=180.80 BRICK R ALL ROOF DRAINS ARE TRIBUTARY ONE (1) - 2" PVCP ELECTRICAL CONDUITS TO THE INFILTRATION SYSTEM FOR SIDEWALK LIGHTING (TYP.) ALL COVERED FLOOR DRAINS MUST BE TREATED VIA AN BC=184.25 OIL-GRIT SEPARATOR CONNECTED TO THE SANITARY SYSTEM. 26LF OF 6" PVCP @ $\frac{1}{4}$ " PER FOOT MIN. \vdash TC=184.45 INV.=181.25 BC=183.95 SOURCE OF ELECTRICAL EX.=180.00 SUPPLY FOR STREET LIGHTS TO BE AS DIRECTED BY DPW 181.00 AND VERIFIED IN THE FIELD EX.=179.75 FIRE HYDRANT TO BE | | ELEVATED TO MEET | FINISHED GRADE TC=183.05 SECONDARY ELECTRICAL SERVICE BC=182.55 SANITARY INV =177 50 FIRE PROTECTION SERVICE 33 LF OF 6" PVCP @ 0.022 FPF DOMESTIC WATER SERVICE RIMARY ELECTRICAL SERVICE WATER SERVICE TELE/DATA SERVICE GODFREY SANITARY MANHOLE WITH OUTSIDE DROP CONNECTION RIM=180.50 INV HIGH=176.75 (LATERAL) INV LOW=167.90 (MAIN) FIRE DEPARTMENT CONNECTION

SITE PLAN INSET

	AREA & BULK	CALCULATIONS	3
	Standard	Standards Per Wilton Zoning WC 29-6.E	Proposed Standards Per CGS Sec. 8-30g
1	Minimum Front Yard	10'	10.0'
2	Maximum Front Yard	20'	21.3"
3	Minimum Side Yard (Each)	0'	11.0'
4	Minimum Rear Yard	20'	20.0'
5	Minimum Parking & Loading Setbacks (side & rear yards)	0'	14.4' / 36'
6	Maximum Building Height (Stories/Feet)	3 / 42'	5 Stories / 62.5'1
7	Maximum Building coverage (%)	30	64
8	Maximum Site Coverage (%)	80	76
9	Minimum Lot Size (acres)	No Minimum	0.625 acres (27,246 sf)
12	Maximum Floor Area Ratio (F.A.R)	N/A	2.50 ²
	Maximum Density - (29-6.C.4.b) (Multi-Family)	5 Units / Ac	40 Units (64 Units / Ac)
	Required Affordable Housing Unit	None	30% or 13 Units (Meeting 8-30g Reqs.)

Calculated average grade of 183.10

Use	Rate Per Sec 29-8.B Wilton Zoning	Quantity	Total
Studio or 1-Bedroom Unit (29-8.b.5.a(2))	1.0 / Unit	9 Units	9 Spaces
2 & 3-Bedroom Unit (29-8.b.5.a(2))	2.0 / Unit	31 Units	62 Spaces
Park	ing Standard Per Wilton Zo	ning Regs. 29-8.B	71 Spaces
	42 Spaces ¹		

Includes 8 spaces maintained on 23 Hubbard Road property as depicted in deed of record Vol. 522, Pg. 143. Includes 2 handicap parking spaces.

GRADING & DRAINAGE INSET

- These drawings are intended only to depict the design of site grading, drainage, sanitary, utilities and sediment & erosion controls. These drawings are for approval purposes only. No construction may begin prior to obtaining all necessary permits and approvals.
- All survey data, boundary lines, topography, building locations and area calculations are from a survey prepared by Redniss & Mead, Inc. entitled Property & Topographic Survey dated April 22, 2022 and revised lune 9, 2022. Elevations depicted or labeled are based on NAVD-88.
- Refer to plans prepared by Granoff Architects for information and design of the proposed buildings. These
- drawings depict site plans corresponding to the latest architectural plans received from Granoff Architects received on August 30, 2022.
- Property lies in the Wilton Center District Zone.
- All construction shall comply with the Town of Wilton requirements, the State of Connecticut Basic Building Code Americans with Disabilities Act (ADA), the Connecticut Guidelines for Soil and Erosion and Sediment Control, OSHA, and CT DOT Form 818 (latest edition).
- All development activities to be undertaken within the street right-of-way and other public lands shall comply fully with Town standards unless approved deviation is specifically set forth as part of this application. All work within the State right-of-way will comply with the CT DOT Form 818 with the latest
- special Provisions and Typical State Standard Details. Contractor shall supply complete shop drawings including manufacturer's product data sheets to the Site Engineer, for all construction material used in conjunction with these drawings. Contractor shall allow a 5
- day review period, prior to fabrication and installation. Information on existing utilities has been compiled from various sources including utility company records, municipal record maps and field survey and is not guaranteed to be correct or complete. The contractor is solely responsible for determining actual locations and elevations of all utilities including underground
- 7. The property is served by public water and sewer system.
- 0. Prior to any excavation the Contractor and/or Applicant, in accordance with Public Act 77-350, shall be required to contact "Call Before You Dig" at I-800-922-4455 for mark-out of underground utilities. Dig test pit(s) at utility crossing(s) to check actual clearances with new utilities prior to construction. If conflicts are found the contractor shall notify the engineer, at which time the sewer in question shall be redesigned. If such redesign is not possible, the existing pipes or utilities shall be relocated to avoid the conflict. Such relocation shall be done with knowledge of and in accordance with the owner of the utility.
- It shall be the responsibility of the contractor to provide any excavation safeguards, necessary barricades, flagmen, etc., for traffic control and site safety. All work shall be done in accordance with OSHA requirements. The contractor shall be responsible for compliance with OSHA requirements.
- 12. When preparing the existing site for the proposed development, all materials removed shall be disposed of
- in conformance with all governing agencies. 13. Remove stumps and brush from site, or chip and use during landscaping. Do not bury stumps on site.
- 14. Building elevations are subject to change and shall be finalized prior to building permit.
- 5. Special attention of the contractor is called to the required type and compaction of pipe bedding and backfill specified on these drawings. These requirements will be strictly enforced.
- 16. Prior to issuance of a Certificate of Occupancy, the Engineering Bureau may require a certification letter stating that the development was constructed in accordance to the approved plans, and an "as-built" drawing shall be submitted
- 7. The Contractor is responsible for coordinating with a licensed surveyor to prepare an "as-built" plan. The Contractor is responsible to coordinate with a site engineer 48 hours prior to any inspections
- 8. The Engineering Department and the inspecting engineer shall be notified by the contractor three (3) days prior to the commencement of each phase of construction
- 19. The work shall be done in conformance with the contract documents/plans unless changes have been approved in writing by the design engineer prior to the work being done.
- 20. A preconstruction meeting shall be held with the Owner, Architect and Engineer to review the scope of construction. The Contractor shall be responsible to coordinate the preconstruction meeting.

EARTHWORK & GRADING:

- 21. Grade away from building walls at 2% minimum (typical).
- 22. Earth slopes shall be no steeper than 2:1 (horz.:vert.)
- 23. General fill beyond paved areas shall be free of brush rubbish, stumps and stones larger than 8". Fill shall be placed in compacted layers not to exceed 8" in thickness. The dry density after compaction shall not be less than 95% of the Standard Proctor Test and done in accordance with the requirements of ASTM D698. After compacting, the fill shall be 4" below the required grade as shown on the plan
- 24. General fill may be till, loam, sand or gravel mixture classified as SP, SW, SM, GP, GM, ML per the United Soil Classification System. It shall have not more than 40% fines passing the #100 sieve, not more than 8% passing the #200 sieve, and no stones larger than 8".
- Subgrade and fill shall be uniformly compacted by the use of equipment manufactured for that purpose. Rollers shall deliver a ground pressure of not less than 300 pounds per linear inch of contact width and weigh not less than 10 tons. Vibratory units shall have a static weight of not less than 4 tons. The amount of compactive effort shall be as directed by the Engineer, but in no case shall be less than 4 complete passes of the compacting equipment being used.
- 26. Disturbed areas shall be top soiled, seeded with grass and mulched in a manner conforming to the recommendations of the "Guidelines for Soil Erosion and Sediment Control", published by The Connecticut Council on Soil and Water Conservation, May 2002.
- 27. After the areas to be topsoiled have been brought to grade, the subgrade shall be loosened by scarifying to a depth of at least 2" to ensure bonding of the topsoil and subsoil.
- 28. Topsoil shall be friable and loamy with high organic content. It shall be free of debris, rocks larger than 2" and roots. Topsoil shall have at least 1.5 percent by weight of fine textured stable organic material and no greater than 6 percent. Topsoil shall not have less than 20% fine textured material (passing the No, 200 sieve) and not more than 15% clay. pH range shall be 6.0-7.5 and soluble salts shall not exceed 500ppm.
- 29. Fill or topsoil shall not be placed nor compacted while in a frozen or muddy condition or while subgrade is
- 30. Excavation for pipes or concrete pavement repair may require either a braced excavation or open cut designed according to the requirements of OSHA, 29 CFR Part 1926. The lateral support systems and slopes should also be designed such that building footings, slabs on grade, adjacent pavement and existing ut ilities are protected and supported and not allowed to settle. The contractor shall be responsible for having a Professional Engineer, registered in the State of Connecticut design the excavation support method. The designs shall be submitted to the owner or his geotechnical engineer for review. The contractor shall submit plans showing the type, limits, design and sequence of construction for the lateral
- 31. During the excavation, it is anticipated that existing utilities and sewers may be exposed. The contractor shall provide protection and support of these facilities and repair any damage caused by the work in a manner satisfactory to the owner. The condition of the existing facilities shall be observed by the owner's representative who shall determine if the facilities shall be replaced. Replacement of the facilities shall be done in a manner satisfactory to the owner and in compliance with applicable Codes.

STORM AND SANITARY SEWER SYSTEMS:

- 32. All pipe shall be installed straight and at the vertical and horizontal alignment shown. Pipes shall have a uniform slope as specified.
- 33. Minimum cover on all pipes shall be two feet (2') unless otherwise noted.
- All storm pipe specified as Poly Vinyl Chloride Pipe (PVCP) shall be SDR 35 with rubber gasketed joints
- and meet the requirements of ASTM D3034 and D3212. 35. All High Density Polyethylene Pipe (HDPE) for the stormwater system shall be ADS N-12 or equivalent
- with O-Ring joints (Pro-series) suitable for water tight installations. 36. All sanitary sewer pipe shall be Poly Vinyl Chloride Pipe (PVCP) and shall be Schedule 40 with solvent weld
- 37. Dig test pits at utility and sewer crossings to check actual clearances with these facilities prior to construction. Dig test pits at the connection points to existing sanitary sewer pipes to confirm that the elevation of the proposed gravity sewer is appropriate. If conflicts are found the contractor shall notify

the engineer at which time the sewer in question shall be redesigned. If such redesign is not possible, the

- existing pipes or utilities shall be relocated to avoid conflict. 38. All area drains shall have a two foot (2') sump with bell traps or 90° PVC elbows.
- 39. All existing and proposed area drains, junction boxes and utility facilities shall be raised or lowered to be
- 40. Locate and abandon existing sanitary laterals at the property line with the end capped and mortared. Other existing utilities shall be abandoned in accordance with the requirements of the utility owner(s).
- 41. When connecting new pipes to existing structures such as manholes and catch basins, the structure shall be completely cleaned out. The hole made in the structure shall be made as small as possible. The structure shall be repaired to match its original type of construction. The joint between the structure and the pipe shall be made watertight by filling the joint with mortar.
- 42. Flow in existing sewer system must not be interrupted. Any temporary routing of this sewer flow must be done in conformance with all applicable rules and regulations.
- 43. Under no circumstances shall trench water be allowed to drain off through sanitary sewer lines.
- 44. All crushed stone shall be Gradation No. 4 as per CT DOT Form 818, Article M.01.02. Stone shall consist of sound, tough, durable particles free from soft, thin, elongated, laminated, friable, micaceous, or disintegrated pieces of mud, dirt or other deleterious material.
- 45. Sanitary Sewer Testing: The sanitary sewer line shall be Low Pressure Air Tested, at the expense of the contractor; Testing to be in accordance with recommended procedure in "Unibell's" "Recommended Practice for Low Pressure Air Testing of Installed Sewer Pipe" UNI B-6. The minimum starting pressure for the test is 3.5 P.S.I. (in excess of the groundwater pressure at the top of the pipe) and there shall be no more than 0.5 P.S.I. drop in five (5) minutes. Manholes to be visually inspected. Lateral plugs shall be airtight to allow proper testing. Inspecting Engineer and the Engineering Bureau shall be informed of testing schedule three days in advance so they can witness the testing.
- 46. At the end of construction, after the site has be fully stabilized, all new and previously existing storm sewer facilities including, but not limited to, catch basins, area drains, manholes, junction boxes, flow control structures, pipes, oil grit separators, permeable pavers and porous pavement shall be fully cleaned with equipment designed for that purpose to the satisfaction of the inspecting engineer.

- 47. Utilities shown on these plans are "not guaranteed" to be complete or correct. Prior to any site activities, the contractor shall be responsible for verification of clearances of proposed utilities from existing utilities. This verification shall include physical observation by means of test pits of the locations of affected utilities. The contractor shall notify the site engineer immediately of any conflict.
- 48. Easements may be required in favor of the various utility companies.
- 49. Electric, telephone, cable, and water services shall be installed in conformance to the requirements of the
- 50. It is the contractor's responsibility to install utilities as shown on this sheet. The contractor shall work with the utility companies and site engineer to insure the installation is in conformance to the requirements of the governing utility company. All conduits shall be concrete encased as may be required by the governing utility company. Proposed electric, telephone, cable and water services are shown for schematic purposes only and are subject to change pending utility company review. These utilities shall be designed by others and installed in conformance to the requirements of the governing utility companies.
- 51. All proposed utility facilities shall be raised or lowered to be flush with finished grade.
- 52. Where necessary, existing utilities shall be reinstalled to meet all minimum coverage requirements.
- 53. Utility connections at building face shall be coordinated with the building contractors.
- 54. The contractor must supply and install drag lines with all conduits.
- 55. Assume one 2" PVCP conduit for all site lighting. Service location to be determined.
- 56. In general, each utility shall have a minimum clearance of three feet to any other underground utility.
- 57. Any and all utilities abandoned shall be capped or removed in accordance with utility companies'

- 58. Existing fire valves shall be cut flush to grade in accordance with Aquarion Water Company requirements
- 59. The electric transformer and generator shall be located to meet all applicable Zoning setbacks. Detectable Tape shall be used to mark piping listed below. The identification tape shall be buried at least
- 6-inches to 10-inches below final grade but no closer than 12-inches to the buried utility piping or service Caution Electric Line Buried Below Telephone & Control Caution Telephone Line Buried Below Yellow Caution Gas Line Buried Below Natural Gas Blue Water Systems Caution Water Line Buried Below Fire Protection Systems Caution Fire Line Buried Below Sprinkle Caution Sprinkler Line Buried Below Sewer

Caution Sewer Line Buried Below

Conc. N/A

61. Underground-Type Plastic Line Marker: Manufacturer's standard permanent, bright-colored detectable tape, continuous-printed plastic tape, intended for direct-burial service; not less than 6" wide X 4 mils

Orange

PAVEMENT AND PAVEMENT MARKINGS:

shall be repaired at no additional cost to the owner.

IS & S Communication Conduit

- Areas of asphalt payement that are disturbed by the construction of this project shall be replaced in accordance with the asphalt pavement repair detail. The finished grade of asphalt paving shall blend to existing grade and the edge of the concrete pavement smoothly with no slopes exceeding 4%.
- Existing features such as but not limited to walks, curbs, and pavement damaged by construction activities
- Saw cut perimeter of area to be excavated. Saw cut shall be straight and vertical.
- Contractor shall engage a testing lab who shall verify the base course material by means of a sieve analysis and perform compaction testing of the base and each course of pavement. Site Engineer shall review with the contractor the required testing at the preconstruction meeting. Site Engineer shall approve base course prior to placement of each layer of pavement.
- The Contractor shall engage a qualified independent testing agency to perform field inspections and tests and to prepare test reports. Testing agency will conduct and interpret tests and state in each report
- whether tested work complies with or deviates from specified requirements. Additional testing, at Contractor's expense, will be performed to determine compliance of corrected work with specified requirements. Remove and replace or install additional hot-mix asphalt where test results or
- Contractor is responsible to place the hot-mix asphalt mix as required in the drawings, details and the

measurements indicate that it does not comply with specified requirements as directed by the Site

Compaction shall be constructed as specified in the CT DOT FORM 818 (latest edition), Section 4.06 specification, the drawings and the details. Testing lab shall verify compaction of each course of pavemen as directed by the Site Engineer.

applicable Section of the CT DOT FORM 818 (latest edition).

test so that he may be present during the test.

(Modified Proctor Method).

After the asphalt pavement has cured sufficiently to support the weight of a water truck without marking the newly installed pavement, it shall be water tested for low spots, areas of little or no drainage, etc. A water truck shall spray a sufficient amount of water on all pavement sections to observe the drainage of water. There shall be positive drainage on all areas of the pavement. Any visible low spots where significant water (greater than or equal to 3/16" in depth) is left standing, shall be clearly marked for the Contractor to repair prior to final acceptance. These areas must be sawcut and removed down to the base course prior to replacement with asphalt mixture as per the original approved design. The base

course and edges of sawcut asphalt must be treated with tack oil prior to new section of asphalt being

installed. The Owner's Representative or inspecting A/E shall be notified 48 hours in advance of water

- The inspecting engineer and contractor will review the testing requirements at the preconstruction meeting. At this meeting, samples to be tested and compaction testing protocol will be discussed. Testing and approval of the subgrade, base course and asphalt layers prior to the installation of the next layer to determine if the work complies or deviates from the specified requirements. Prior to installation of the base course, contractor shall contact inspecting engineer to determine the suitability of the subgrade
- material, base course and asphalt. Additional excavation or base course may be required.
- 72. Finished paving shall be free of ``bird baths" and be smooth at the slopes specified on the plans.
- 73. Finished grade shall be within 1/2 inch of that noted on the drawings. 74. The pavement shall be protected from vehicular traffic of any kind with the use of barricades, etc. for a minimum period of 24 hours after final rolling. Maintain and protect asphalt surface from scrapes, sears, spills, hydraulic leaks, and any other construction damage for the remainder of construction until Owner's
- re-striping as necessary to obtain Owner's Representative's final approval/acceptance. Thicknesses of all layers shown are after compaction. Compact all layers to 95% per ASTM D 1557

Representative acceptance. Contractor is responsible for clearing, repairing, seal coating, patching, and

- 76. All pavement striping and replacement shall conform to the Town of Wilton standards and the latest
- DPW CONDITIONS:
- 78. Prior to construction brick samples along sidewalks shall be provided to match existing bricks. Final design plans shall be submitted to DPW for review prior to the issuance of a Building Permit. The
- and finalized as part of the Building Permit application. Prior to the issuance of a Certificate of Occupancy, a certified as-built drawing and certified letter signed

sidewalk details, re-use of existing light pole foundations, and pavement restoration limits shall be reviewed

77. Easements shall be created portions of roadway and sidewalks providing pedestrians access that fall on the

- by a Professional Engineer indicating that all work was completed in accordance with the design plans shall be submitted to the Town of Wilton.
- The proposed stormwater system is connecting directly to the roadway drainage system. Any damage to the proposed development caused by stomwater back up due to a clogged catch basin or insufficient pipe capacity shall not be the responsibility of the Town.
- Prior to any work in the Town Right of Way, a Road Opening Permit shall be obtained. The project is subject to obtaining approvals from Wilton's WPCA Commission to connect additional
- units into the sanitary sewer system
- 84. Project is subject to Norwalk WPCA's review and comment. The project will be subject to Sewer Capital Assessment as required by the WPCA.
- 86. No footing drains or sumps shall connect to the sanitary system.
- 87. Property owner shall be responsible for maintenance of the lateral and unclogging any potential clogs in the lateral and/or sewer main connection points.
- 88. All proposed sewer lines shall be air tests prior to sign off of the Certificate of Occupancy.
- 89. The project is subject to the final technical review by WPCA.

8 05/31/2023 REVISED UNIT COUNT 7 05/26/2023 REVISED LOADING SPACE 6 05/15/2023 REVISED PER PZC COMMENTS 05/08/2023 REVISED PER DPW COMMENTS 4 02/28/2023 REVISED PER BUILDING DESIGN 3 01/02/2023 REVISED PER DPW COMMENTS 2 | 10/20/2022 | REVISED PER FIRE MARSHALL'S COMMENTS 09/30/2022 ORIGINAL ISSUE DATE

SITE DEVELOPMENT PLAN 12 GODFREY PLACE

PREPARED FOR **GREENWICH REALTY DEVELOPMENT, LLC**



LAND SURVEYING


www.rednissmead.com

No. Date Revision

PATRICK B. SHURR CT. P.E. 33981 nature and embossed seal of the designated licensed prof

CHECKED BY: CJF

CIVIL ENGINEERING PLANNING & ZONING CONSULT PERMITTING 22 First Street | Stamford, CT 06905 Tel: 203.327.0500 | Fax: 203.357.1118

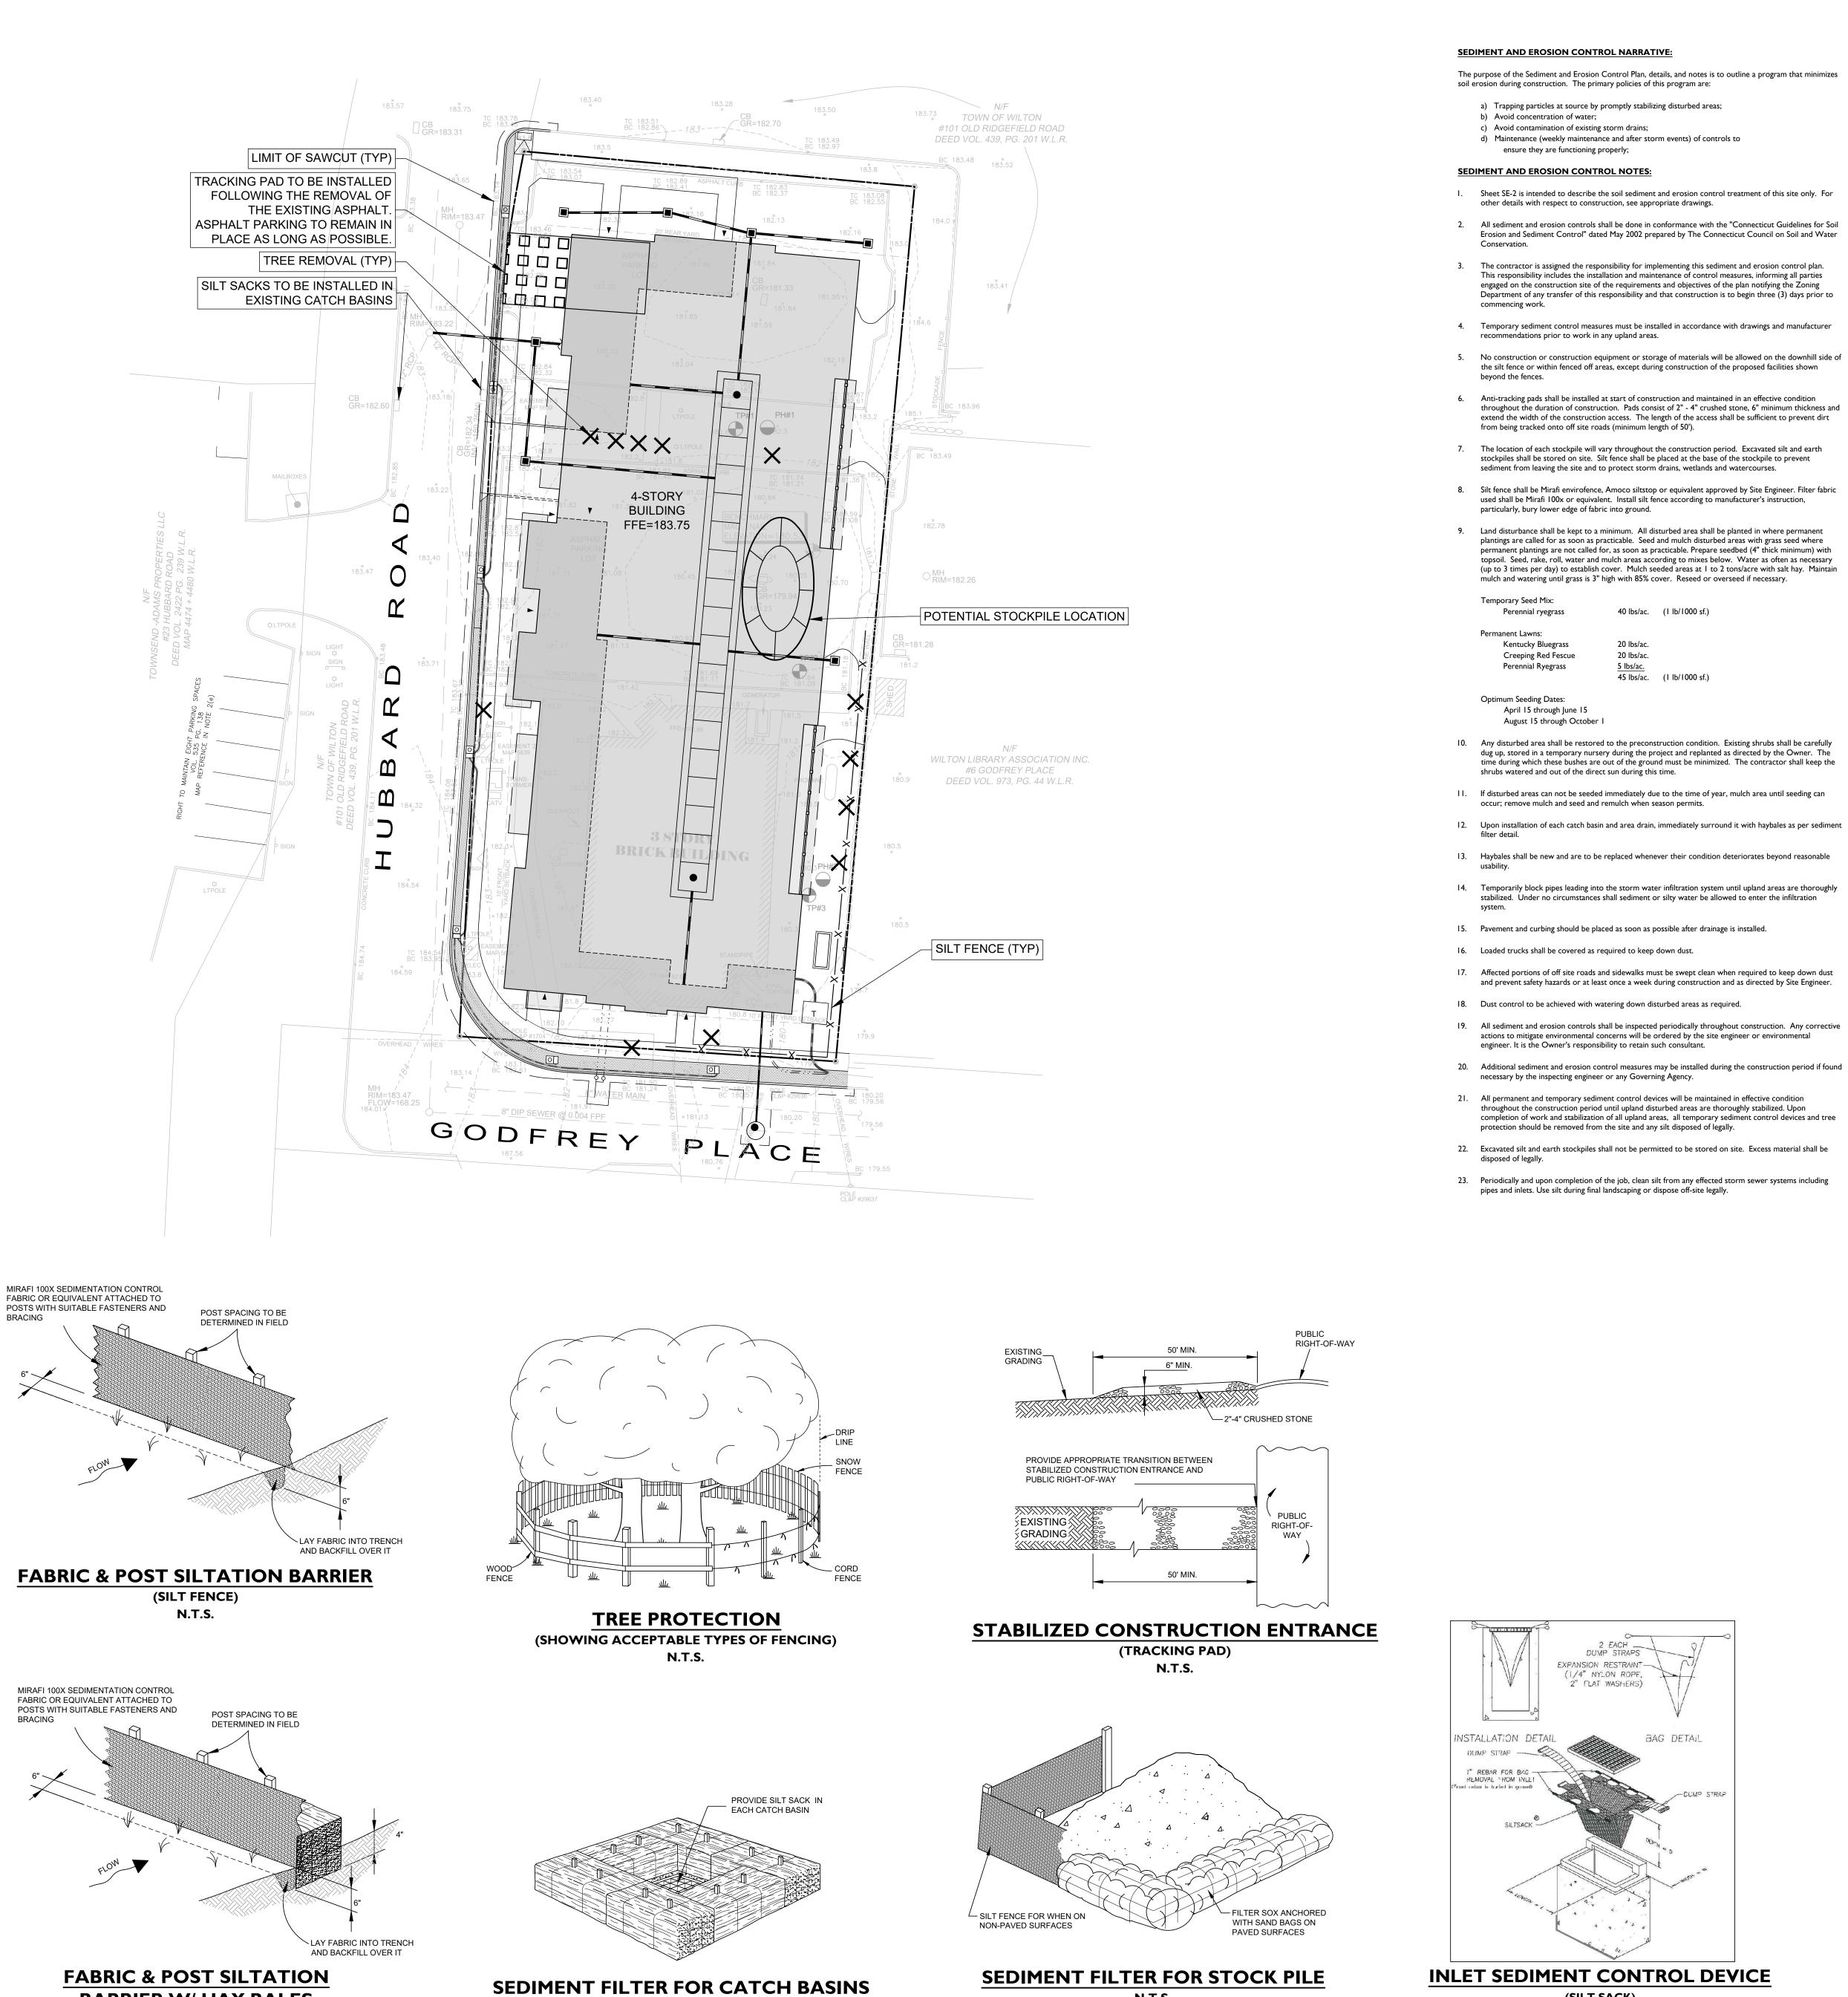


N.T.S.

BARRIER W/ HAY BALES

(SILT FENCE)

N.T.S.

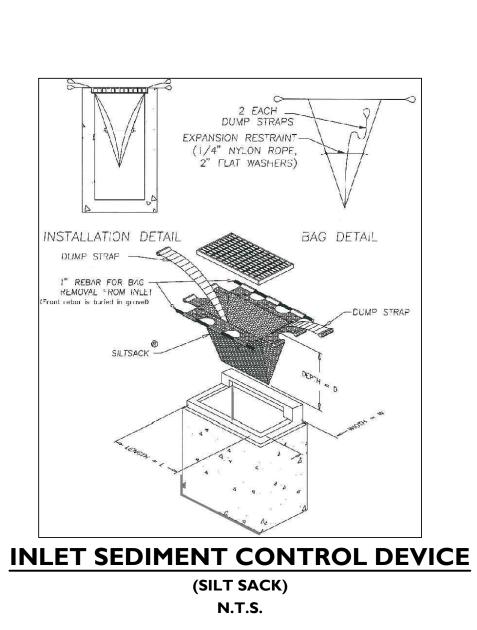

40 lbs/ac. (1 lb/1000 sf.)

45 lbs/ac. (1 lb/1000 sf.)

20 lbs/ac.

20 lbs/ac.

August 15 through October 1

CONSTRUCTION PHASING:

The following description of construction phasing is intended to demonstrate a feasible sequence of construction. The actual sequence may vary due to field conditions if approved by the inspecting engineer.

PHASE I: PREPARATION

A. AT LEAST ONE WEEK PRIOR TO THE START OF CONSTRUCTION, THE INSPECTING ENGINEER SHALL MEET WITH THE CONTRACTOR AND OWNER TO REVIEW THE SEDIMENT AND EROSION CONTROL (S&E PLAN), DISCUSS ANY MODIFICATIONS TO CONSTRUCTION SEQUENCE OR S&E PLAN AND TO REVIEW CONTRACTORS LOGISTICS PLAN.

B. ESTABLISH STAGING AREA WITH TRAILERS AND TEMPORARY UTILITIES.

C. INSTALL TRACKING PADS FOR CONSTRUCTION ACCESS.

D. INSTALL SILT FENCE, CONSTRUCTION FENCE AND PERIMETER FENCE AS SHOWN ON THE

E. CUT TREES TO BE REMOVED AND GRUB AREAS TO BE CLEARED.

F. REMOVE/DEMOLISH EXISTING BUILDING, REMOVE EXISTING PAVEMENT ONLY AS NECESSARY TO PROCEED WITH EACH PHASE OF CONSTRUCTION.

PHASE II: CONSTRUCTION

PLANTINGS.

A. ROUGH GRADE SITE. GENERAL EARTHWORK. EXCAVATE FOR BUILDING FOUNDATION. INSTALL CONSTRUCTION DEWATERING AND TEMPORARY FILTERING SYSTEM AS NECESSARY. COORDINATE DEWATERING CONSTRUCTION WITH SITE GEOTECHNICAL AND STRUCTURAL ENGINEERS. (NOTE: MANAGEMENT OF EXCAVATED MATERIALS DURING THIS PROCESS SHALL BE ACHIEVED BY TEMPORARILY STOCKPILING ONSITE TO THE EXTENT CONSTRUCTION STAGING WILL ALLOW AND BY HAULING MATERIAL OFFSITE AS EXCAVATED).

CONSTRUCT FOUNDATION AND BACKFILL AS SOON AS POSSIBLE.

RECEIVE STORM WATER PRIOR TO THE INSTALLATION OF PAVING.

INSTALL STORM WATER SYSTEM. THE DRAINAGE UTILITIES WILL BE INSTALLED AND READY TO

D. INSTALL SEDIMENT AND EROSION CONTROLS ASSOCIATED WITH DRAINAGE STRUCTURES.

E. INSTALL SANITARY, WATER, CABLE, ELECTRIC, AND TELEPHONE UTILITIES.

G. SEED & MULCH DISTURBED AREAS AND INSTALL LANDSCAPING AS SOON AS POSSIBLE.

H. MAINTAIN ALL SEDIMENT AND EROSION CONTROLS IN AN EFFECTIVE CONDITION DURING THE CONSTRUCTION PERIOD.

PHASE III: CLEAN UP AFTER ALL AREAS ARE STABILIZED

A. CLEAN EFFECTED PORTION OF ON & OFF SITE ROADS AND DRIVEWAYS.


B. REMOVE ACCUMULATED SILT AND DEBRIS FROM CATCH BASIN SUMPS & PIPES OF EFFECTED ON & OFF SITE STORM DRAINS.

C. REMOVE ACCUMULATED SEDIMENT FROM EFFECTED AREAS AND DISPOSE OF LEGALLY.

D. REMOVE TEMPORARY SEDIMENT AND EROSION CONTROL AND TREE PROTECTION.

E. MAKE ANY NECESSARY REPAIRS TO PERMANENT SEDIMENT AND EROSION CONTROLS SUCH AS


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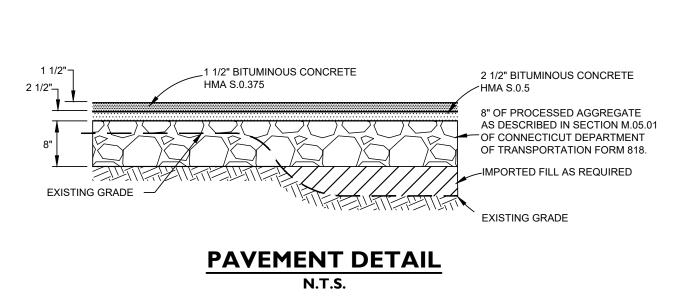


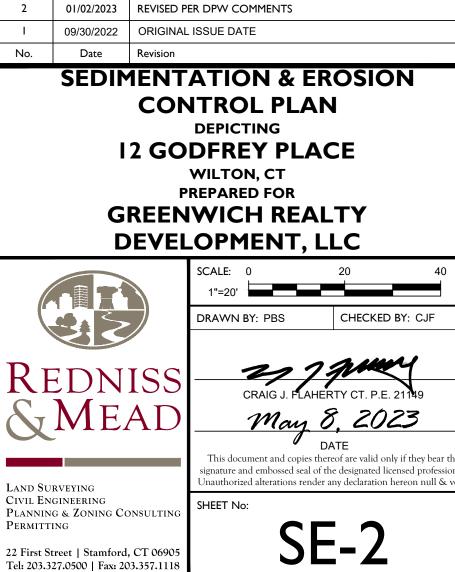
4 05/08/2023 REVISED PER DPW COMMENTS

3 02/28/2023 REVISED PER BUILDING DESIGN

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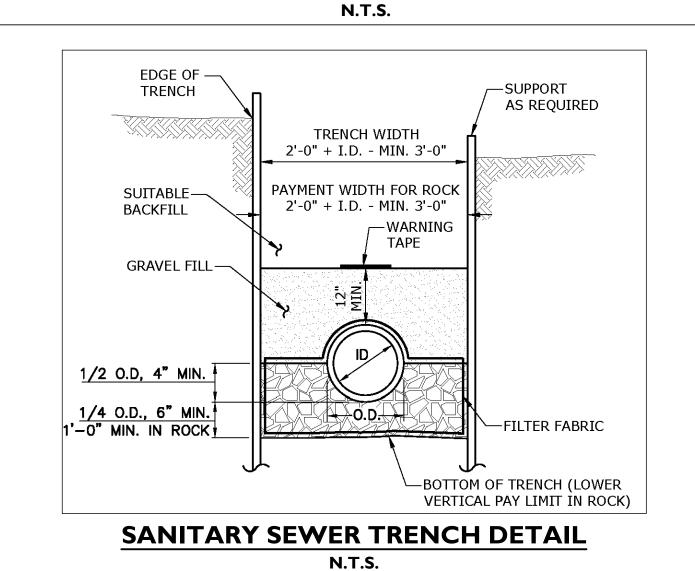


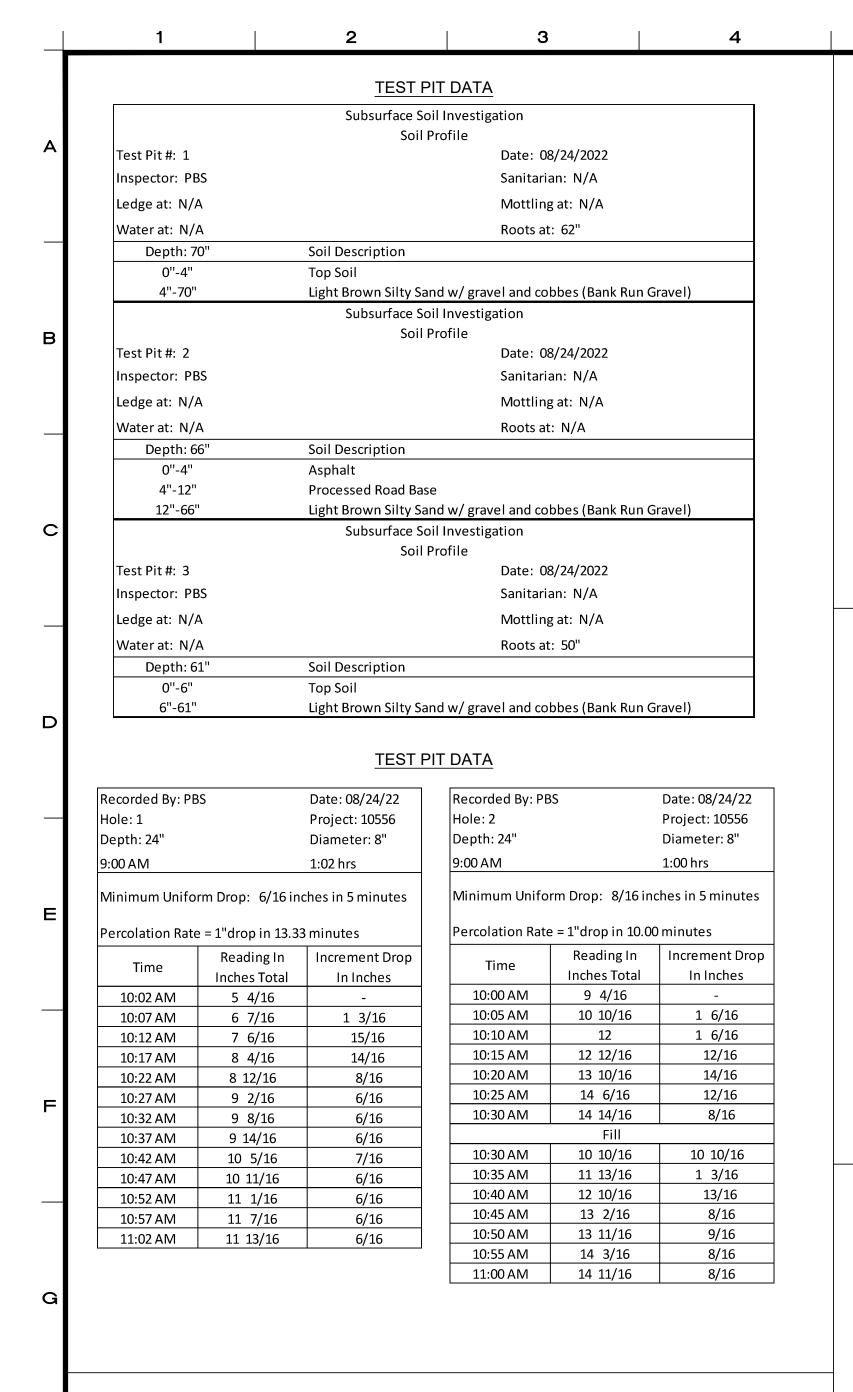


LIGHTING CONDUIT TRENCH DETAIL (SAND BEDDING)

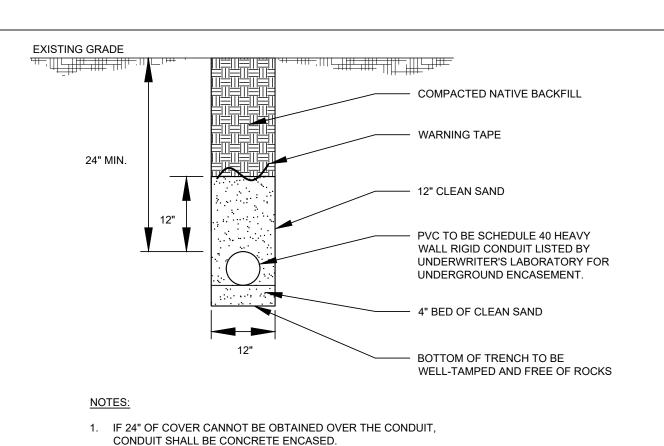2. ALL BACKFILL MATERIAL SHALL BE COMPACTED TO 95% OF THE


MAXIMUM DRY DENSITY AS DETERMINED BY ASTM D1557.



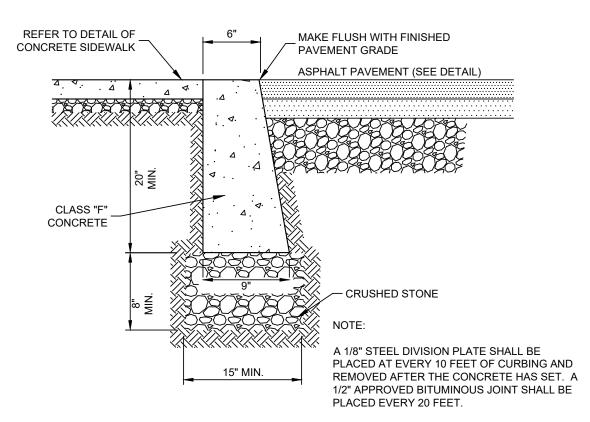

8

FLUSH CONCRETE CURB N.T.S.

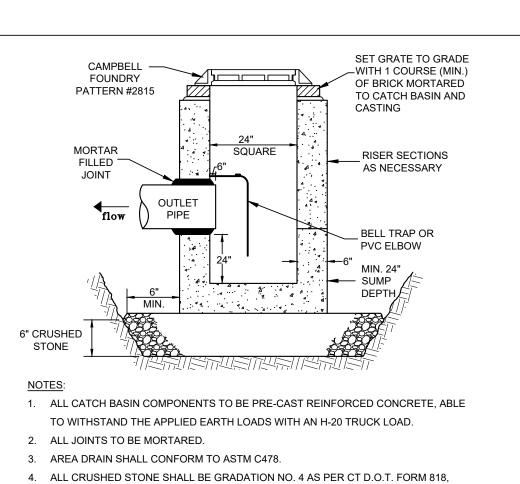

ARTICLE M.01.01. STONE SHALL CONSIST OF SOUND, TOUGH, DURABLE PARTICLES

FREE FROM SOFT, THIN, ELONGATED, LAMINATED, FRIABLE, MICACEOUS OR

24" AREA DRAIN

N.T.S.

DISINTEGRATED PIECES, MUD. DIRT OR OTHER DELETERIOUS MATERIAL.

PITCH OF WALK - 1/4" PER FT SIDEWALK SIDE CRUSHED STONE ---3/4" CRUSHED □ WELDED WIRE FABRIC NOTE: A 1/8" STEEL DIVISION PLATE SHALL BE PLACED AT EVERY

10 FEET OF CURBING & REMOVED AFTER CONCRETE HAS


SET, A 1/2" APPROVED BITUMINOUS JOINT SHALL BE PLACED AT A MAX. OF EVERY 20 FEET COINCIDING WITH EXPANSION JOINT IN SIDEWALK CONTRACTOR TO CONSTRUCT 2" BATTER ON CONCRETE CURBING (STREET SIDE ONLY) STANDARD CURB & SIDEWALK SCALE: 1/2" = 1'-0"VARIES **GRASS PLOT** PITCH = 1/2" PER F GRASS PLOT 1. ALL REINFORCING SHALL BE SUPPORTED ON CHAIRS OR OTHER POSITIVE TYPE SUPPORTS APPROXIMATELY ONE PER 25 SQ.FT.

2. CONCRETE SHALL BE CLASS "C" CEMENT TYPE II, 3000 PSI

3. AIR ENTRAINMENT SHALL BE BETWEEN 6 — 7%.

1/2" PREMOLDED EXPANSION JOINT -

CONTINUOUS AND FULL DEPTH

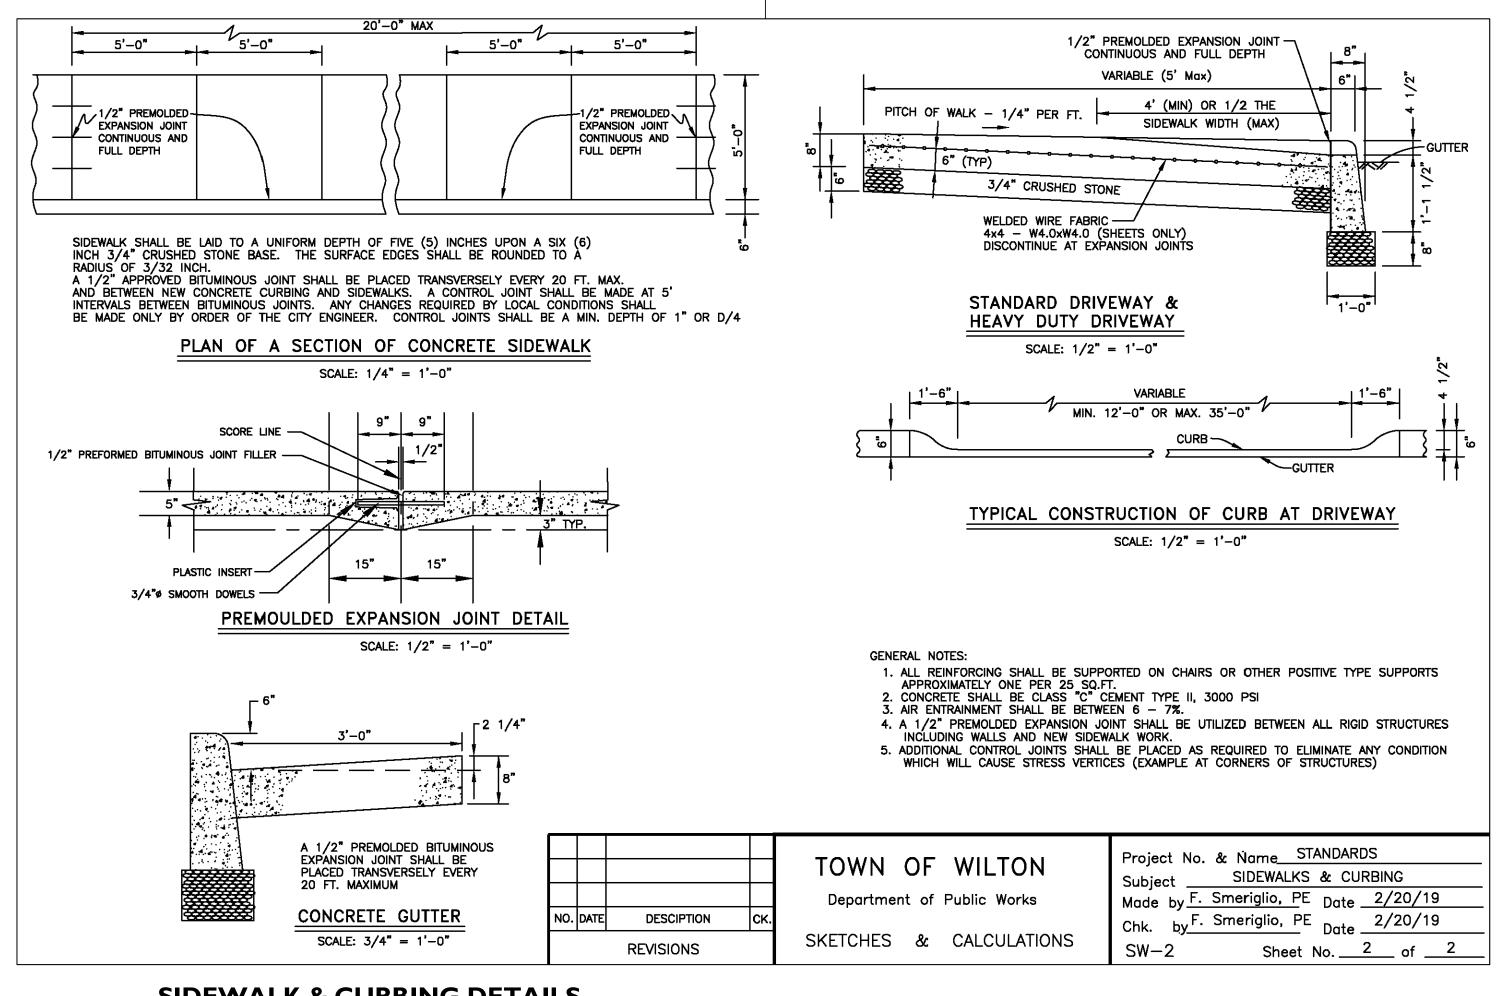

SIDEWALK & CURBING DETAILS
N.T.S.

SET GRATE TO GRADE WITH 1 CAMPBELL FOUNDRY PATTERN #2802 MORTARED TO CATCH BASIN ■ PRECAST CONCRETE BOX — REFER TO INVERT DETAIL KNOCKOUTS AS MORTAR FILLED NECESSARY (TYP) CRUSHED STONE _ . ALL COMPONENTS TO BE PRE-CAST REINFORCED CONCRETE, ABLE TO WITHSTAND THE APPLIED EARTH LOADS OF AN H-20 TRUCK LOAD. 2. ALL JOINTS TO BE MORTARED. 3. JUNCTION BOXES SHALL CONFORM TO ASTM C478. 4. ALL CRUSHED STONE SHALL BE GRADATION NO. 4 AS PER CT D.O.T. FORM 818, ARTICLE M.01.01. STONE SHALL CONSIST OF SOUND, TOUGH, DURABLE PARTICLES FREE FROM SOFT, THIN, ELONGATED, LAMINATED, FRIABLE, MICACEOUS OR DISINTEGRATED PIECES, MUD, DIRT OR OTHER DELETERIOUS MATERIAL. **JUNCTION BOX** N.T.S.


WATER STOP: 10' UPSTREAM OF STRUCTURES AND WHERE SHOWN, FOUNDATION MATERIAL, BEDDING, HAUNCHING, INITIAL BACKFILL, AND THE BOTTOM FOOT OF GENERAL BACKFILL TO BE REPLACED WITH SM, SC, OR ML SOIL AS PER UNIFIED SOIL CLASSIFICATION SYSTEM" WITH MAXIMUM PARTICLE SIZE OF 1-1/2", FOR 3 LINEAR FEET OF TRENCH. WATER STOP TO BE KEYED INTO TRENCH BOTTOM AND WALLS A MINIMUM OF ONE FOOT. NO STONES LARGER THAN 6" SHALL BE WITHIN 12" OF THE PIPE.

ALL FOUNDATION, INITIAL BACKFILL & BACKFILL MATERIAL TO BE APPROVED BY THE INSPECTING ENGINEER.


ANY DEVIATION FROM THESE METHODS & MATERIALS MUST BE APPROVED IN WRITING BY THE INSPECTING ENGINEER.


ALL MATERIAL TO BE COMPACTED TO 95% OF THE MAX. DRY DENSITY AS DETERMINED BY ASTM D1557, EXCEPT COMPACTED


BACKFILL" NOT UNDER PAVEMENT WHICH SHALL BE COMPACTED TO A DENSITY AT LEAST EQUAL TO THAT OF THE ADJACENT

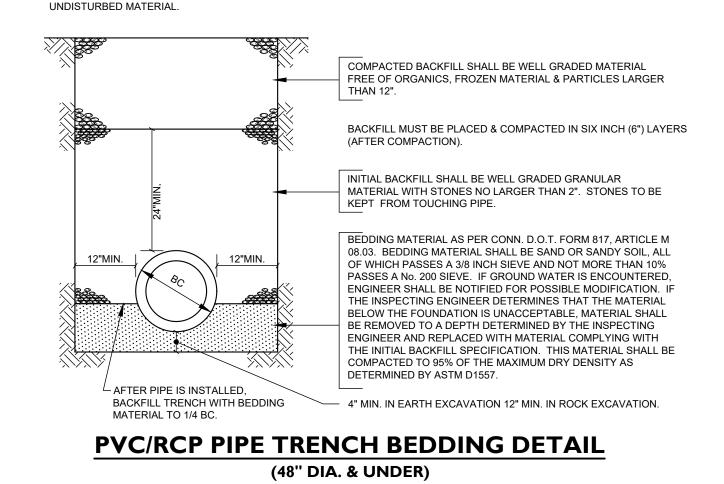

N.T.S.

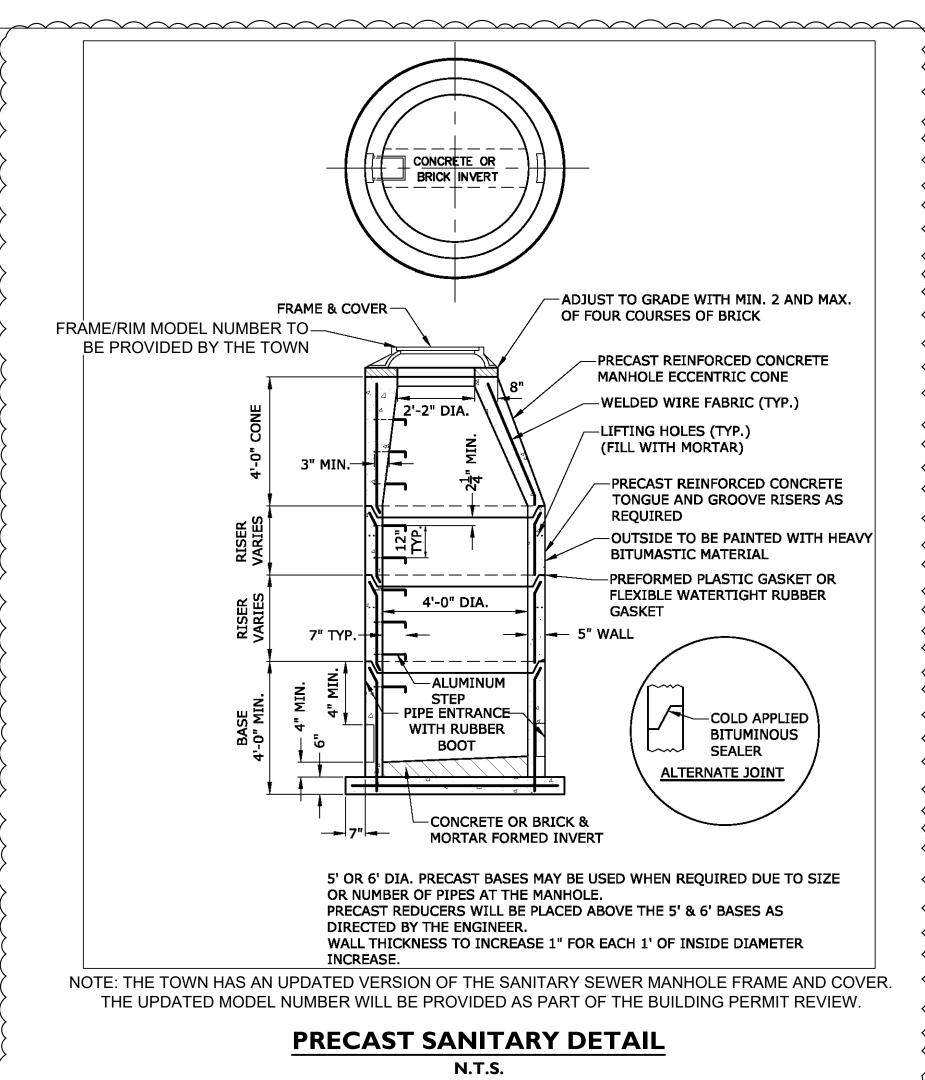


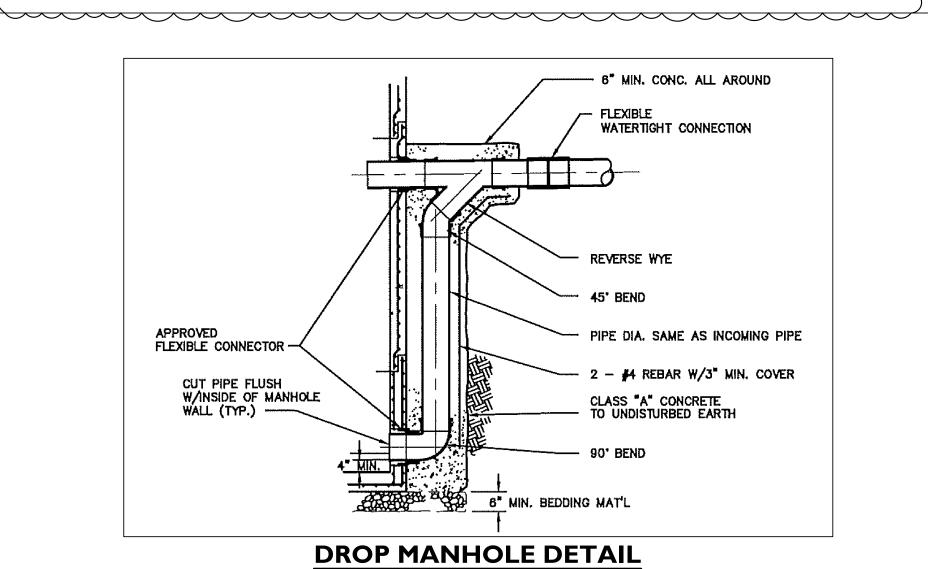

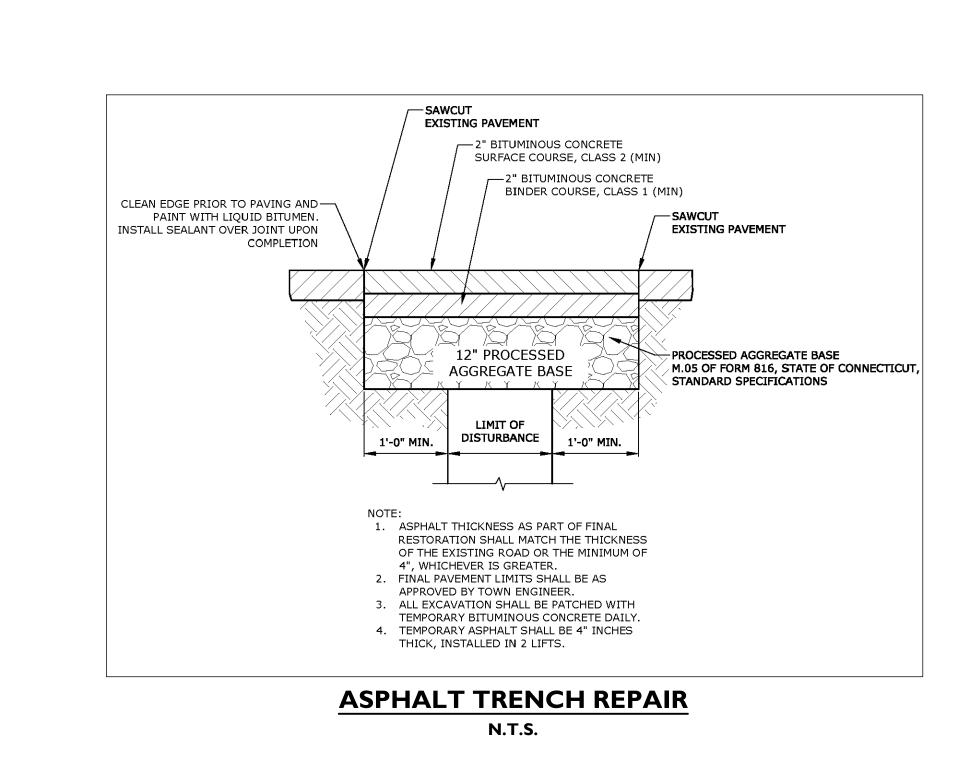

4 05/08/2023 REVISED PER DPW COMMENTS
3 02/28/2023 REVISED PER BUILDING DESIGN
2 01/02/2023 REVISED PER DPW COMMENTS
1 09/30/2022 ORIGINAL ISSUE DATE
No. Date Revision

DETAILS & SOIL DATA
DEPICTING
12 GODFREY PLACE
WILTON, CT
PREPARED FOR
GREENWICH REALTY
DEVELOPMENT, LLC

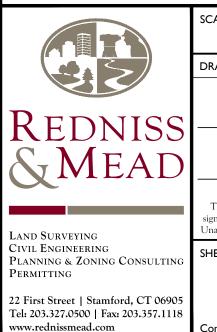

CRAIG J. FLAHERTY CT. P.E. 21149

May 8, 2023

DATE

This document and copies thereof are valid only if they bear the signature and embossed seal of the designated licensed professional. Unauthorized alterations render any declaration hereon null & void.

SHEET No:

SE-3

Comm. No.: 10556

