PROJECT TITLE:

55 GRUMMAN HILL RD WILTON, CT

GRAHAM Residence

cusatoARCHITECTURE architecture - planning - interiors

41 otter trail westport ct 06880 www.cusatoARCHITECTURE.COM 203.395.4663

ZBA SET 062018

REVISIONS:

SCHEDULE OF DRAWINGS

- A1 1 FLOOR PLAN
- A2 2 FLOOR & ATTIC DEMO PLAN
- A3 2 FLOOR & ATTIC NEW CONSTRUCTION PLAN
- A4 NORTH ELEVATION DEMO & NEW CONSTRUCTION
- A5 SOUTH ELEVATION DEMO & NEW CONSTRUCTION
- A6 EAST ELEVATION DEMO & NEW CONSTRUCTION
- A7 WEST ELEVATION DEMO & NEW CONSTRUCTION
- A8 BUILDING SECTION

GENERAL NOTES:

1) The contractor shall check and verify all dimensions and conditions prior to starting work and notify the architect of any discrepancies.

2) Contractor(s) shall obtain any and all permits as required by the town.

3) All work shall be as per building construction code of the State of CT and per zoning regulation for the town.

4) Contractor shall field measure and verify all existing conditions. Discrepancies shall be reported to the architect or engineer and resolved prior to proceeding with

5) The contractor shall be responsible for visiting the site and familiarizing themselves with existing conditions.

6) The contractor shall be solely responsible for all safe working conditions and shall observe all safety requirements established by jurisdictional agencies and the owner. Where conflicts exist, the more stringent will apply. Care shall be taken to avoid endangering personnel or the structure.

7) All drawings to be used in conjunction with the specifications.

8) All dimensions shall be verified by the contractor. The general contractor shall coordinate and be responsible for the approved size and location of all openings through roofs, floors and walls.

9) All sections and details are to be considered typical and apply for the same and similar conditions unless otherwise specifically noted.

20) Contractor to be responsible for contacting Call Before You Dig to locate and familiarize themselves all existing underground utilities

10) Contractor shall furnish and be solely responsible for all temporary bracing required to maintain stability of the structure during construction.

11) The general contractor shall coordinate the work of all trade sand sub contractors unless otherwise noted.

12) All contractors shall cooperate in coordinating construction. 13) All cutting and patching shall be done by the General Contractor and shall be the responsibility of the GC to see that the final patch is not visible after finishes. 14) The contractor shall protect, with appropriate fencing, and not damage trees, plantings or shrubs where work or operation of work is required at exterior of the

15) The storage of materials and equipment on site shall be located where directed by owner and architect.

16) All glass within 18" of floor shall be tempered safety glass.

17) All operable windows to be adequately flashed caulked and weather-stripped.

18) The contractor, by submitting his bid, represents that they have visited the site and agrees with plans and details as representing the full extent of construction. If contractor has found that plans and details vary significantly from what is physically in the field, they shall notify the architect or owner before submitting bid.

19) Contractor to carry appropriate insurance, workmen's comp and liability in the sums prescribed by authorities having jurisdiction over the project.

DEMOLITION NOTES:

-Obtain necessary demolition permits.

-Check with the Fire Department and Utility Companies.

-Inspect for Hazardous Materials.

-Demolish building components completely and remove from the site.

-Use methods required to complete Work within limitations of all governing regulations. -Remove debris and materials so as not to impose excessive loads on supporting walls, floors, or framing.

-Demolish concrete and masonry in sizes that will be suitable for acceptance at recycling or disposal facilities, unless otherwise shown to remain.

-Remove all disconnected, abandoned utilities on site.

-Take care to protect utilities, fences, landscaping, etc. to remain on site

-Completely remove below-grade construction, including foundation walls and footings.

-Below-Grade Areas: Completely fill below-grade areas and voids resulting from building demolition operations

to average grade level with satisfactory soil materials.

-Damages: Promptly repair damages to adjacent facilities caused by demolition operations.

-Do not burn demolished materials.

-Disposal: Transport demolished materials off [Owner's] property and legally reuse, salvage, recycle,

-Consult owner for coordination of valuable material removal before demo

The following codes are to be followed as amended by 2016 Connecticut State Building Code

- 2012 International Code Council (ICC) International Building Code

- 2012 International Code Council (ICC) International Residential Code

- 2012 International Code Council (ICC) International Existing Building Code

- 2012 International Code Council (ICC) International Mechanical Code - 2012 International Code Council (ICC) International Plumbing Code

- 2012 International Code Council (ICC) International Energy COnservation Code

- 2014 National Fire Protection Association (NFPA) 70 - National Electrical Code

- 2009 International Code Council (ICC) ANSI A117.1 - Accessible and Usable Buildings and Facilities

.32 Fenestration U-Factor:

.55 Skylight U-Factor:


Ceiling R-Value:


Wood Frame Wall R-Value: R20 cavity OR R13 cavity + R5 continuous

Mass Wall R-Value: R13 OR R17 if more than half of the insulation is on the interior of the mass wall

R30 OR fill the framing cavity with min R19 Floor R-Value: Basement Wall R-Value: R15 continuous on interior or exterior OR R19 interior cavity OR R13 interior cavity + R5 continuous


Slab R-Value / Depth: R15 continuous on interior or exterior OR R19 interior cavity OR R13 interior cavity + R5 continuous Crawl Space Wall R-Value:

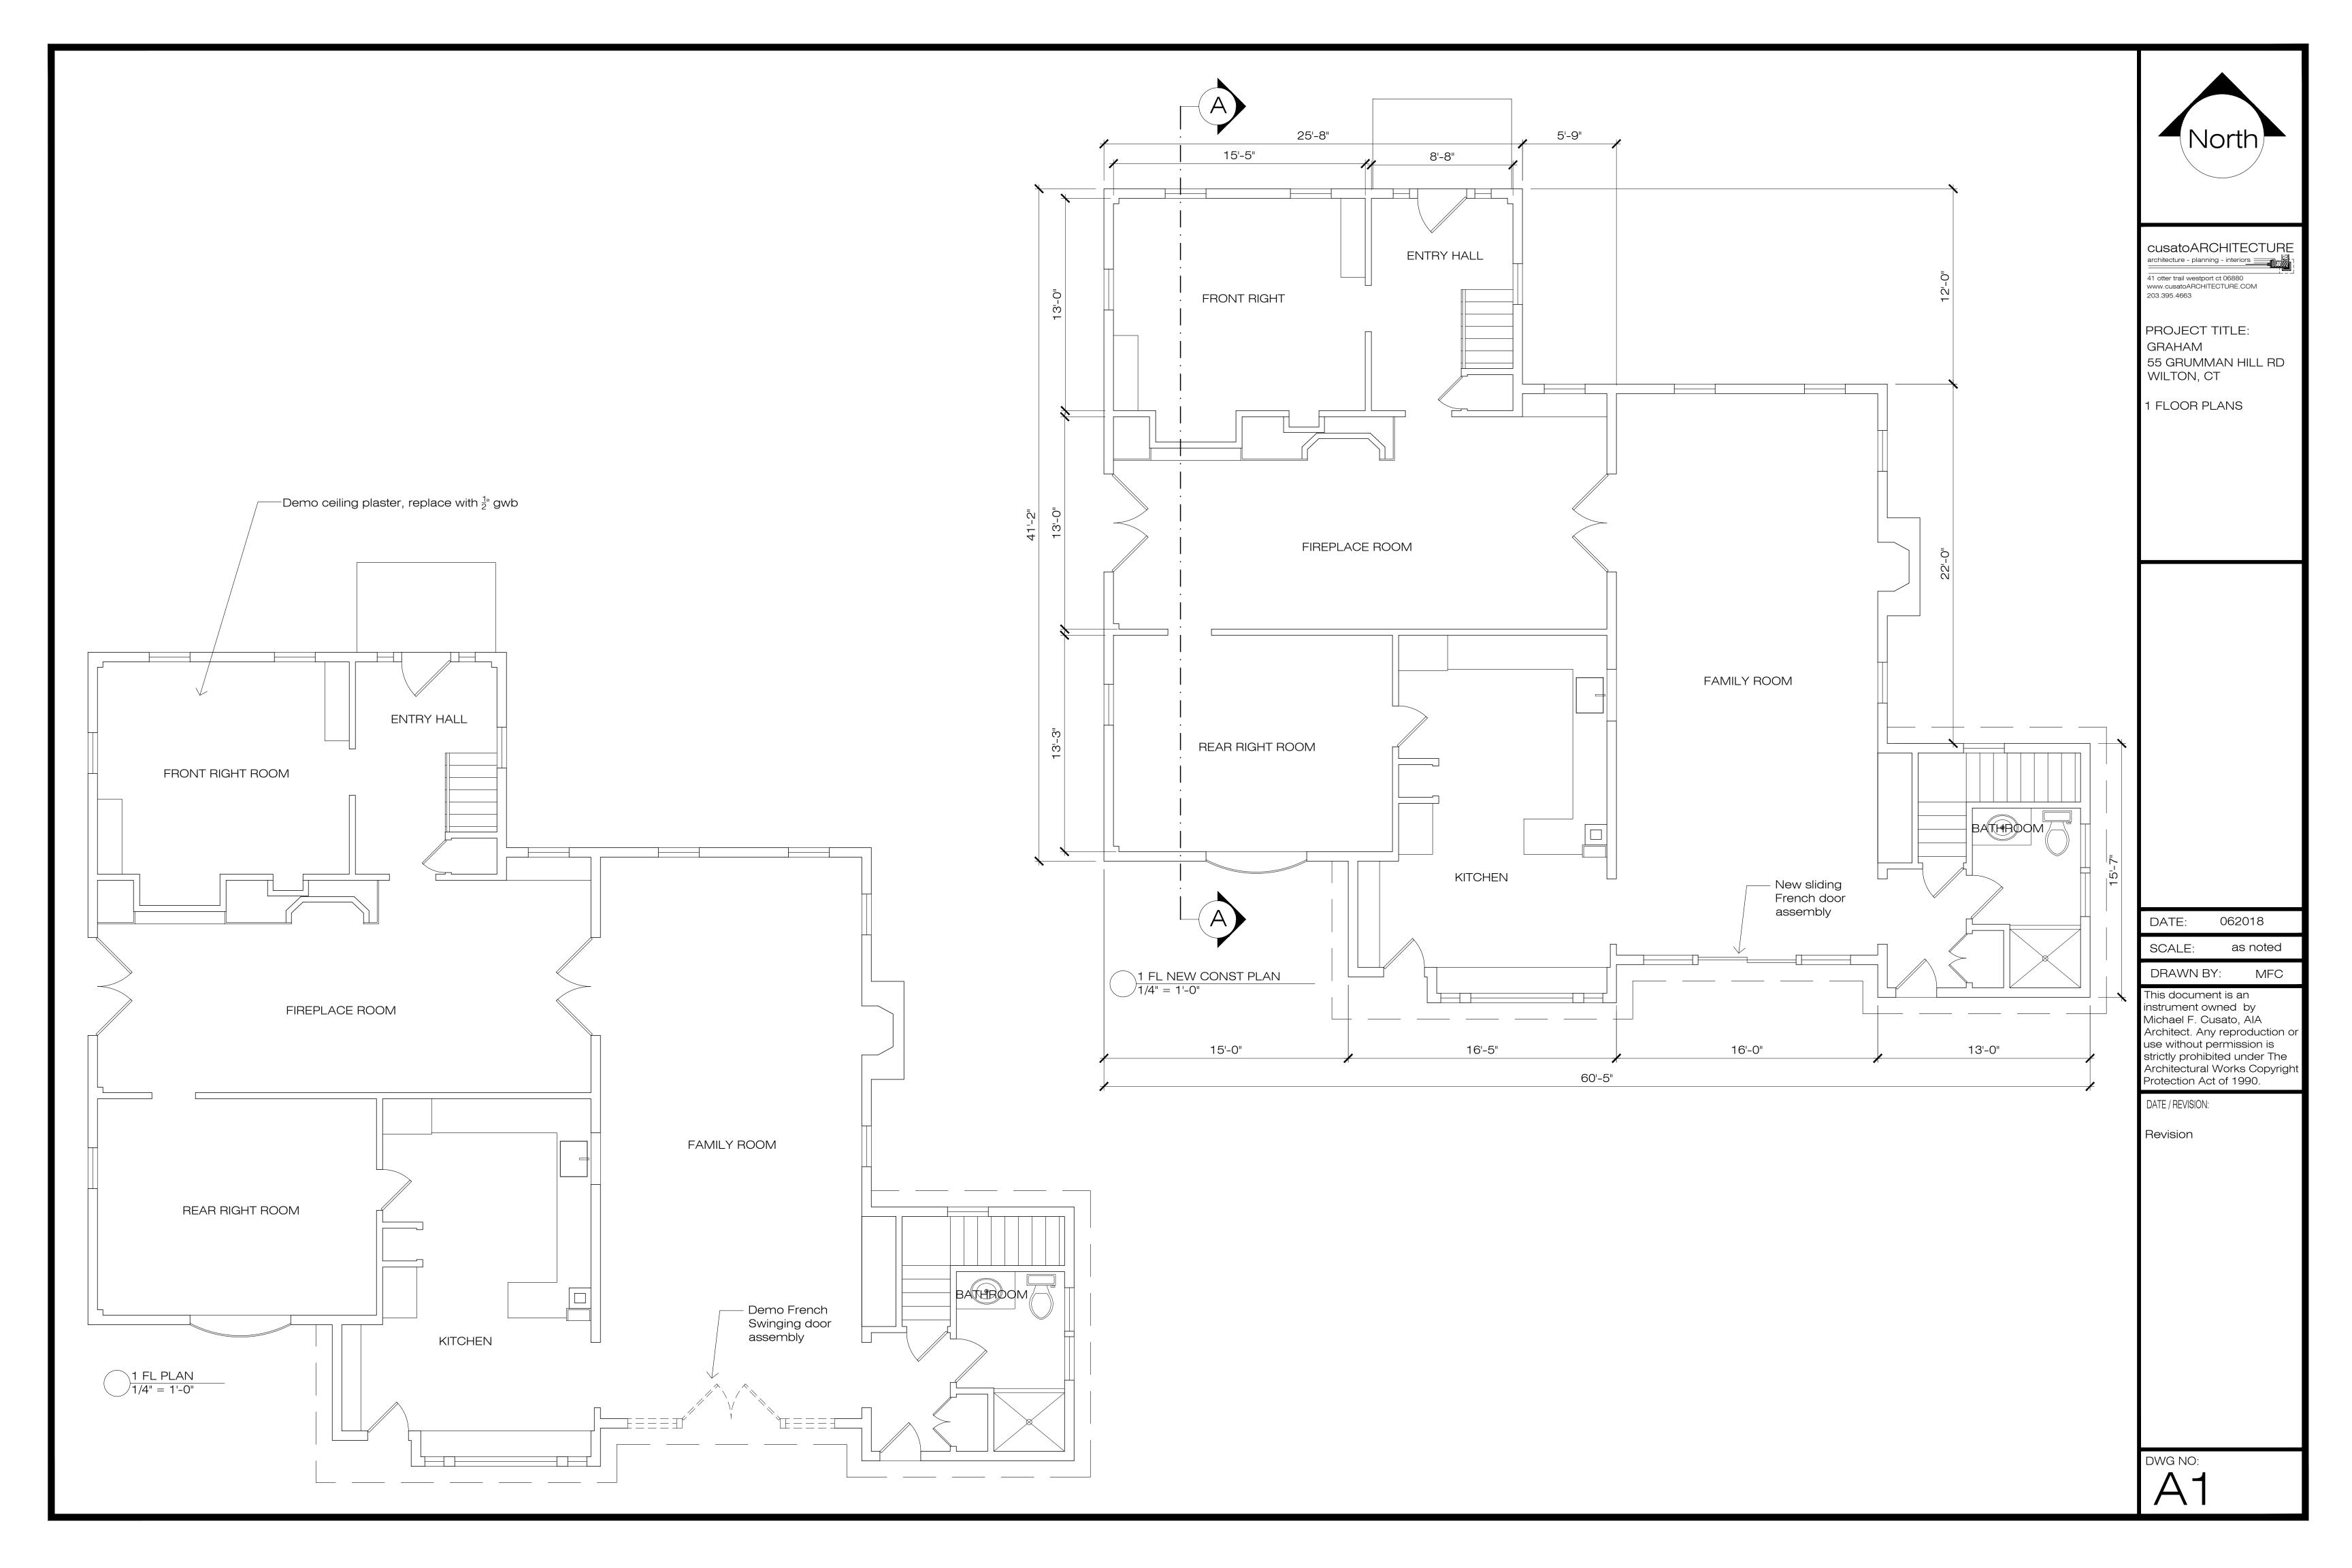

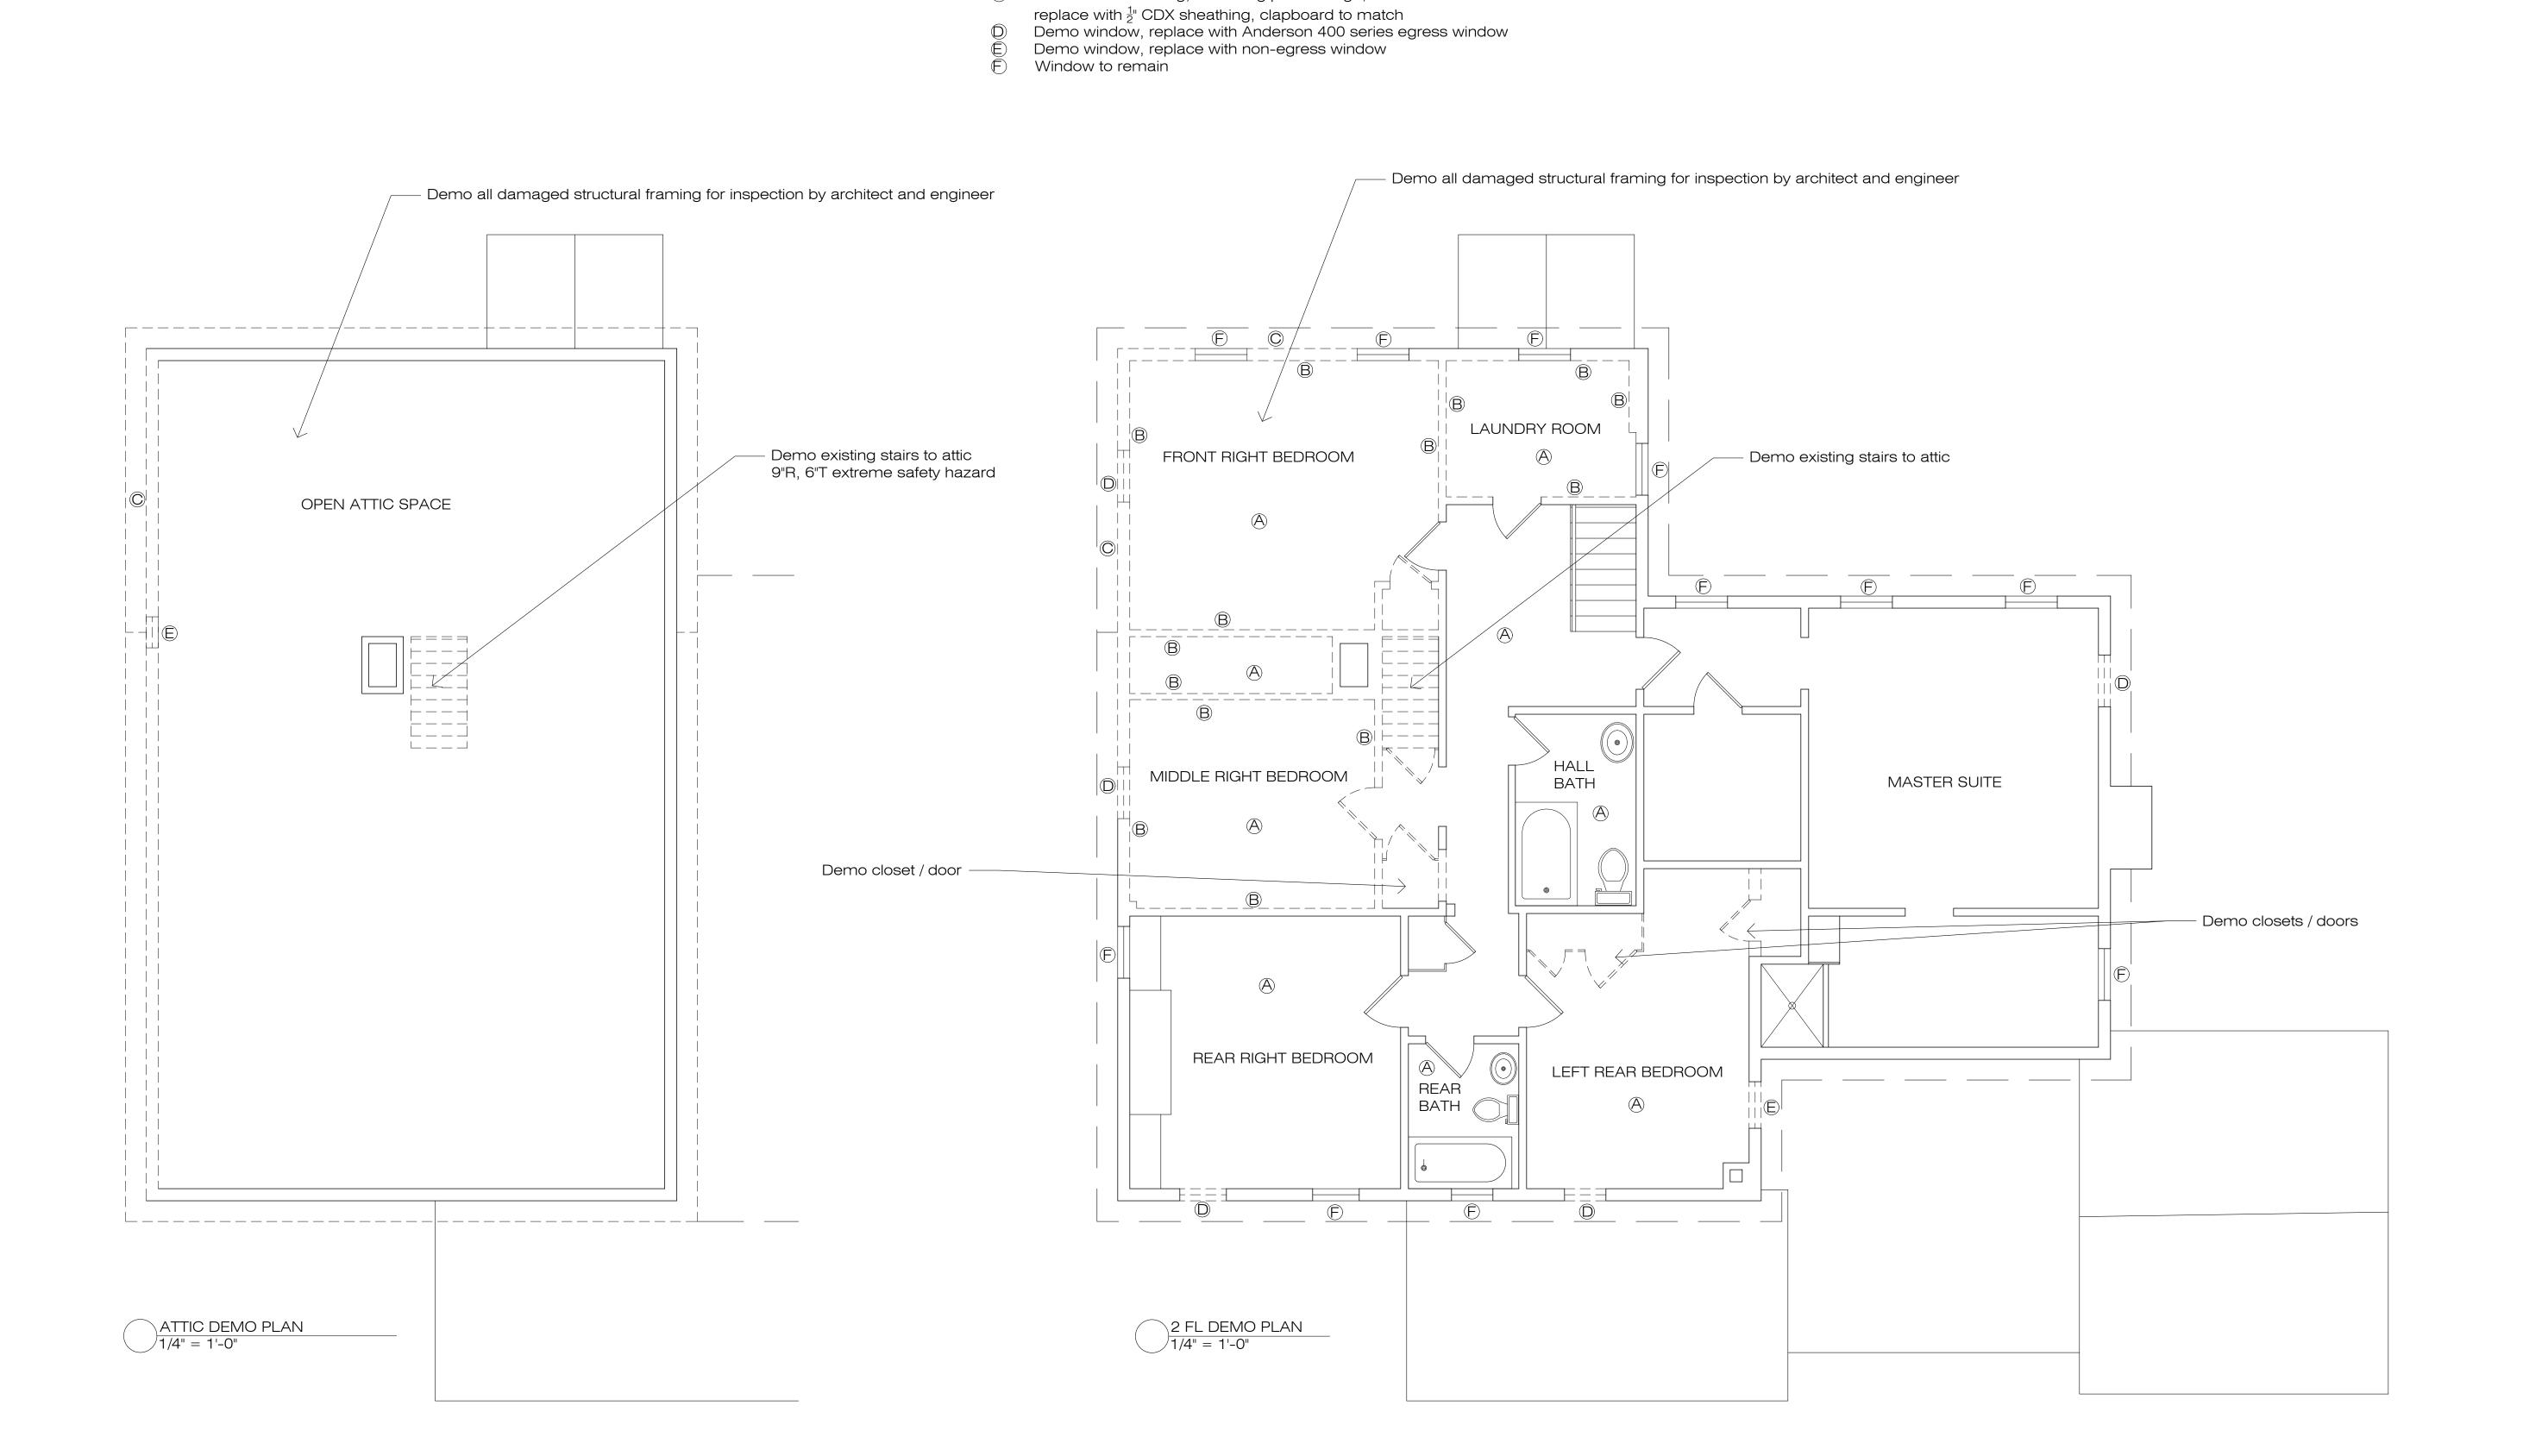

Demo ceiling plaster, replace with $\frac{1}{2}$ gwb

Demo wall plaster, replace with ½" gwb
 Demo exterior siding, sheathing per damage,

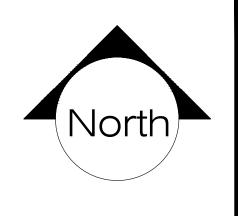

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2 FL DEMO PLAN ATTIC DEMO PLAN

DATE: 062018


SCALE: as noted


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PROJECT TITLE:
GRAHAM
55 GRUMMAN HILL RD
WILTON, CT

2 FL PLAN ATTIC PLAN

DATE: 062018

SCALE: as noted
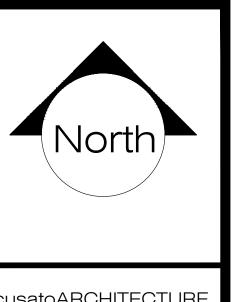
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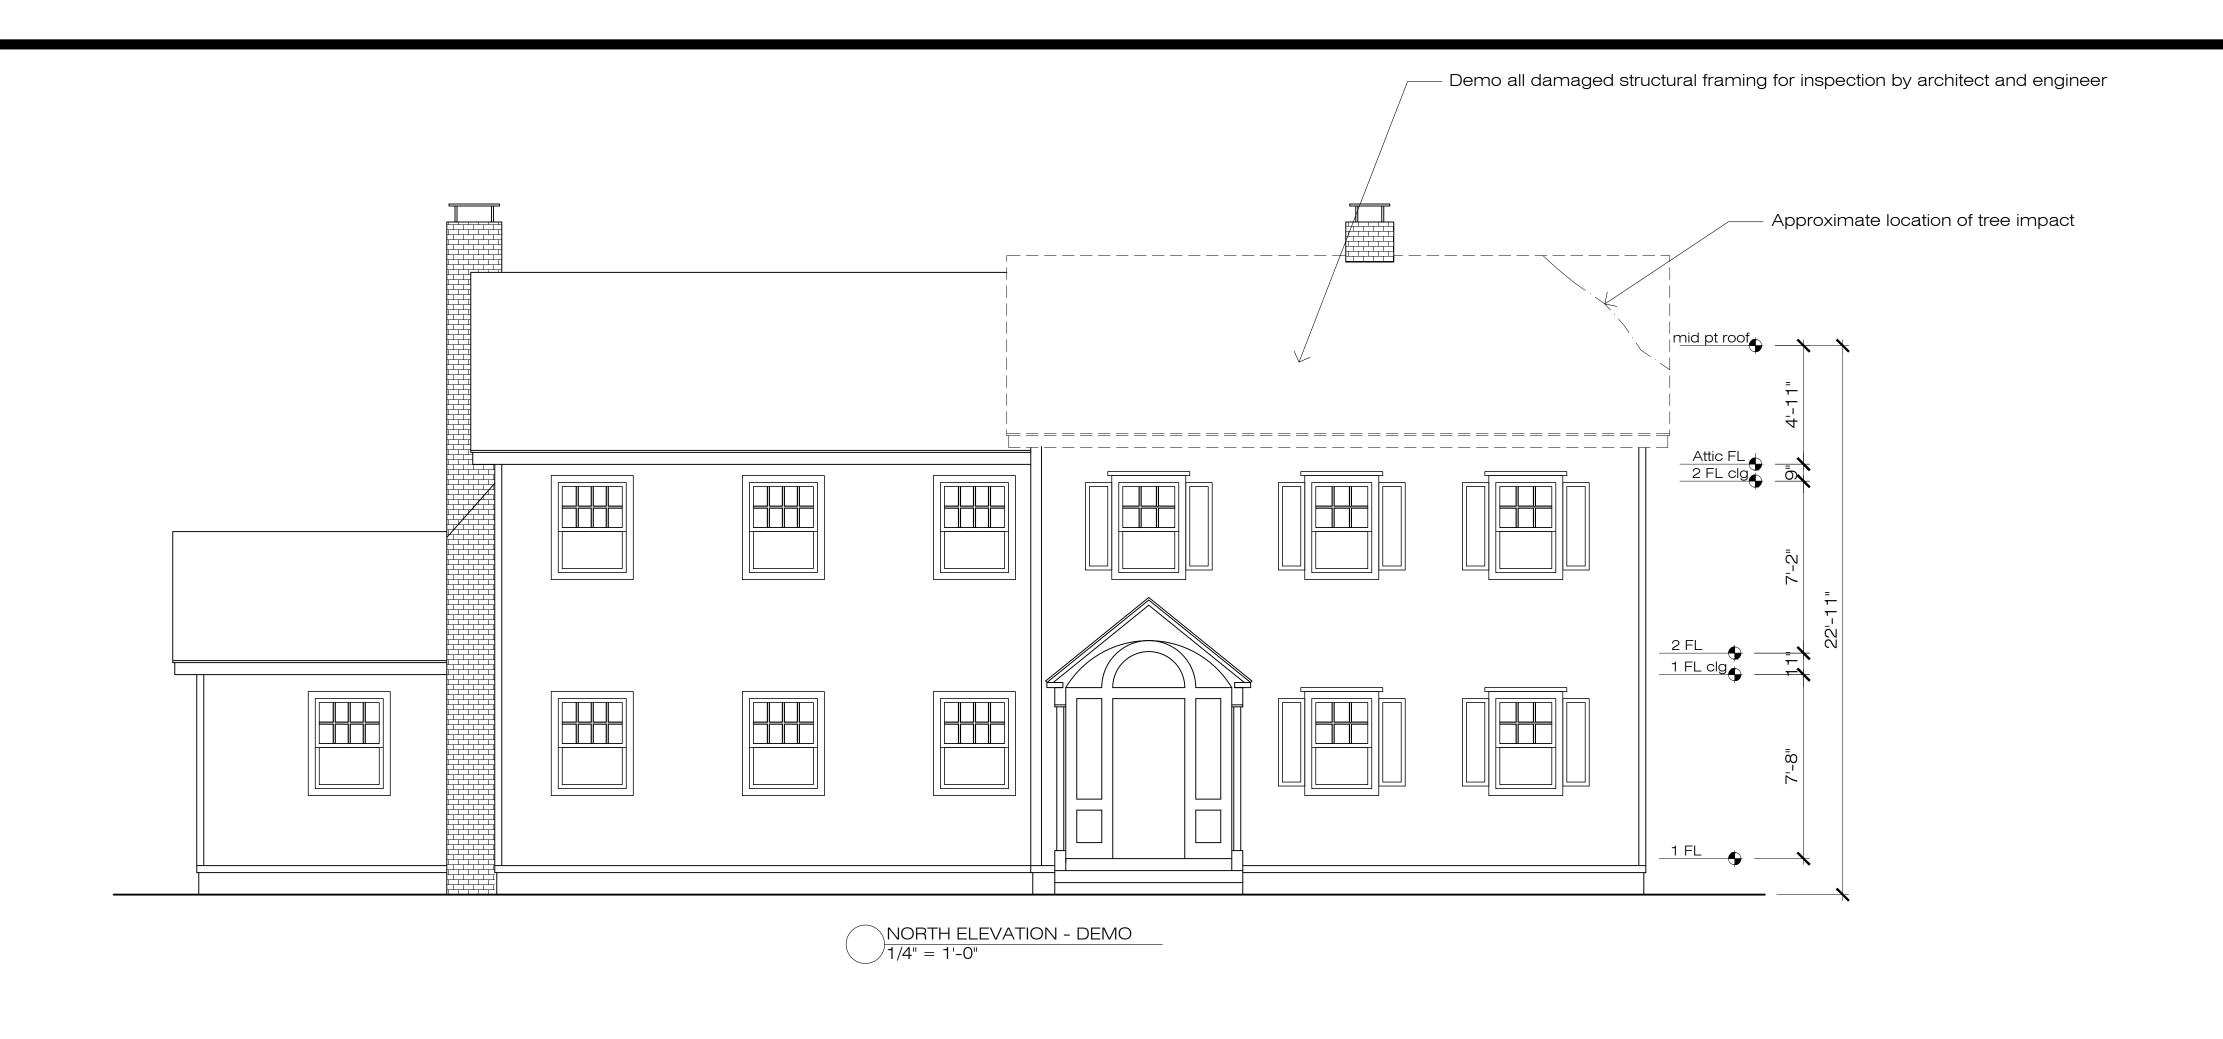
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DWG NO:

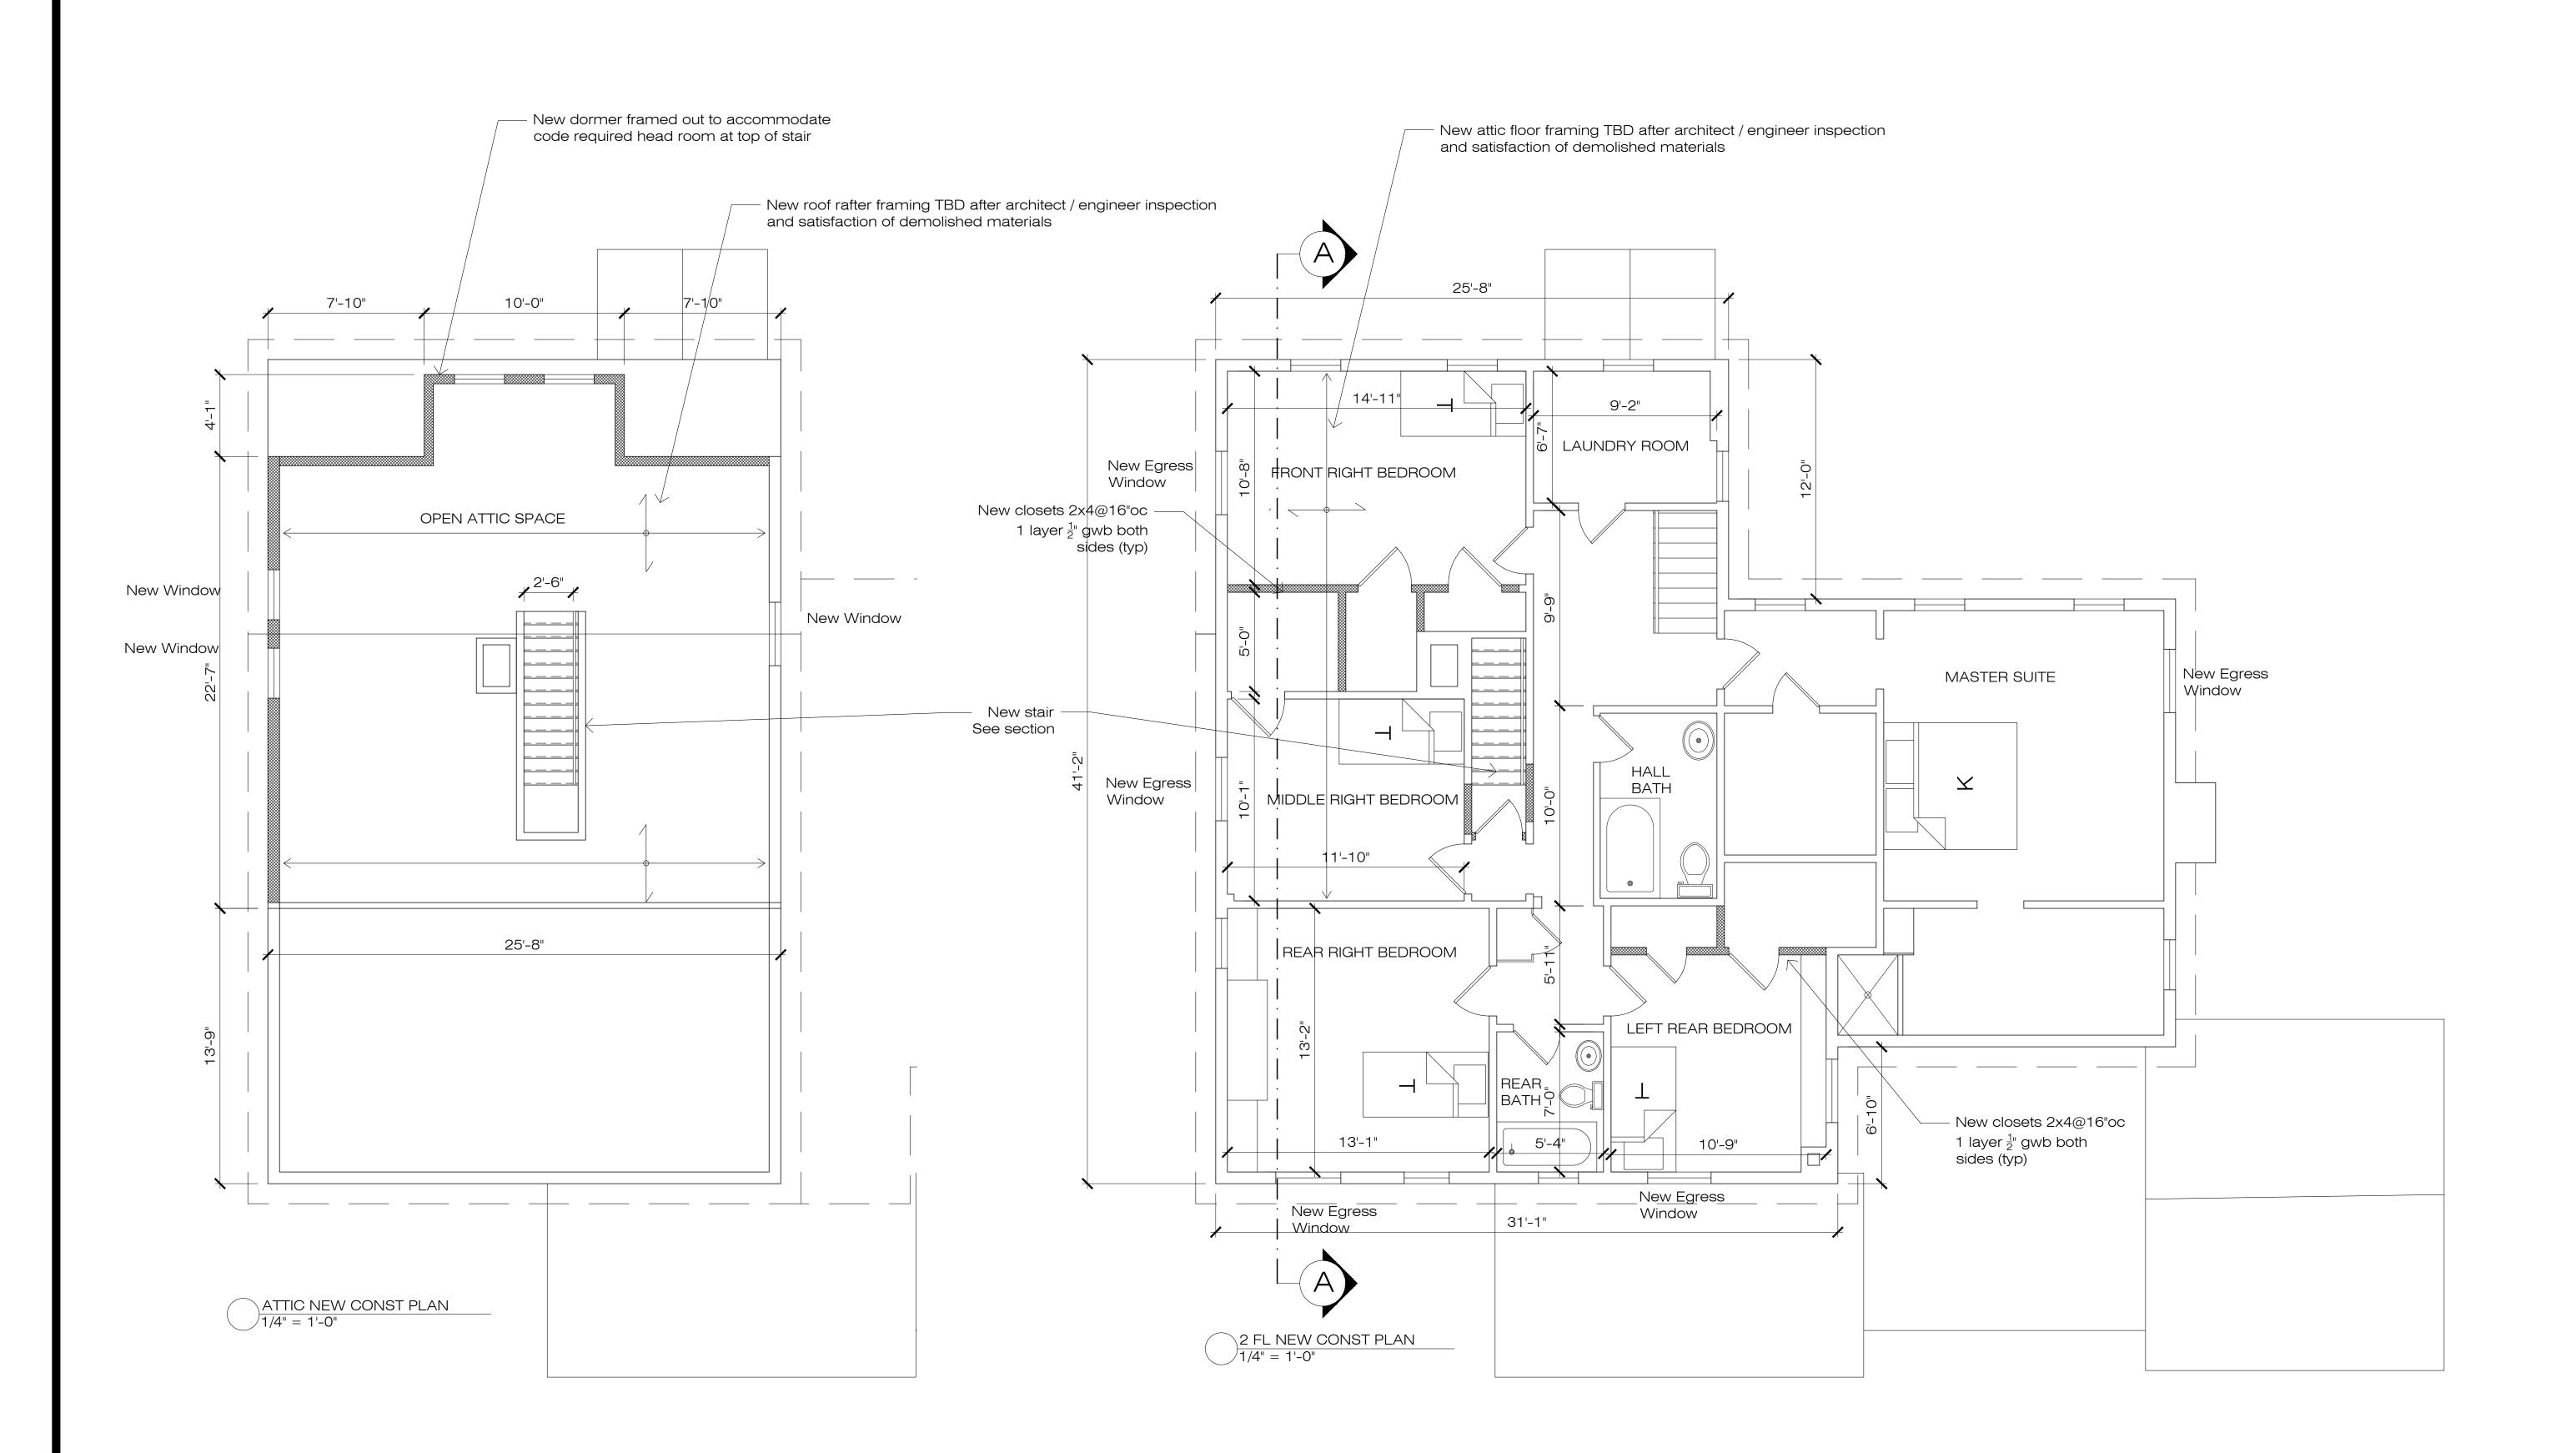A3





PROJECT TITLE:
GRAHAM
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WILTON, CT

NORTH ELEVATION

DATE: 062018

SCALE: as noted

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PROJECT TITLE:
GRAHAM
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WILTON, CT

SOUTH ELEVATION

DATE: 062018


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PROJECT TITLE:
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EAST ELEVATION

DATE: 062018

SCALE: as noted

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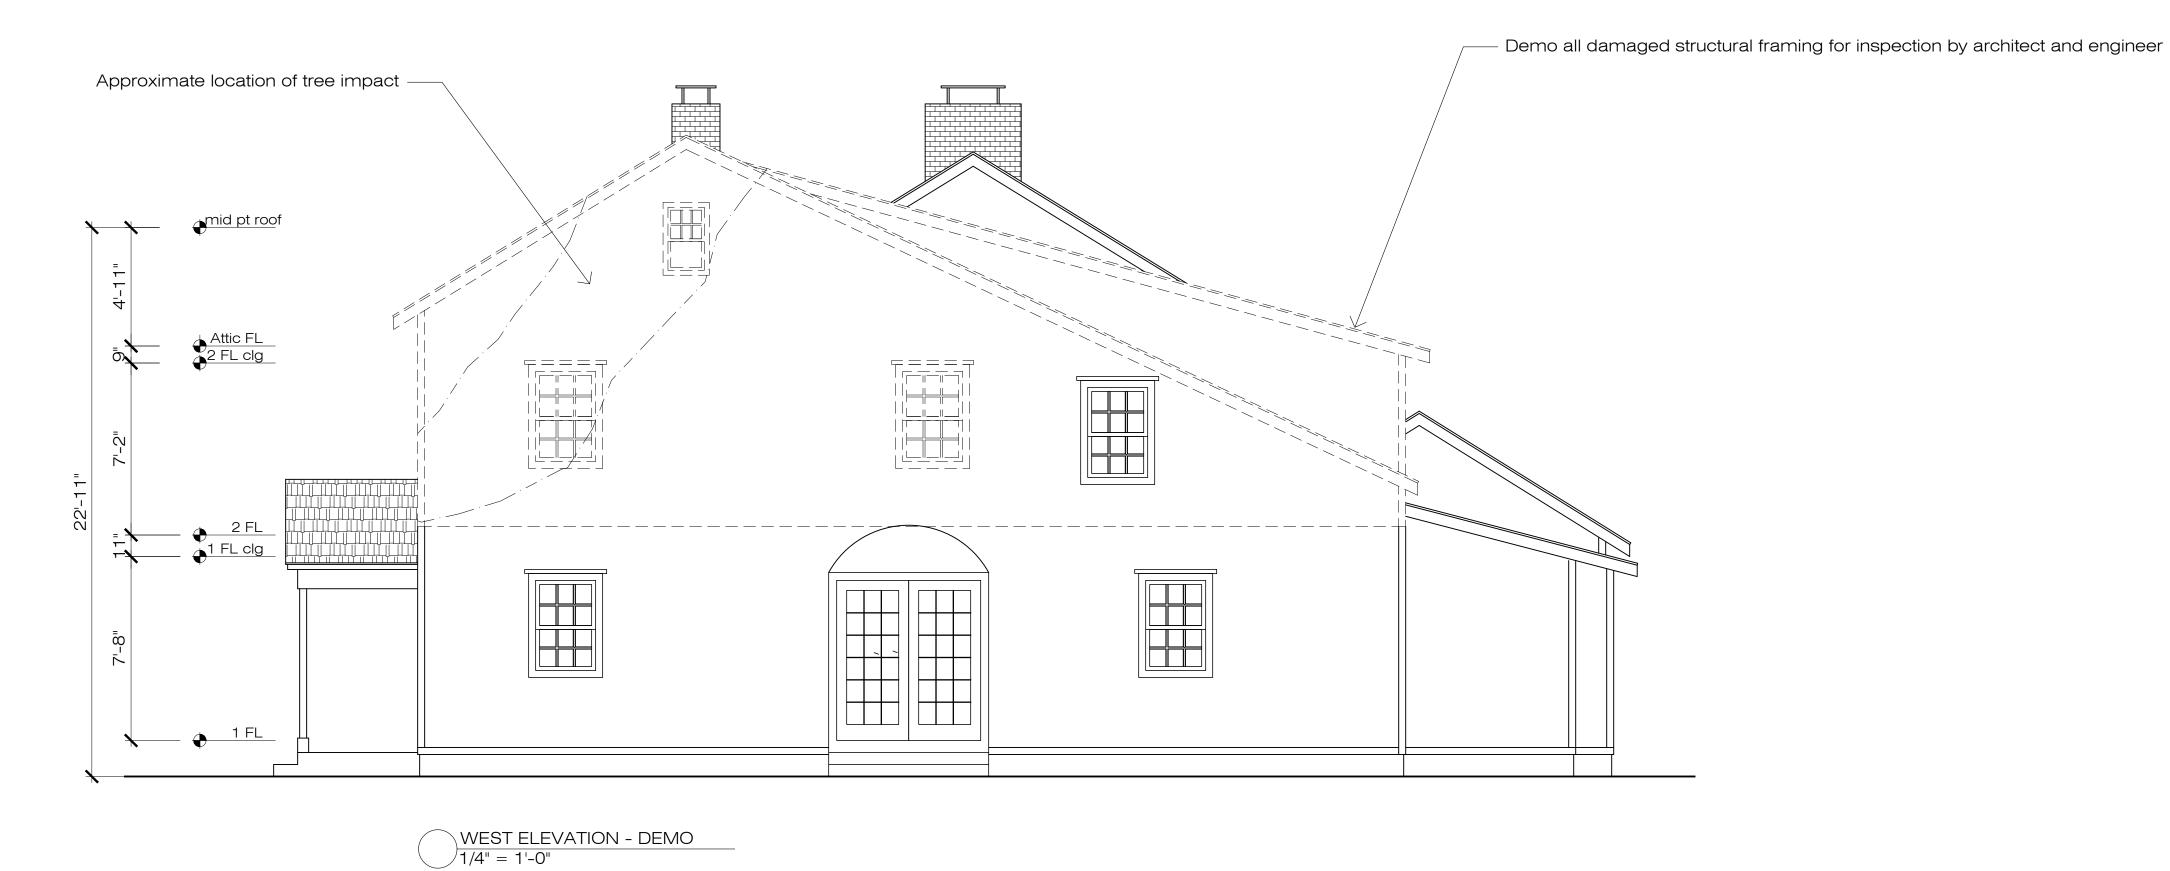
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DATE / REVISION:

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DWG NO:

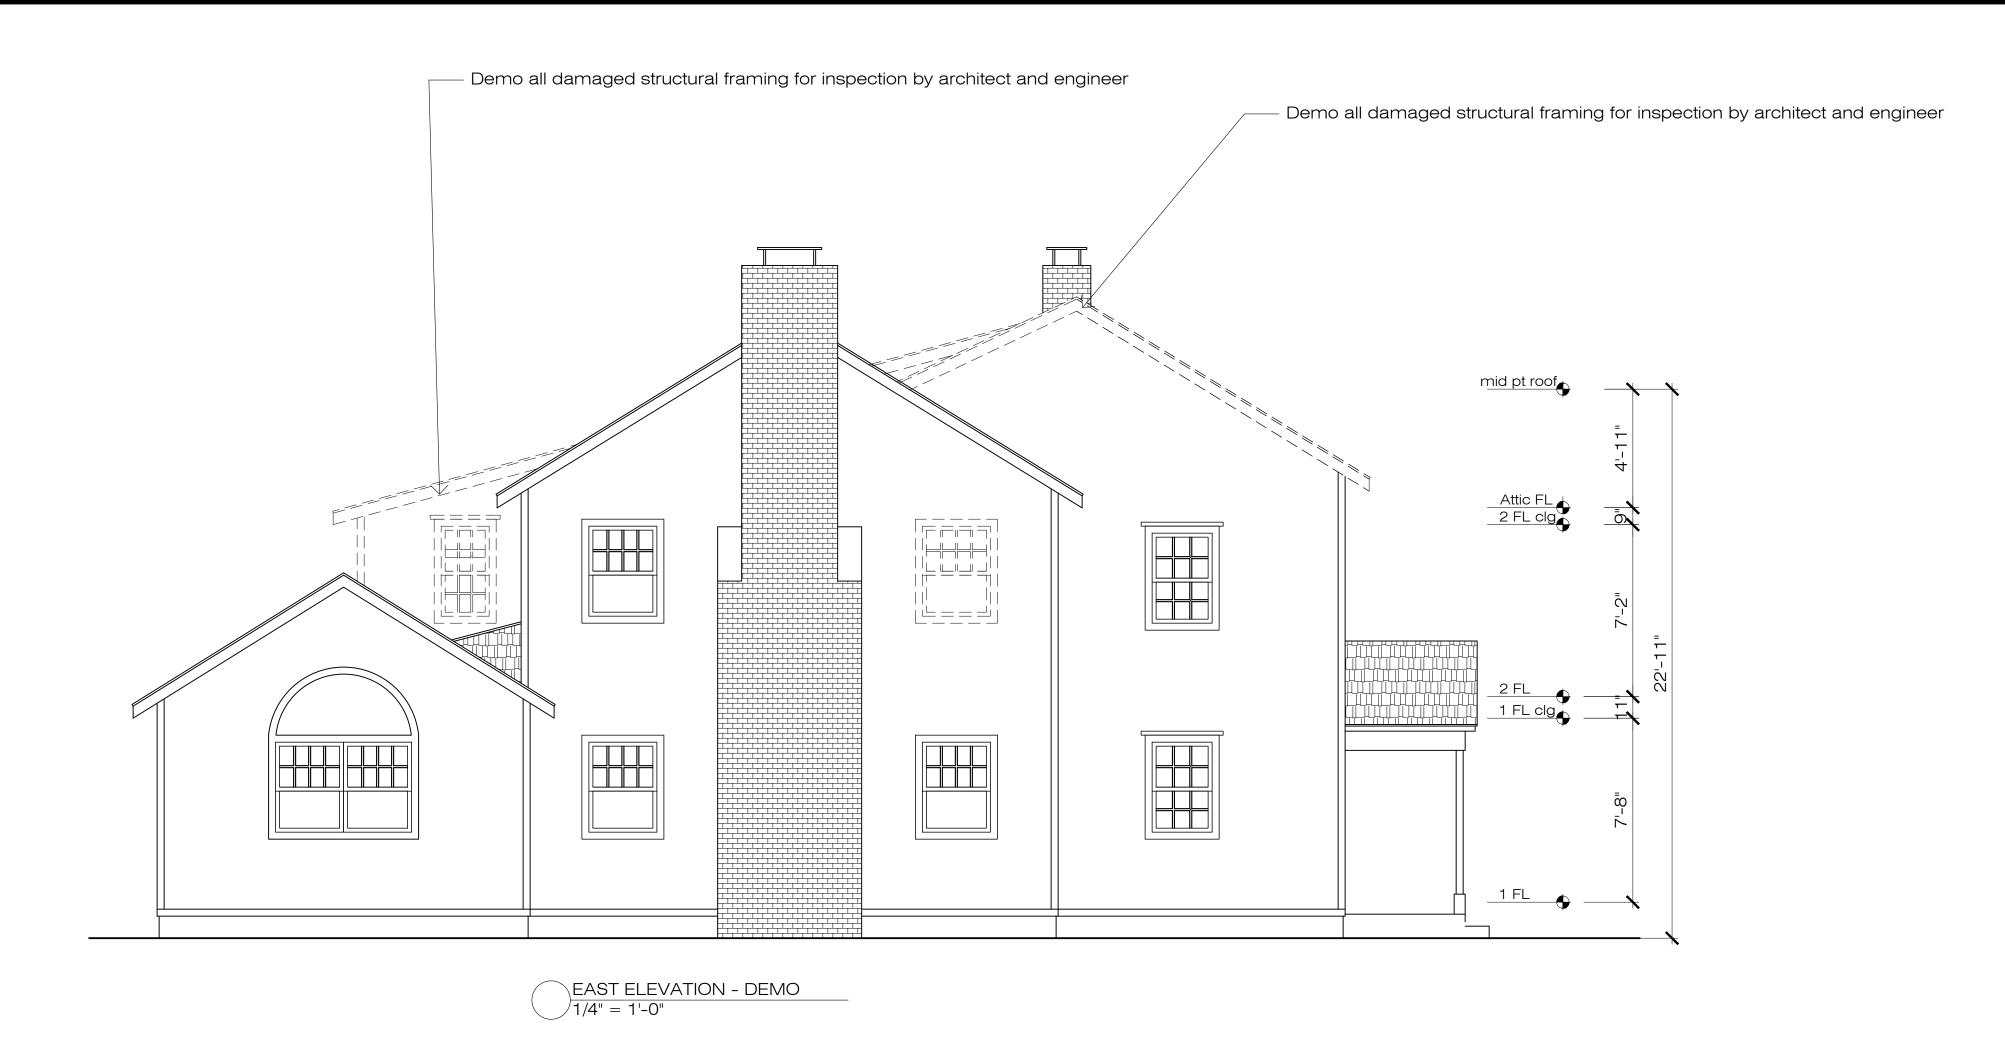A6



mid pt roof Attic FL 2 FL clg New Egress
Window New Egress Window 2 FL 1 FL clg **♦** 1 FL

WEST ELEVATION - PROPOSED

1/4" = 1'-0"

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WEST ELEVATION

DATE: 062018

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