#### WILTON ZONING BOARD OF APPEALS - RESIDENTIAL VARIANCE APPLICATION - ZBA#

Please consult the Zoning Regulations when applying for a variance, particularly Section 29-13.


Please TYPE or print clearly... (See last 2 pages for brief explanation.)

VIKENESWARAN BALASUB	RAMANIAM 25 OVERIDGE LU.
ANNA MARIA MALIK APPLICANT'S NAME	ADDRESS
SAME	
OWNER'S NAME	ADDRESS
25 1 1 2 2 2 1 1	R-2A
25 Over18ge IN PROPERTY LOCATION	ZOMNIC DICTRICT
	$-\frac{4}{\text{TAX MAP # LOT #}} \frac{34/1}{\text{LOT #}} \frac{2.02 \text{ AC}}{\text{ACREAGE}}$
WLR MAP# 2459 443 VOLUME PAGE	TAX MAP # LOT # ACREAGE
WER MAI # VOLUME FAGE	THAT WILL III
setback in lieu of the required 50 feet." ATTAC	ction 29-5.D to allow <u>a building addition</u> with <u>a 43 foot rear yard</u> CH SEPARATE SHEETS AS REQUIRED.
would read as follows: "Request a variance of Sesetback in lieu of the required 50 feet." ATTAC Request a Unerauce of  Roof projection of 3,  1.5 ft (South 51)  Projection feam He  HARDSHIP DESCRIPTION: In the space belo	ction 29-5.D to allow a building addition with a 43 foot rear yard  CH SEPARATE SHEETS AS REQUIRED.  Sec. 29-4". E-2 To Allow  7 FT (NORTH 5 DE) AND  e) IN 1184 of 1 AT-  to North Sequines SET BACK.  Town, state the specific conditions pertaining to the perceived
would read as follows: "Request a variance of Sesetback in lieu of the required 50 feet." ATTACK  Request a Unriance of Roof Projection of 3.  I. STY South SID  PREJECTION PERMITTEE  HARDSHIP DESCRIPTION: In the space below "exceptional difficulty or unusual hardship" with zoning district, which would make development is difficult. ATTACH SEPARATE SHEETS AS R	ction 29-5.D to allow a building addition with a 43 foot rear yard the SEPARATE SHEETS AS REQUIRED.  Sec. 29-4.E.2 To Allow  The following the partial of the perceived respect to the parcel of land, not generally encountered within the in full accordance with the existing Zoning Regulations extremely EQUIRED.
would read as follows: "Request a variance of Sesetback in lieu of the required 50 feet." ATTACK  Request a Unriance of Roof Projection of 3.  I. STY South SID  PREJECTION PERMITTEE  HARDSHIP DESCRIPTION: In the space below "exceptional difficulty or unusual hardship" with zoning district, which would make development is difficult. ATTACH SEPARATE SHEETS AS R	ction 29-5.D to allow a building addition with a 43 foot rear yard the SEPARATE SHEETS AS REQUIRED.  Sec. 29-4.E.2 To Allow  The foot of the second of the s
would read as follows: "Request a variance of Sesetback in lieu of the required 50 feet." ATTACK  Request a Unerance of  Roof Projection of 3,  1.5 Lt (South 51)  Projection Feant He  HARDSHIP DESCRIPTION: In the space belowers to be a company of the company of the control of	ction 29-5.D to allow a building addition with a 43 foot rear yard  CH SEPARATE SHEETS AS REQUIRED.  Sec. 29-4. E. 2 To Allow  The world superated and the superate of the perceived respect to the parcel of land, not generally encountered within the notiful accordance with the existing Zoning Regulations extremely EQUIRED.  IN Dimension Where Residence
would read as follows: "Request a variance of Sesetback in lieu of the required 50 feet." ATTACK  Request a Unerance of  Roof Projection of 3,  1.5 Lt (South 51)  Projection Feant He  HARDSHIP DESCRIPTION: In the space belowers to be a company of the company of the control of	ction 29-5.D to allow a building addition with a 43 foot rear yard  CH SEPARATE SHEETS AS REQUIRED.  Sec. 29-4. E. 2 To Allow  The world superation of the superation of the perceived of the per
would read as follows: "Request a variance of Sesetback in lieu of the required 50 feet." ATTACK  Request a Unerance of  Roof Projection of 3,  1.5 ft (South 51)  Projection Permittee  HARDSHIP DESCRIPTION: In the space below "exceptional difficulty or unusual hardship" with zoning district, which would make development in difficult. ATTACH SEPARATE SHEETS AS R  LOT 15 MARROW  CONSTRUCTED, 40 Se  Residence - Only	ction 29-5.D to allow a building addition with a 43 foot rear yard the SEPARATE SHEETS AS REQUIRED.  Sec. 29-4.E.2 To Allow  The foot of the second of the s

All submitted plans and documents shall bear the signature, seal and license number, as appropriate, of the professional responsible for preparing each item.

All plans shall be collated into sets (either clipped or stapled), with maps folded (not rolled).

SUBMIX TEN (10) COLLATED SETS (INCLUDING 1 ORIGINAL SET) OF THE FOLLOWING DOCUMENTS:
APPLICATION FORM
LIST OF OWNERS WITHIN 500' of the subject property as shown by Tax Map & Lot #.
A-2 SURVEY of the subject property showing all existing building and site conditions.
SITE DEVELOPMENT PLAN showing all proposed additions, amendments and/or site improvements, including building elevations, septic systems, wells, and all measurements pertaining to the application, such as location and distance(s) of proposed structures and/or improvements from the subject property lines.
LOCATION MAP at a scale of 1"=800' or less. Said map shall identify the site location and shall show the surrounding area and streets.
DIRECTIONS to subject property from Town Hall, 238 Danbury Road, Wilton, CT (e.g. hand-written, computer-generated or similar).
LIST OF PREVIOUS ZONING VARIANCES describing any variances and the action taken.
PHOTOGRAPHS of property showing building and site conditions from all geographic perspectives.
ALSO SUBMIT:
ONE COPY OF DEED INCLUDED WITH ORIGINAL SET ONLY (Obtain in Town Clerk's Office)
ENVELOPES, addressed to each property owner within 500' (see "Envelopes Instructions" online)
ELECTRONIC EMAILED SUBMISSION of all materials (Consolidated into 1-2 PDFs Maximum)
TWO #10 (4"x 9.5") PLAIN ENVELOPES addressed to the applicant (No Return Address)
\$310 FILING FEE payable to: Town of Wilton
IS THE SUBJECT PROPERTY LOCATED WITHIN 500 FEET OF THE MUNICIPAL BORDER? YES or NO
IS THE SUBJECT PROPERTY LOCATED WITHIN THE PUBLIC WATER SUPPLY WATERSHED BOUNDARY? YES or NO [If YES, contact Planning & Zoning Dept for DPH Addendum Form.]
IS THE SUBJECT PROPERTY LOCATED IN THE FLOOD PLAIN? YES of NO
WHEN WAS THE SUBJECT PROPERTY PURCHASED? /1/18/2016
IN WHAT YEAR WAS THE MAIN STRUCTURE CONSTRUCTED? 2020
SITE COVERAGE PROPOSED: 2000 BUILDING COVERAGE PROPOSED: 300 WITH DAY (AS PERCENTAGE OF SITE) (AS PERCENTAGE OF SITE)
·disturbance)
THE APPLICANT understands that this application is to be considered complete only when all information and documents required by the Board have been submitted.  THE UNDERSIGNED WARRANTS the truth of all statements contained herein and in all supporting documents according to the best of his or her knowledge and belief; and hereby grants visitation and inspection of the subject property as described herein.
APPLICANT'S SIGNATURE DATE EMAIL ADDRESS A TELEPHONE
(SAME) DATE EVALE ADDRESS 1203 3410
OWNER'S SIGNATURE DATE EMAIL ADDRESS TELEPHONE

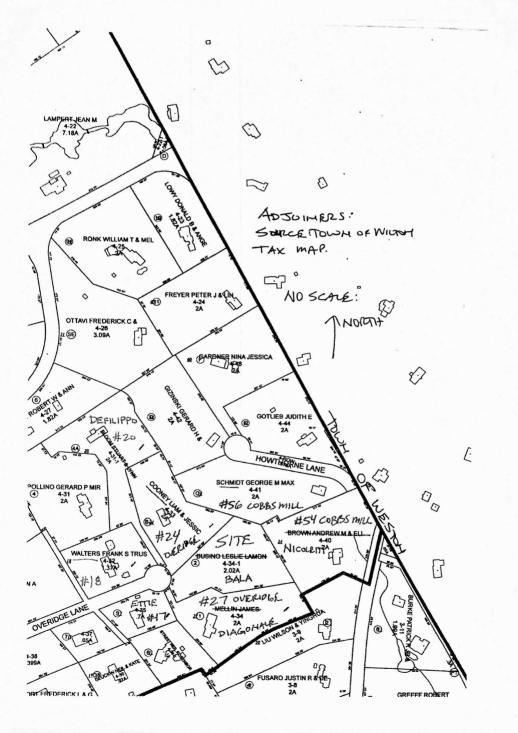

3-1 3-1-1 3-2-1 SCHNEIDER THOMAS P & LEE ANN MCN HAASE JON F & MARGARET C **DARST DANIEL &** 50 STURGES RIDGE RD 48 STURGES RIDGE RD 1054 RIDGEFIELD RD WILTON CT 06897 WILTON CT 06897 WILTON CT 06897 3-8 3-9 3-10 PIAZZA JOHN & FRIDA **FUSARO JUSTIN R & DEARTA L GOLDBLATT ROBERT & ELANA** 40 COBBS MILL RD 50 COBBS MILL RD 66 OLD MILL RD WESTON WILTON CT 06897 WILTON CT 06897 CT 06883 3-11 3-12 3-21-1 **GREEFF ROBERT & KERRY A** KIM EUN-KYUNG C TRUSTEE **BURKE PATRICK R JR & KIMBERLY S** 51 COBBS MILL RD 37 COBBS MILL RD 70 OLD MILL RD WILTON CT 06897 WILTON WESTON CT 06897 CT 06883 4-30 4-31 4-31-1 ANDA JON A **CONTI GRIFFITH & LEITTEN ANDREW &** 76 STURGES RIDGE RD 16 OVERIDGE LA 20 OVERIDGE LA WILTON CT 06897 WILTON CT 06897 WILTON CT 06897 4-32 4-33 4-34 WALTERS FRANK S TRUSTEE PROANO RENZO & DIAGONALE MARC & JENNIFER 18 OVERIDGE LA 24 OVERIDGE LA 27 OVERIDGE LA WILTON CT 06897 WILTON CT 06897 WILTON CT 06897 4-34-1 4-35 4-36 **BALASUBRAMANIAM VIKENESWARAN & ETTIE DEREK & SUZANNE DEGASPERI ANDREW LODOVICO &** 3540 PARK AVE 17 OVERIDGE LA 19 OVERIDGE LA CT 06604 BRIDGEPORT WILTON CT 06897 WILTON CT 06897 4-36-1 4-37 4-38 STREET NEIL HISCOCK JOHN M & CATHERINE M WEHRLI GREGORY R AS TR REVOC 21 OVERIDGE LA 5080 N OCEAN DR APT 10D 5 OVERIDGE LA WILTON RIVIERA BEACH WILTON CT 06897 FL 33404 CT 06897 4-39 4-40 4-41 FORT FREDERICK L NICOLETTI ROCCO & TARA AVD CONSULTING LLC **58 STURGES RIDGE RD** 54 COBBS MILL RD 56 COBBS MILL RD

WILTON

WILTON

PIEDRA BEVERLY

60 COBBS MILL RD

4-43

CT 06897

CT 06897

WILTON

WILTON

**GOTLIEB JUDITH E** 

62 COBBS MILL RD

4-44

CT 06897

CT 06897


WILTON CT 06897


4-42


**TALAK TOMAS & JITKA** 58 COBBS MILL RD

WILTON CT 06897


3-2-2 **GITTES DANIEL &** 36 STURGES RIDGE RD WILTON CT 06897

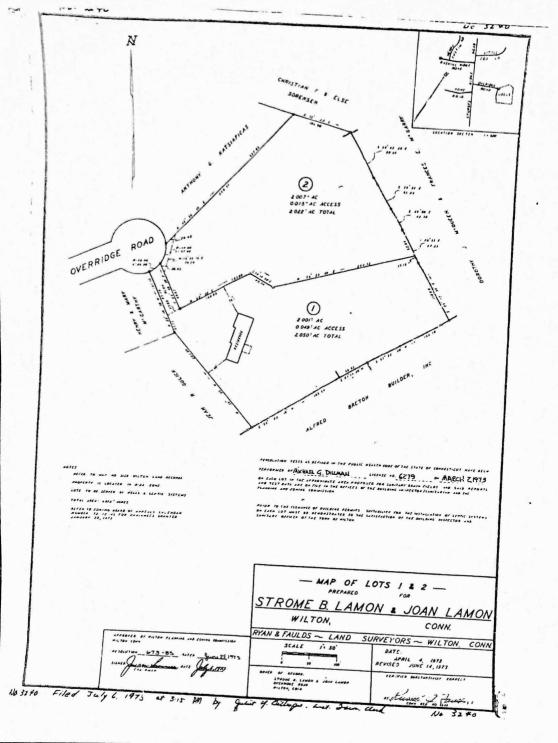

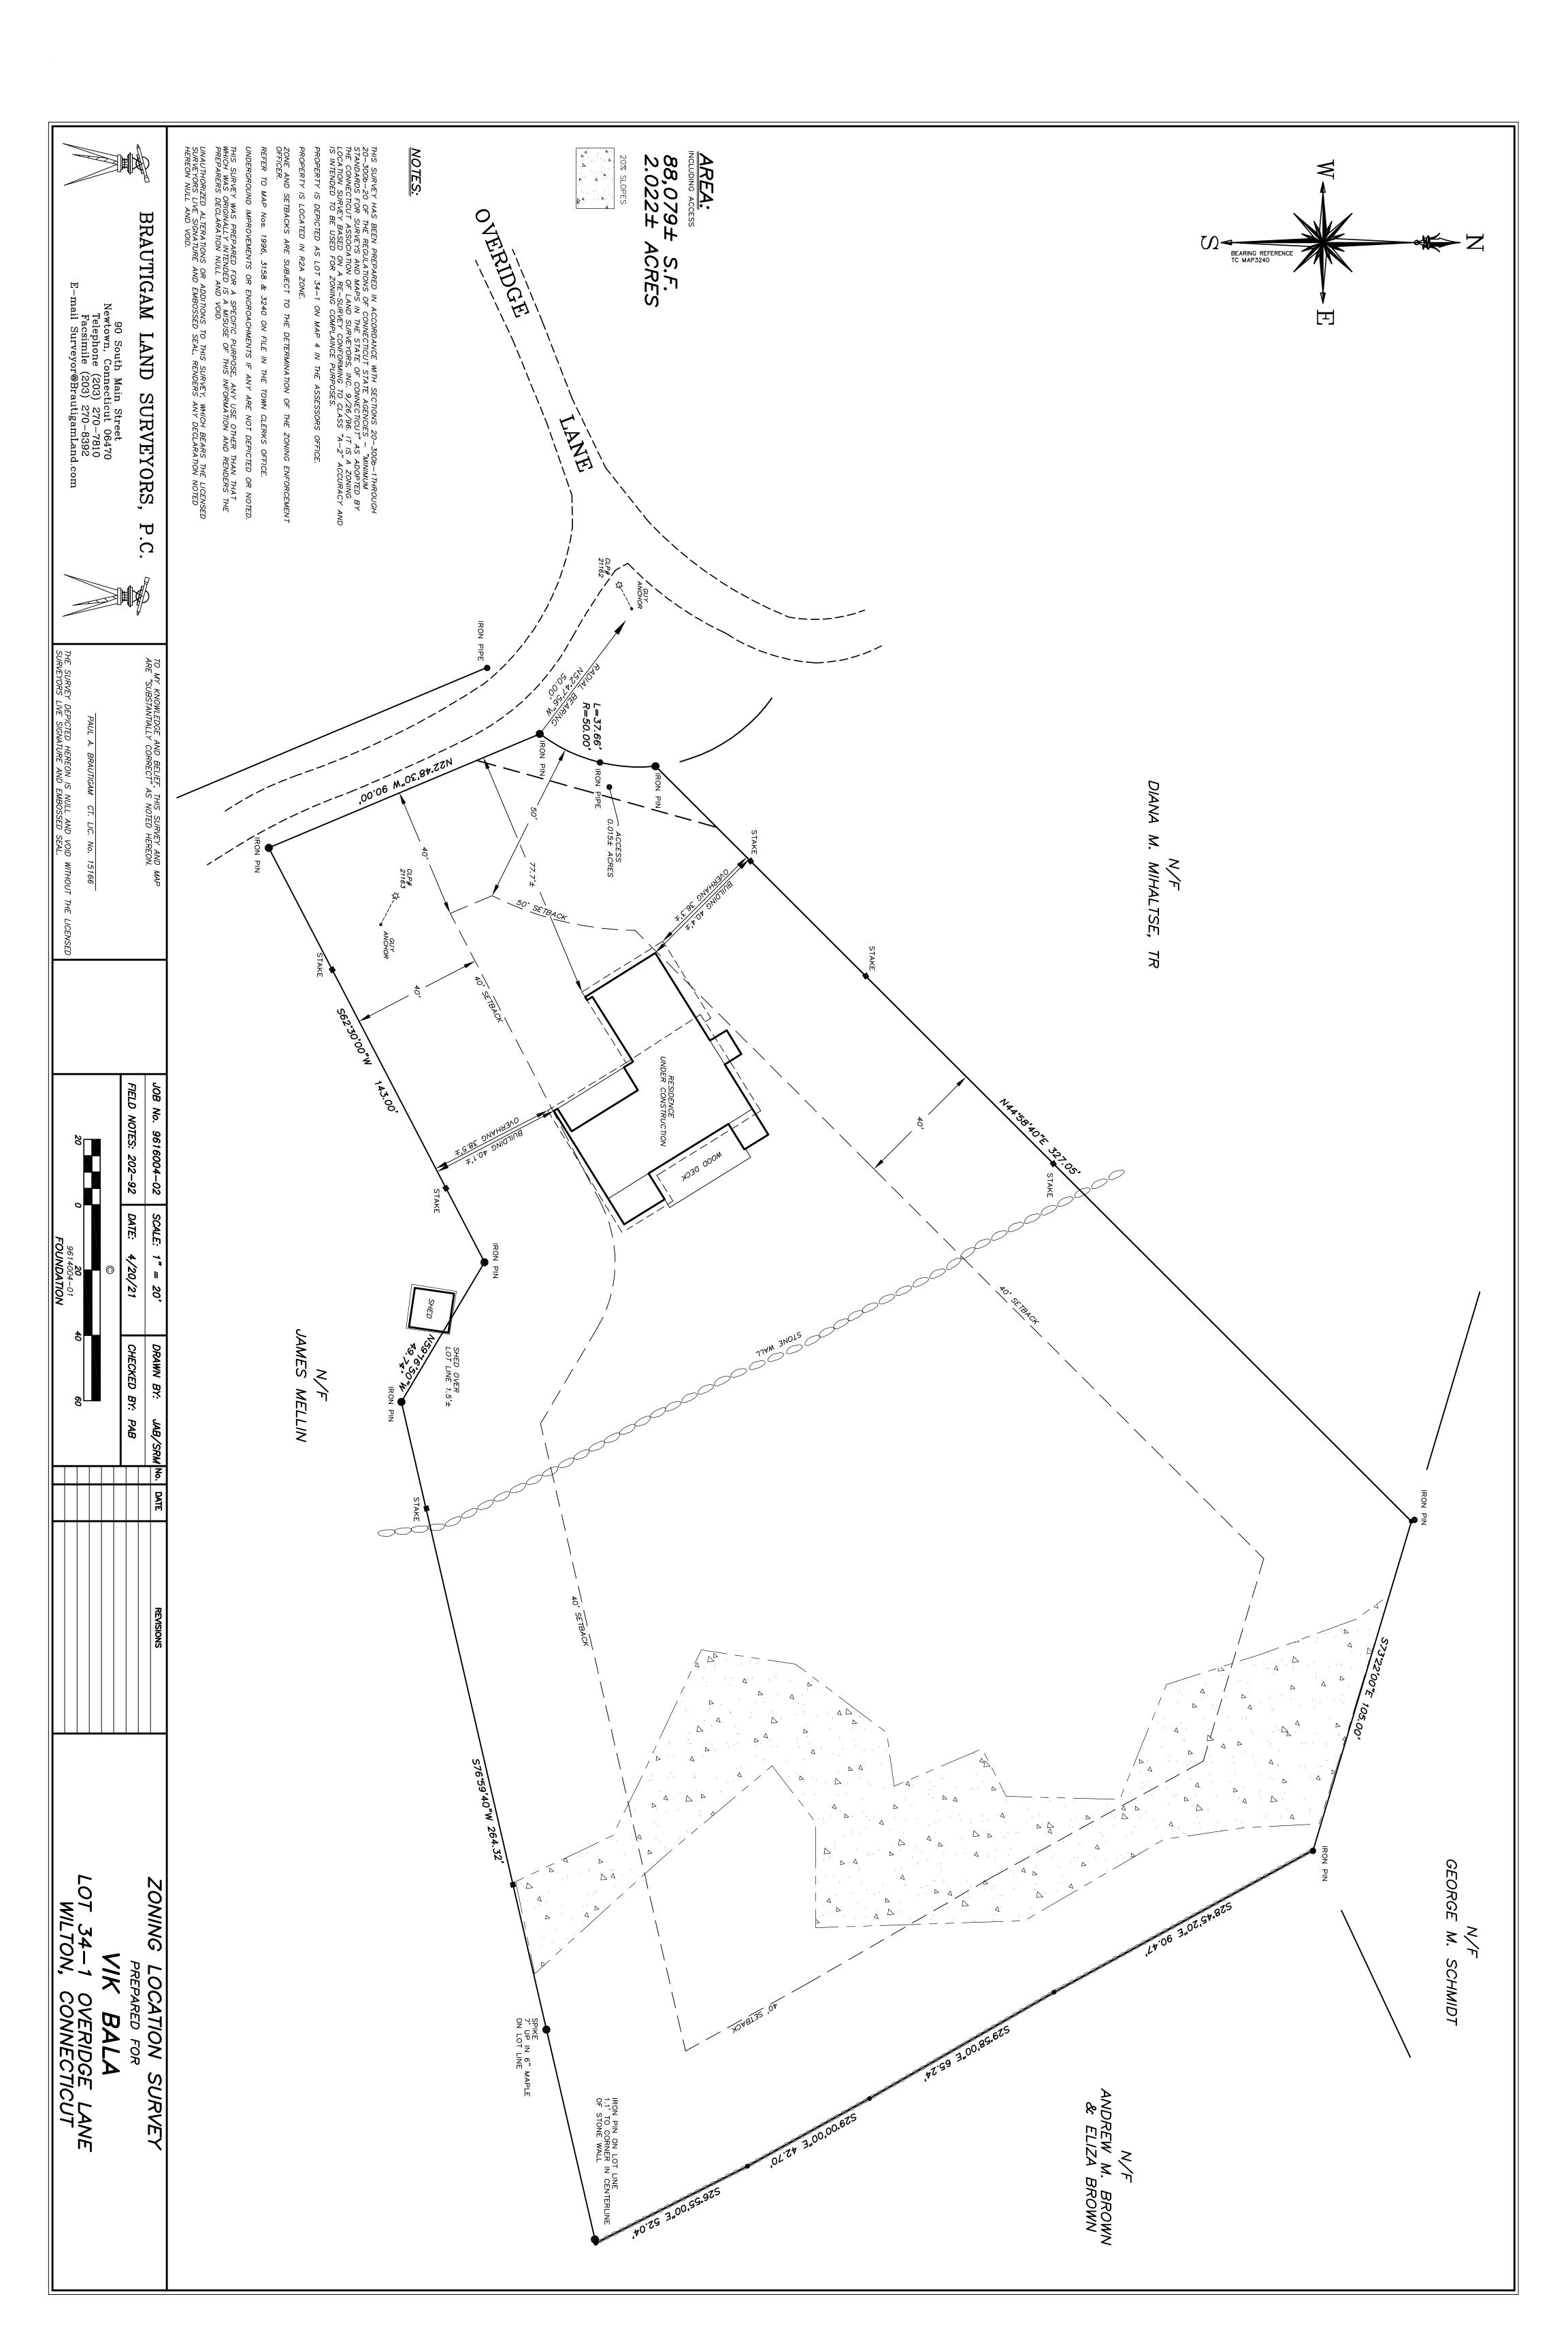


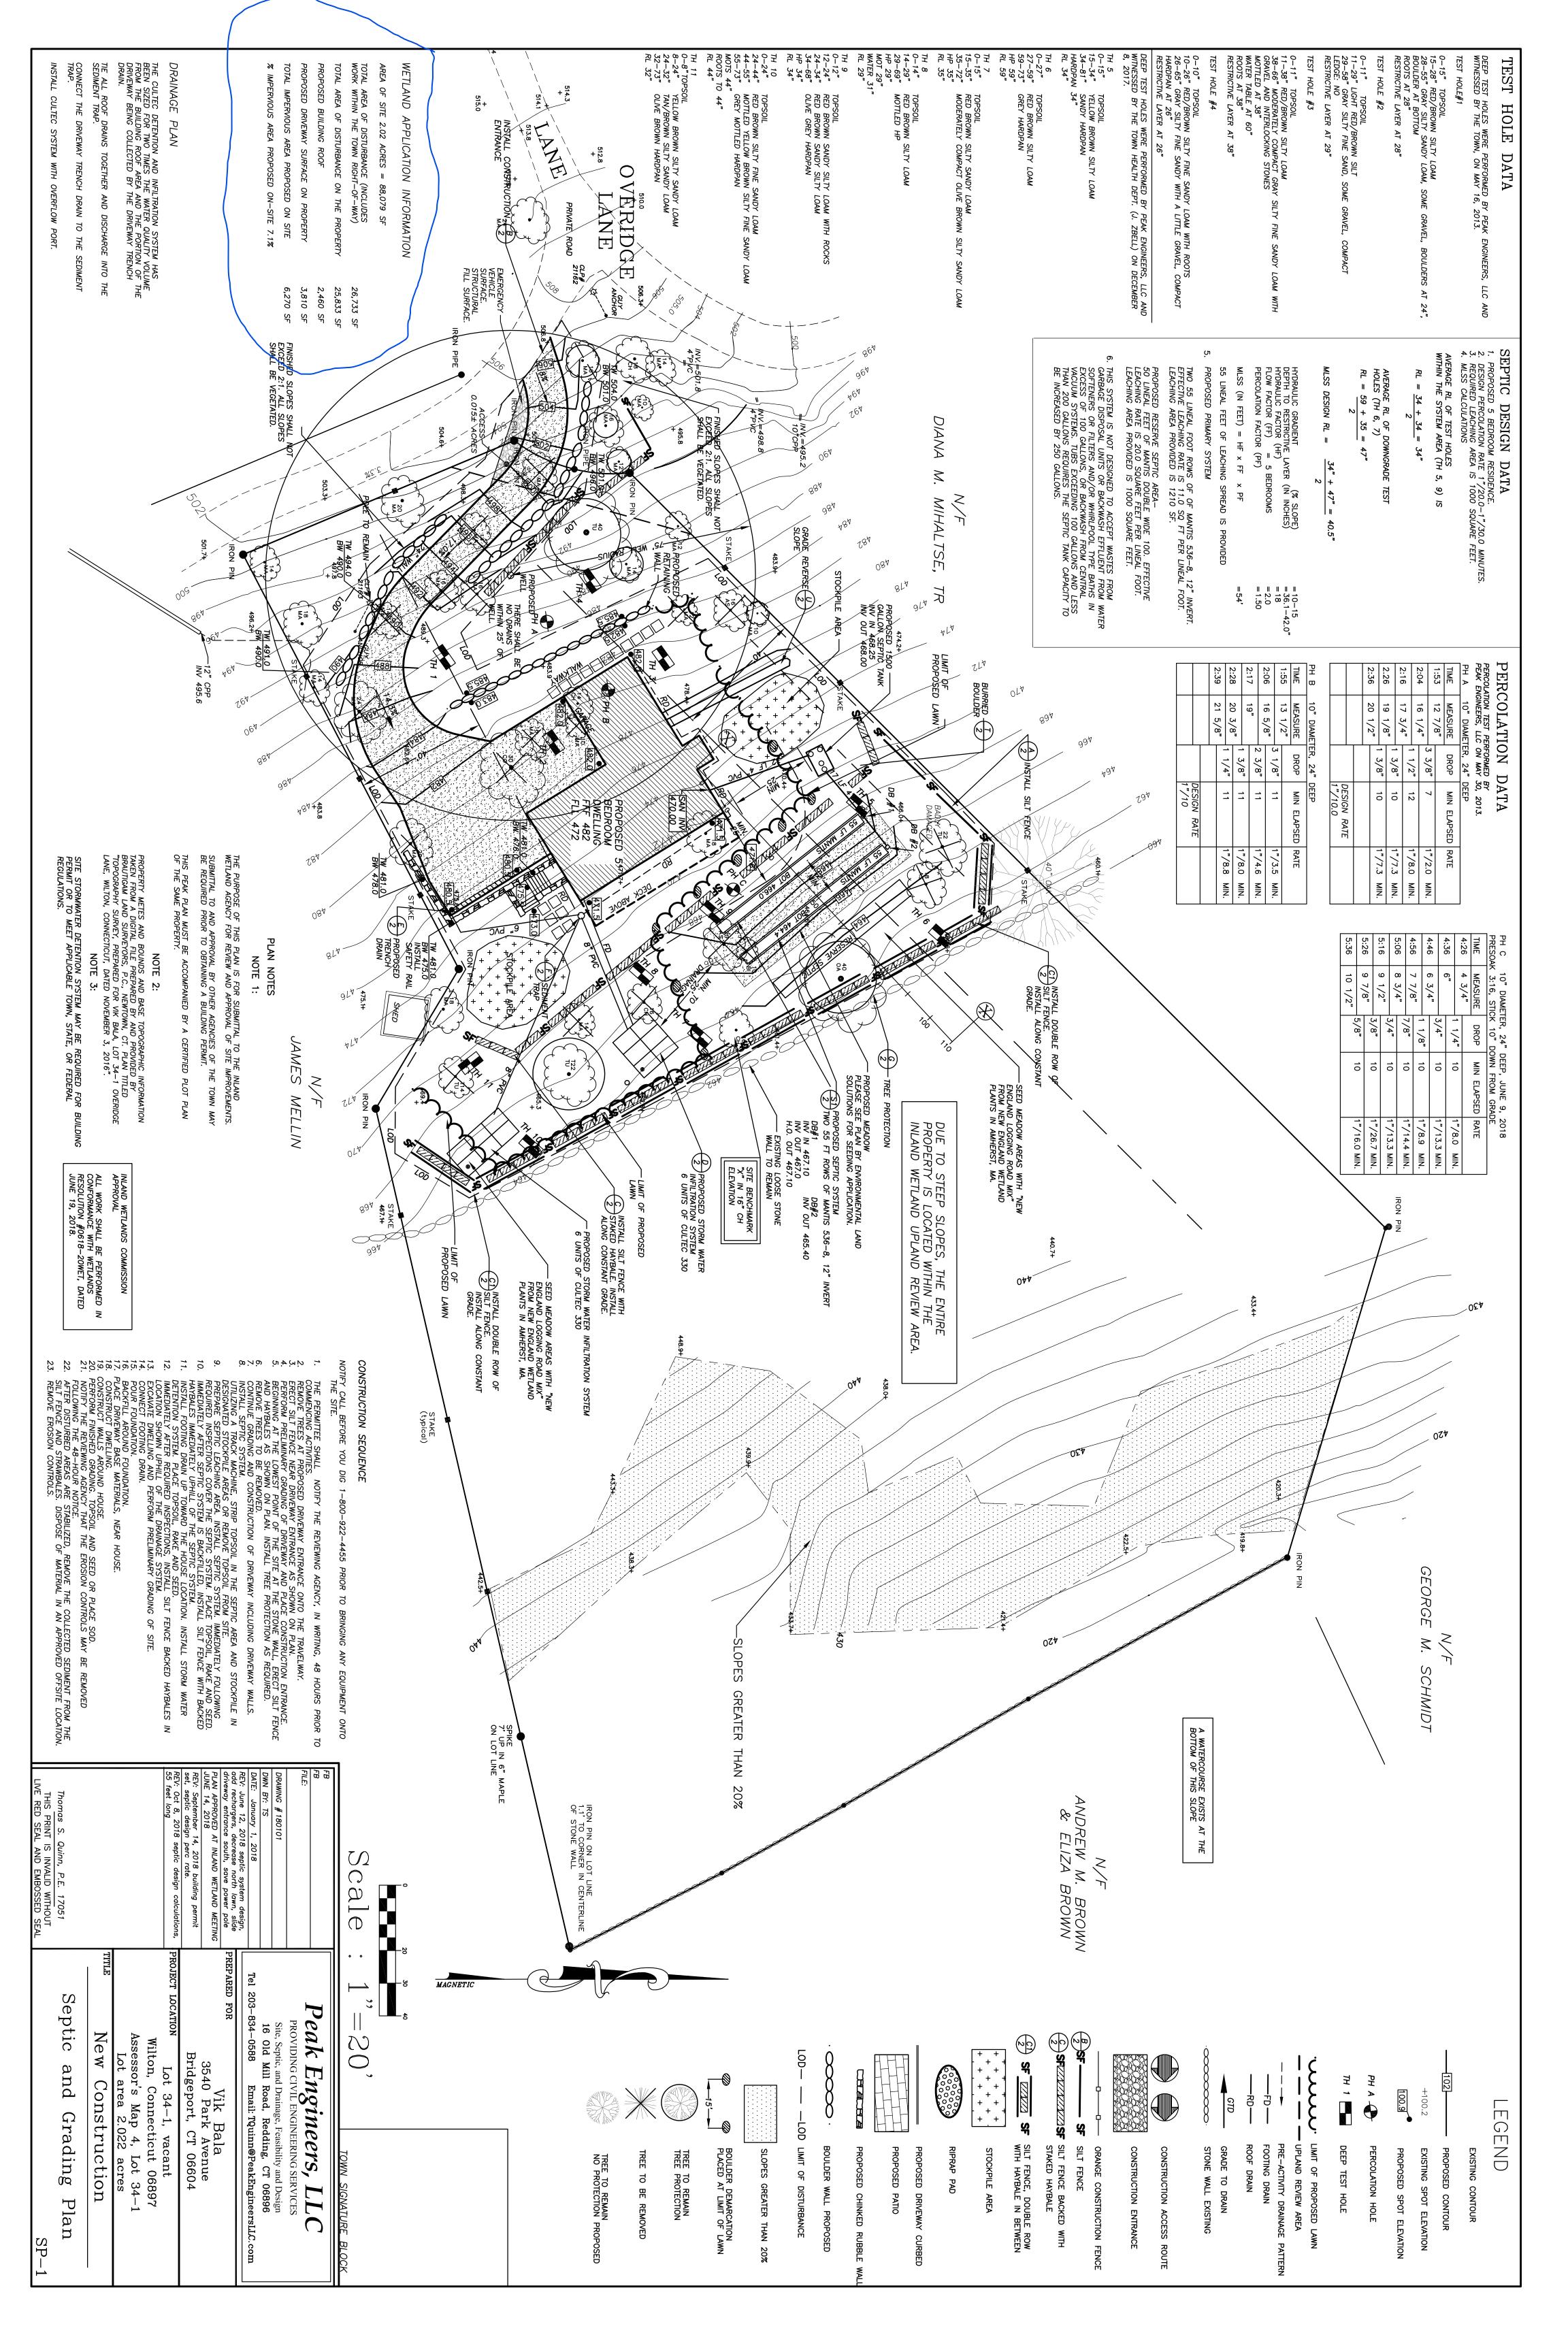

#### Google Maps 25 Overidge Ln

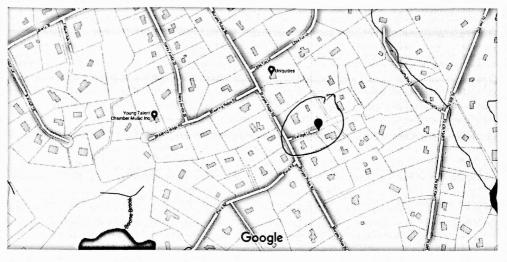

Map data @2021 200 ft \_\_\_\_\_

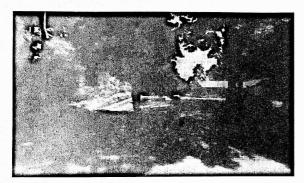

#### 25 Overidge Ln

Wilton, CT 06897












Directions Save Nearby Send 1

Send to your phone

Share

**Photos** 

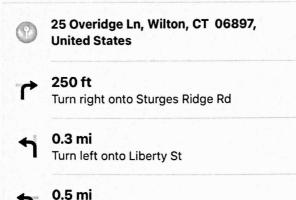

0.3 mi
Turn right onto Sharp Hill Rd

Turn left onto Hurlbutt St


- 1.2 mi
  Turn right onto Danbury Rd
- O.4 mi Turn right
- 50 ft
  Arrive at the destination
- 238 Danbury Rd, Wilton, CT 06897, United States









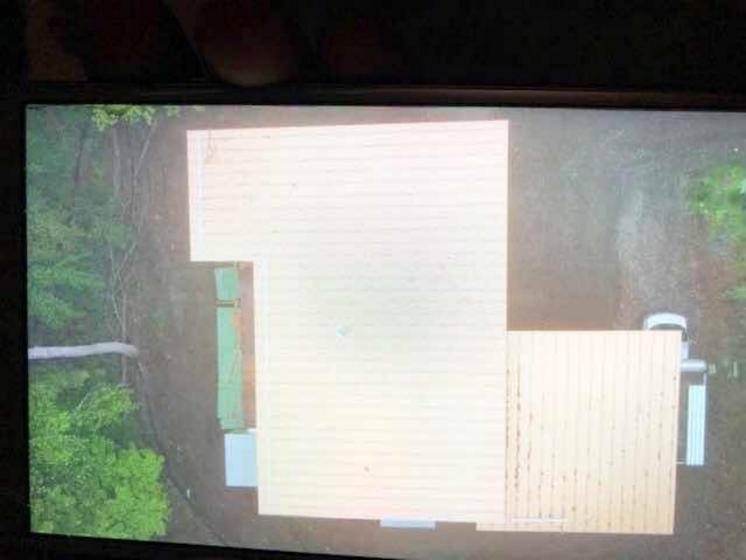

AFTER RECORDING, RETURN TO: McDonough Law Offices, LLC 150 Alexandra Drive Stratford, CT 06614-1034

#### WARRANTY DEED

LESLIE ADLA LAMON, of 28 Mount Pleasant Road in the Town of Newtown, County of Fairfield and the State of Connecticut, for SIXTY THOUSAND and 00/100 DOLLARS (\$60,000.00) consideration paid, grants to VIKENESWARAN BALASUBRAMANIAM and ANNA MARIA A. MALIK, of 3540 Park Avenue in the City of Bridgeport, County of Fairfield, and State of Connecticut, as Joint Tenants with Rights of Survivorship, with WARRANTY COVENANTS the following described premises known as 34-1 Overidge Lane, Wilton, Connecticut:

SEE SCHEDULE "A" ATTACHED HERETO AND MADE APART HEREOF.

Said premises is subject to the following:

Signed this 17/10 of October 2016

- Any and all provisions of any ordinance, municipal regulation, public or private law, including but not limited to the planning and zoning rules and regulations of the Town of Wilton.
- Taxes due the Town of Wilton on the list of October 1, 2015, hereinafter becoming due and payable.
- 3. Encumbrances of record which may appear.

WITNESSED BY:	
Withes John Juzzi, Jr.  Withes John Juzzi, Jr.  Grantor: Leslie Adla Lamon	MO
Witness Dorcen ward	
STATE OF CONNECTICUT	
COUNTY OF FAIRFIELD ) ss: Danbury	

Personally appeared, LESLIE ADLA LAMON, Signer and Sealer of the foregoing instrument, and acknowledged the same to be her free act and deed before me.

Andrew J. Buzzi, Jr. Commissioner of the Superior Court

Conveyance Tax Received TOWN \$ 150.00 STATE \$ 450.00

Lori A. Kaback Town Clerk of Wilton 00141808 VOL: 2459 PG: 444


SCHEDULE A

#### (Legal Description)

ALL THAT CERTAIN premises situated in the Town of Wilton, County of Fairfield, and State of Connecticut, shown as Lot 2, 2.022 acres, more or less on map entitled "Map of Lots 1 & 2 Prepared for Strome B. Lamon & Joan Lamon, Wilton, Connecticut", dated April 4,1973, revised June 14,1973, and recorded in the Wilton Town Clerk's Office as Map No. 3240.


Said premises are also known as Assessor Lot 34-1 Overidge Lane, Wilton, CT 06897

Received For Record Oct 18,2016 AT 02:10P Lori A. Kaback Wilton Town Clerk

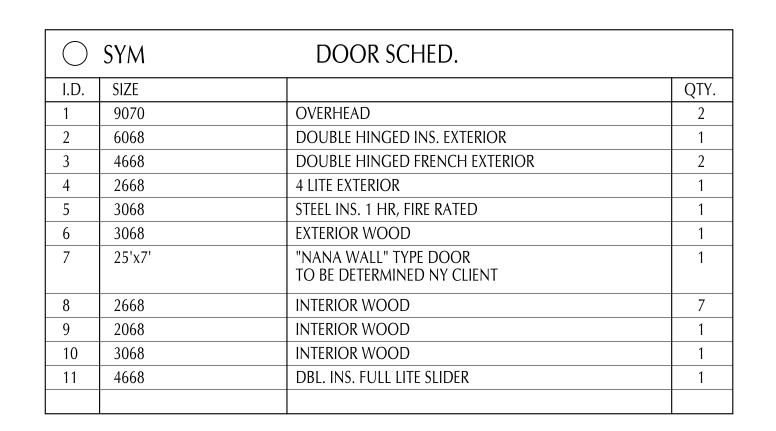

$\bigcirc$	SYM	WINDOW SCHED.	
I.D.	SIZE	ТҮРЕ	QTY.
1	6'-6"x3'-6"	?	1
2	11'-2"x3'-3"	?	1
3	5'-11"x3'-3"	?	4
4	5'-8"x3'-3"	?	1
5	6'-6"x3'-3"	?	2
6	1'-8"x3'-3"	?	1
7	3'-0"x1'-3"	?	4
8	14'-1"x1'-3"	?	1
9	10'-6"x1'-7"	?	1
10	14'-5"x3'-7"	?	1
11	3'-0"x1'-3"	TEMPERED	1
12	1'-7"x8'-10"	?	3
13	6'-10"x6'-6"	?	1
14	5'-7"x1'-4"	?	1
15	3'-7"x4'-11"	?	1
16	11'-2"x6'-2"	?	Ś
17	7'-6"x6'-6"	?	2
18	3'-7"x3'-3"	?	1
19	2'-3"x3'-7"	?	1
20	10'6"x3'-7"	?	1

ALL WINDOWS TO BE LOW "E" ARGON GAS FILLED WITH A "U" FACTOR OF NOT LESS THAN 0.29, INSULATED WITH THERMAL-BREAK FRAMES. ALL WINDOWS SHALL BE EXTERIOR CLAD. SUPPLY SCREENS AS REQUIRED. PROVIDE TEMPERED GLASS WINDOWS AT ALL DOORS, STAIRS, AND TUB/SHOWER LOCATIONS. PROVIDE EGRESS WINDOWS AT ALL BEDROOM LOCATIONS. THIS IS A PRELIMINARY WINDOW SCHEDULE. AEDIFEX, LLC OR ANY OF IT'S EMPLOYEES, OWNERS, ETC. DOES NOT TAKE ANY RESPONSIBILITY FOR SIZES, LOCATIONS, FRAMES, ETC. UNTIL ACCURATE DETAILS HAVE BEEN SUBMITTED FOR REVIEW. VERIFICATION OF EXACT WINDOW SIZES, ROUGH OPENINGS, ETC. RESTS SOLELY WITH THE GENERAL CONTRCTOR AND/OR SKY VIEW BUILDERS.

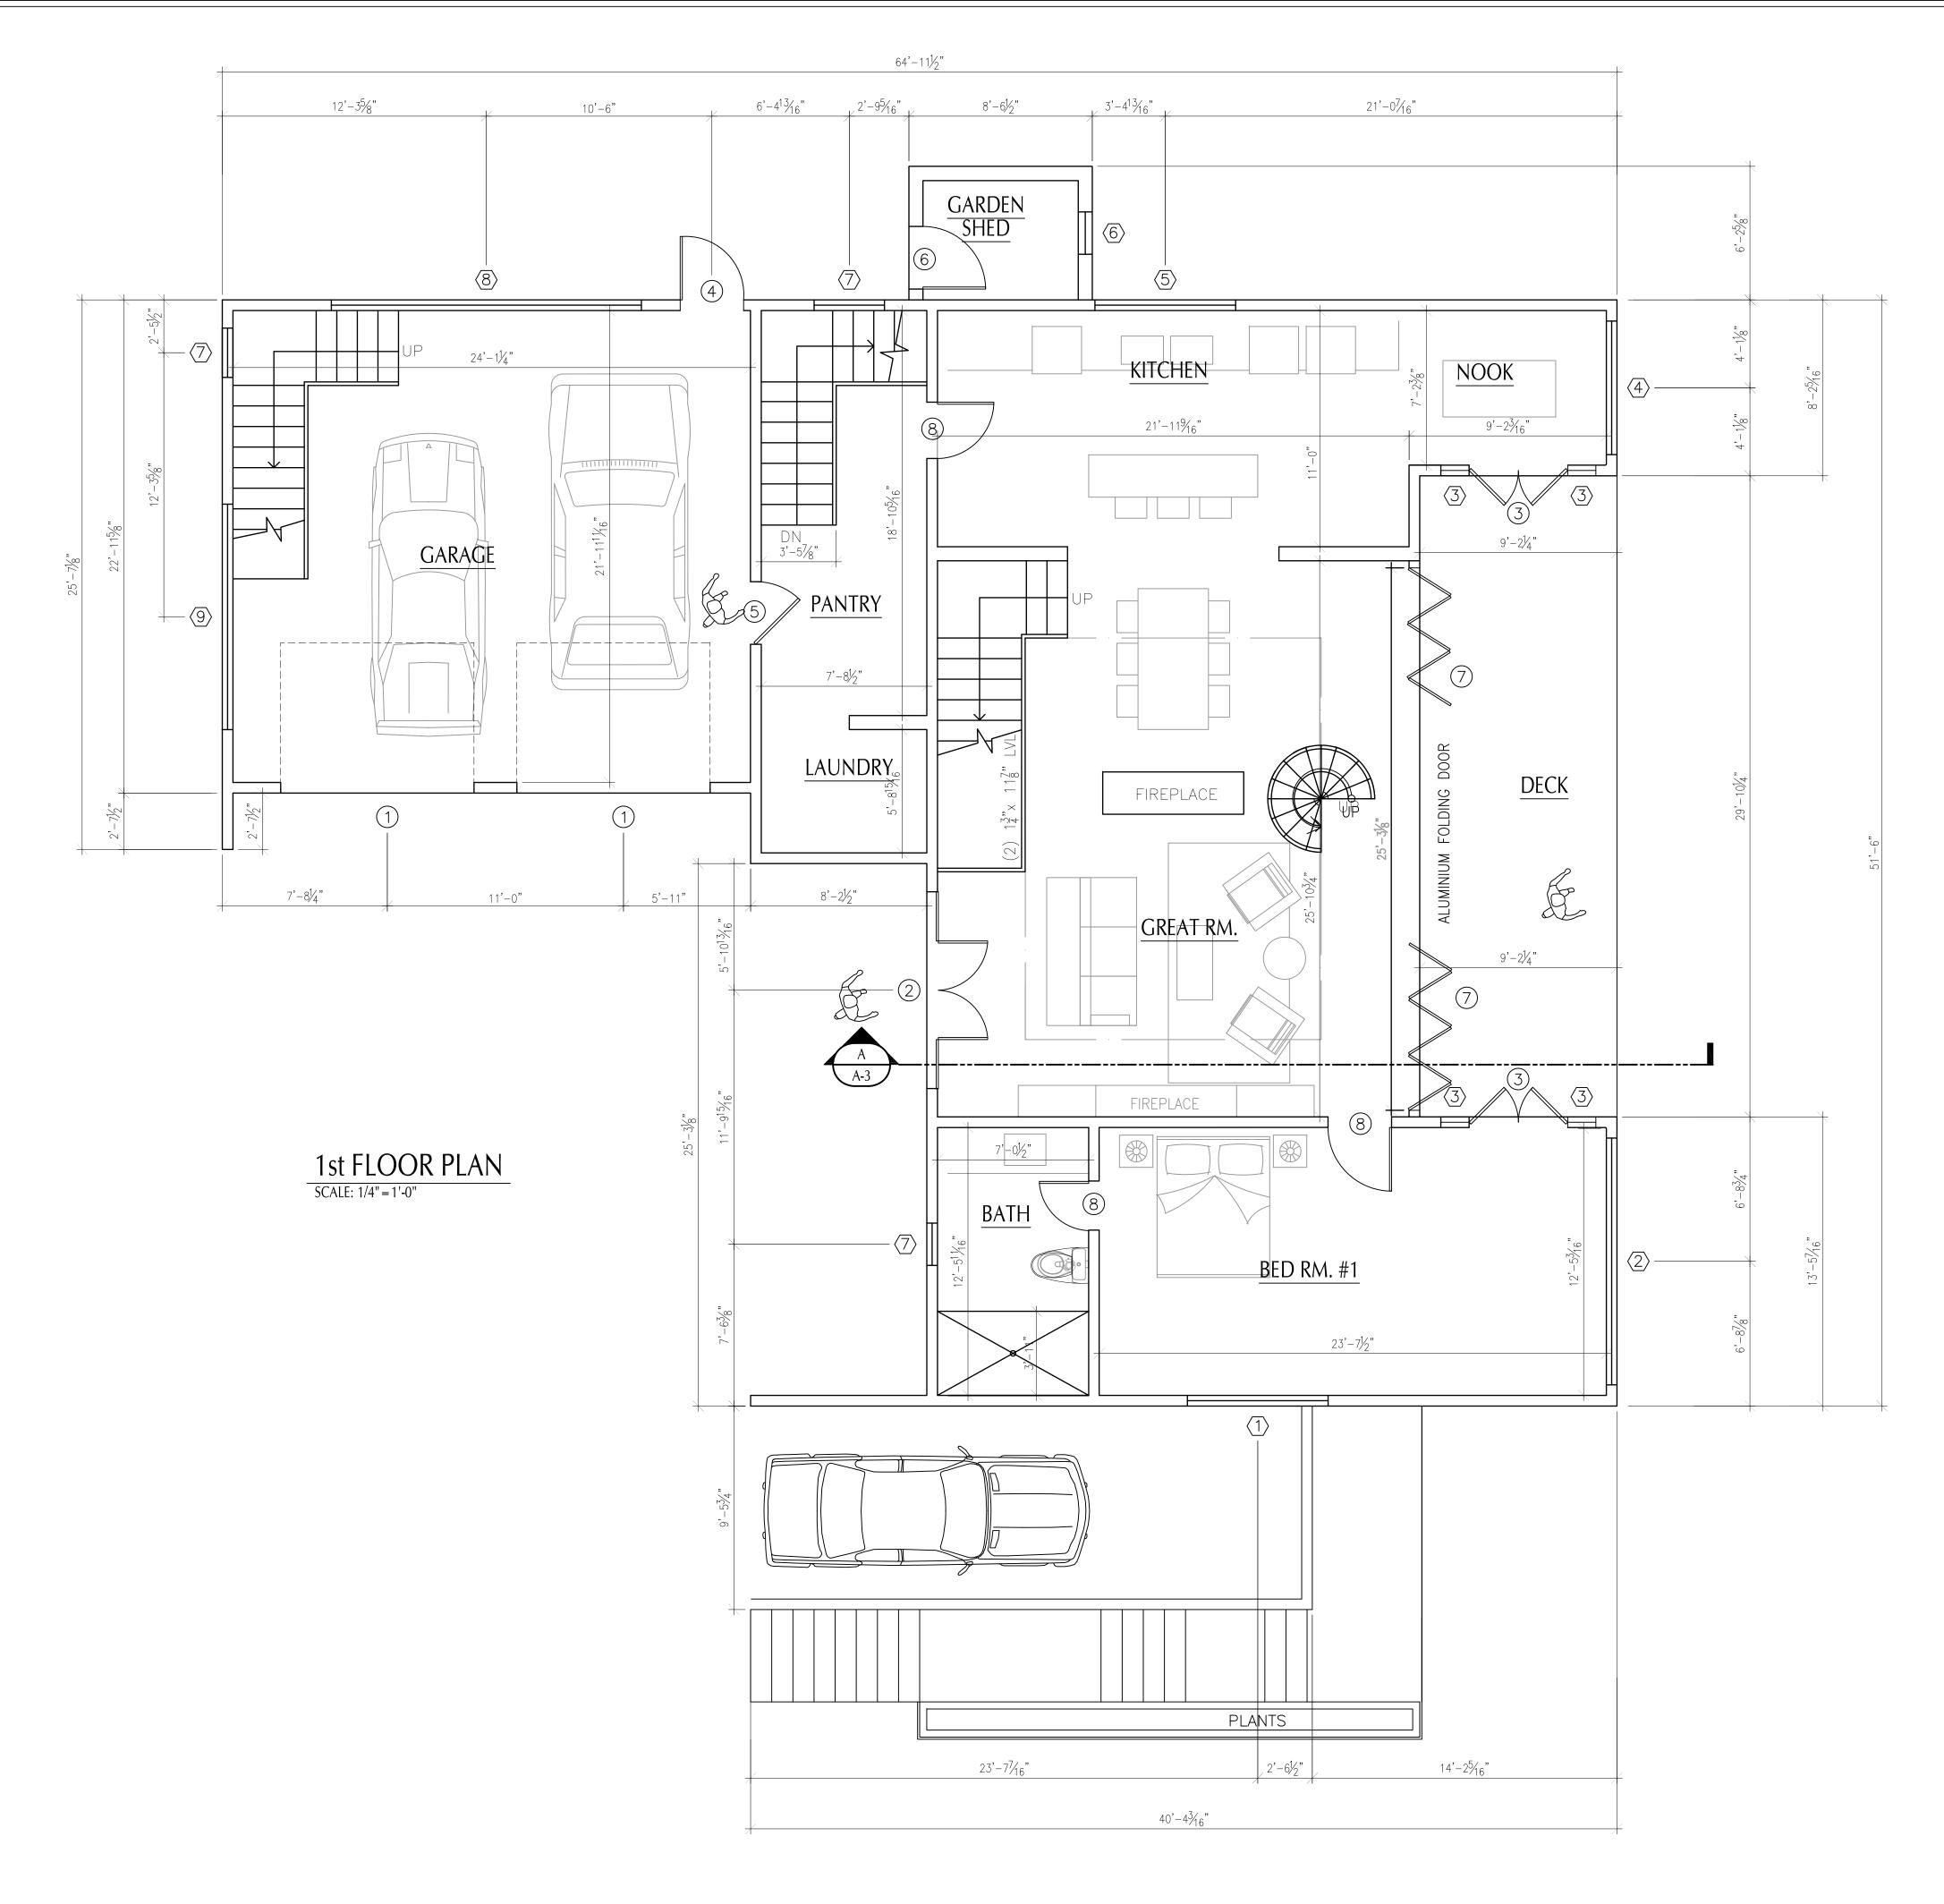

THIS DRAWING IS THE PROPERTY OF THE ENGINEER. IT HAS BEEN SPECIFICALLY PREPARED FOR THE OWNER FOR THIS PROJECT AT THIS SITE AND IS NOT TO BE USED FOR ANY OTHER PURPOSE, LOCATION OR OWNER WITHOUT WRITTEN CONSENT OF THE ENGINEER.

Atlantic Consulting & Inc

525 John Street
Bridgeport, Connecticut
06604-3926
(203) 336-4422
(203) 336-1769 FAX

info@atlantic-eng.com

TWO STORY SINGLE FAMILY DWELLING BALASUBRAMANI RESIDENCE 34-1 OVERIDGE LANE WILTON, CT

Job Number: 18-3456

Start Date: 8/10/18

Issued For:	Date:
APPROVAL	8/XX/3 8
PERMIT	x8x1x6x1x8x

REVISION	Date:
DIMENSIONED FOUND. PLAN	10/29/18
COORDINATED DIMS. BETWEEN FLOOR PLANS	

Drawn By: Checked By: TJP JEQ



Sheet Title:

1st FLOOR PLAN


Scale: AS NOTED

Sheet Number:

○ SYM		DOOR SCHED.	
I.D.	SIZE		QTY.
1	9070	OVERHEAD	2
2	6068	DOUBLE HINGED INS. EXTERIOR	1
3	4668	DOUBLE HINGED FRENCH EXTERIOR	2
4	2668	4 LITE EXTERIOR	1
5	3068	STEEL INS. 1 HR, FIRE RATED	1
6	3068	EXTERIOR WOOD	1
7	25'x7'	"NANA WALL" TYPE DOOR TO BE DETERMINED NY CLIENT	1
8	2668	INTERIOR WOOD	7
9	2068	INTERIOR WOOD	1
10	3068	INTERIOR WOOD	1
11	4668	DBL. INS. FULL LITE SLIDER	1

$\bigcirc$	SYM	WINDOW SCHED.	
I.D.	SIZE	ТҮРЕ	QTY.
1	6'-6"x3'-6"	?	1
2	11'-2"x3'-3"	?	1
3	5'-11"x3'-3"	?	4
4	5'-8"x3'-3"	?	1
5	6'-6"x3'-3"	?	2
6	1'-8"x3'-3"	?	1
7	3'-0"x1'-3"	?	4
8	14'-1"x1'-3"	?	1
9	10'-6"x1'-7"	?	1
10	14'-5"x3'-7"	?	1
11	3'-0"x1'-3"	TEMPERED	1
12	1'-7"x8'-10"	?	3
13	6'-10"x6'-6"	?	1
14	5'-7"x1'-4"	?	1
15	3'-7"x4'-11"	?	1
16	11'-2"x6'-2"	?	Ş
17	7'-6"x6'-6"	?	2
18	3'-7"x3'-3"	?	1
19	2'-3"x3'-7"	?	1
20	10'6"x3'-7"	?	1

ALL WINDOWS TO BE LOW "E" ARGON GAS FILLED WITH A "U" FACTOR OF NOT LESS THAN 0.29, INSULATED WITH THERMAL-BREAK FRAMES. ALL WINDOWS SHALL BE EXTERIOR CLAD. SUPPLY SCREENS AS REQUIRED. PROVIDE TEMPERED GLASS WINDOWS AT ALL DOORS, STAIRS, AND TUB/SHOWER LOCATIONS. PROVIDE EGRESS WINDOWS AT ALL BEDROOM LOCATIONS. THIS IS A PRELIMINARY WINDOW SCHEDULE. AEDIFEX, LLC OR ANY OF IT'S EMPLOYEES, OWNERS, ETC. DOES NOT TAKE ANY RESPONSIBILITY FOR SIZES, LOCATIONS, FRAMES, ETC. UNTIL ACCURATE DETAILS HAVE BEEN SUBMITTED FOR REVIEW. VERIFICATION OF EXACT WINDOW SIZES, ROUGH OPENINGS, ETC. RESTS SOLELY WITH THE GENERAL CONTRCTOR AND/OR SKY VIEW BUILDERS.

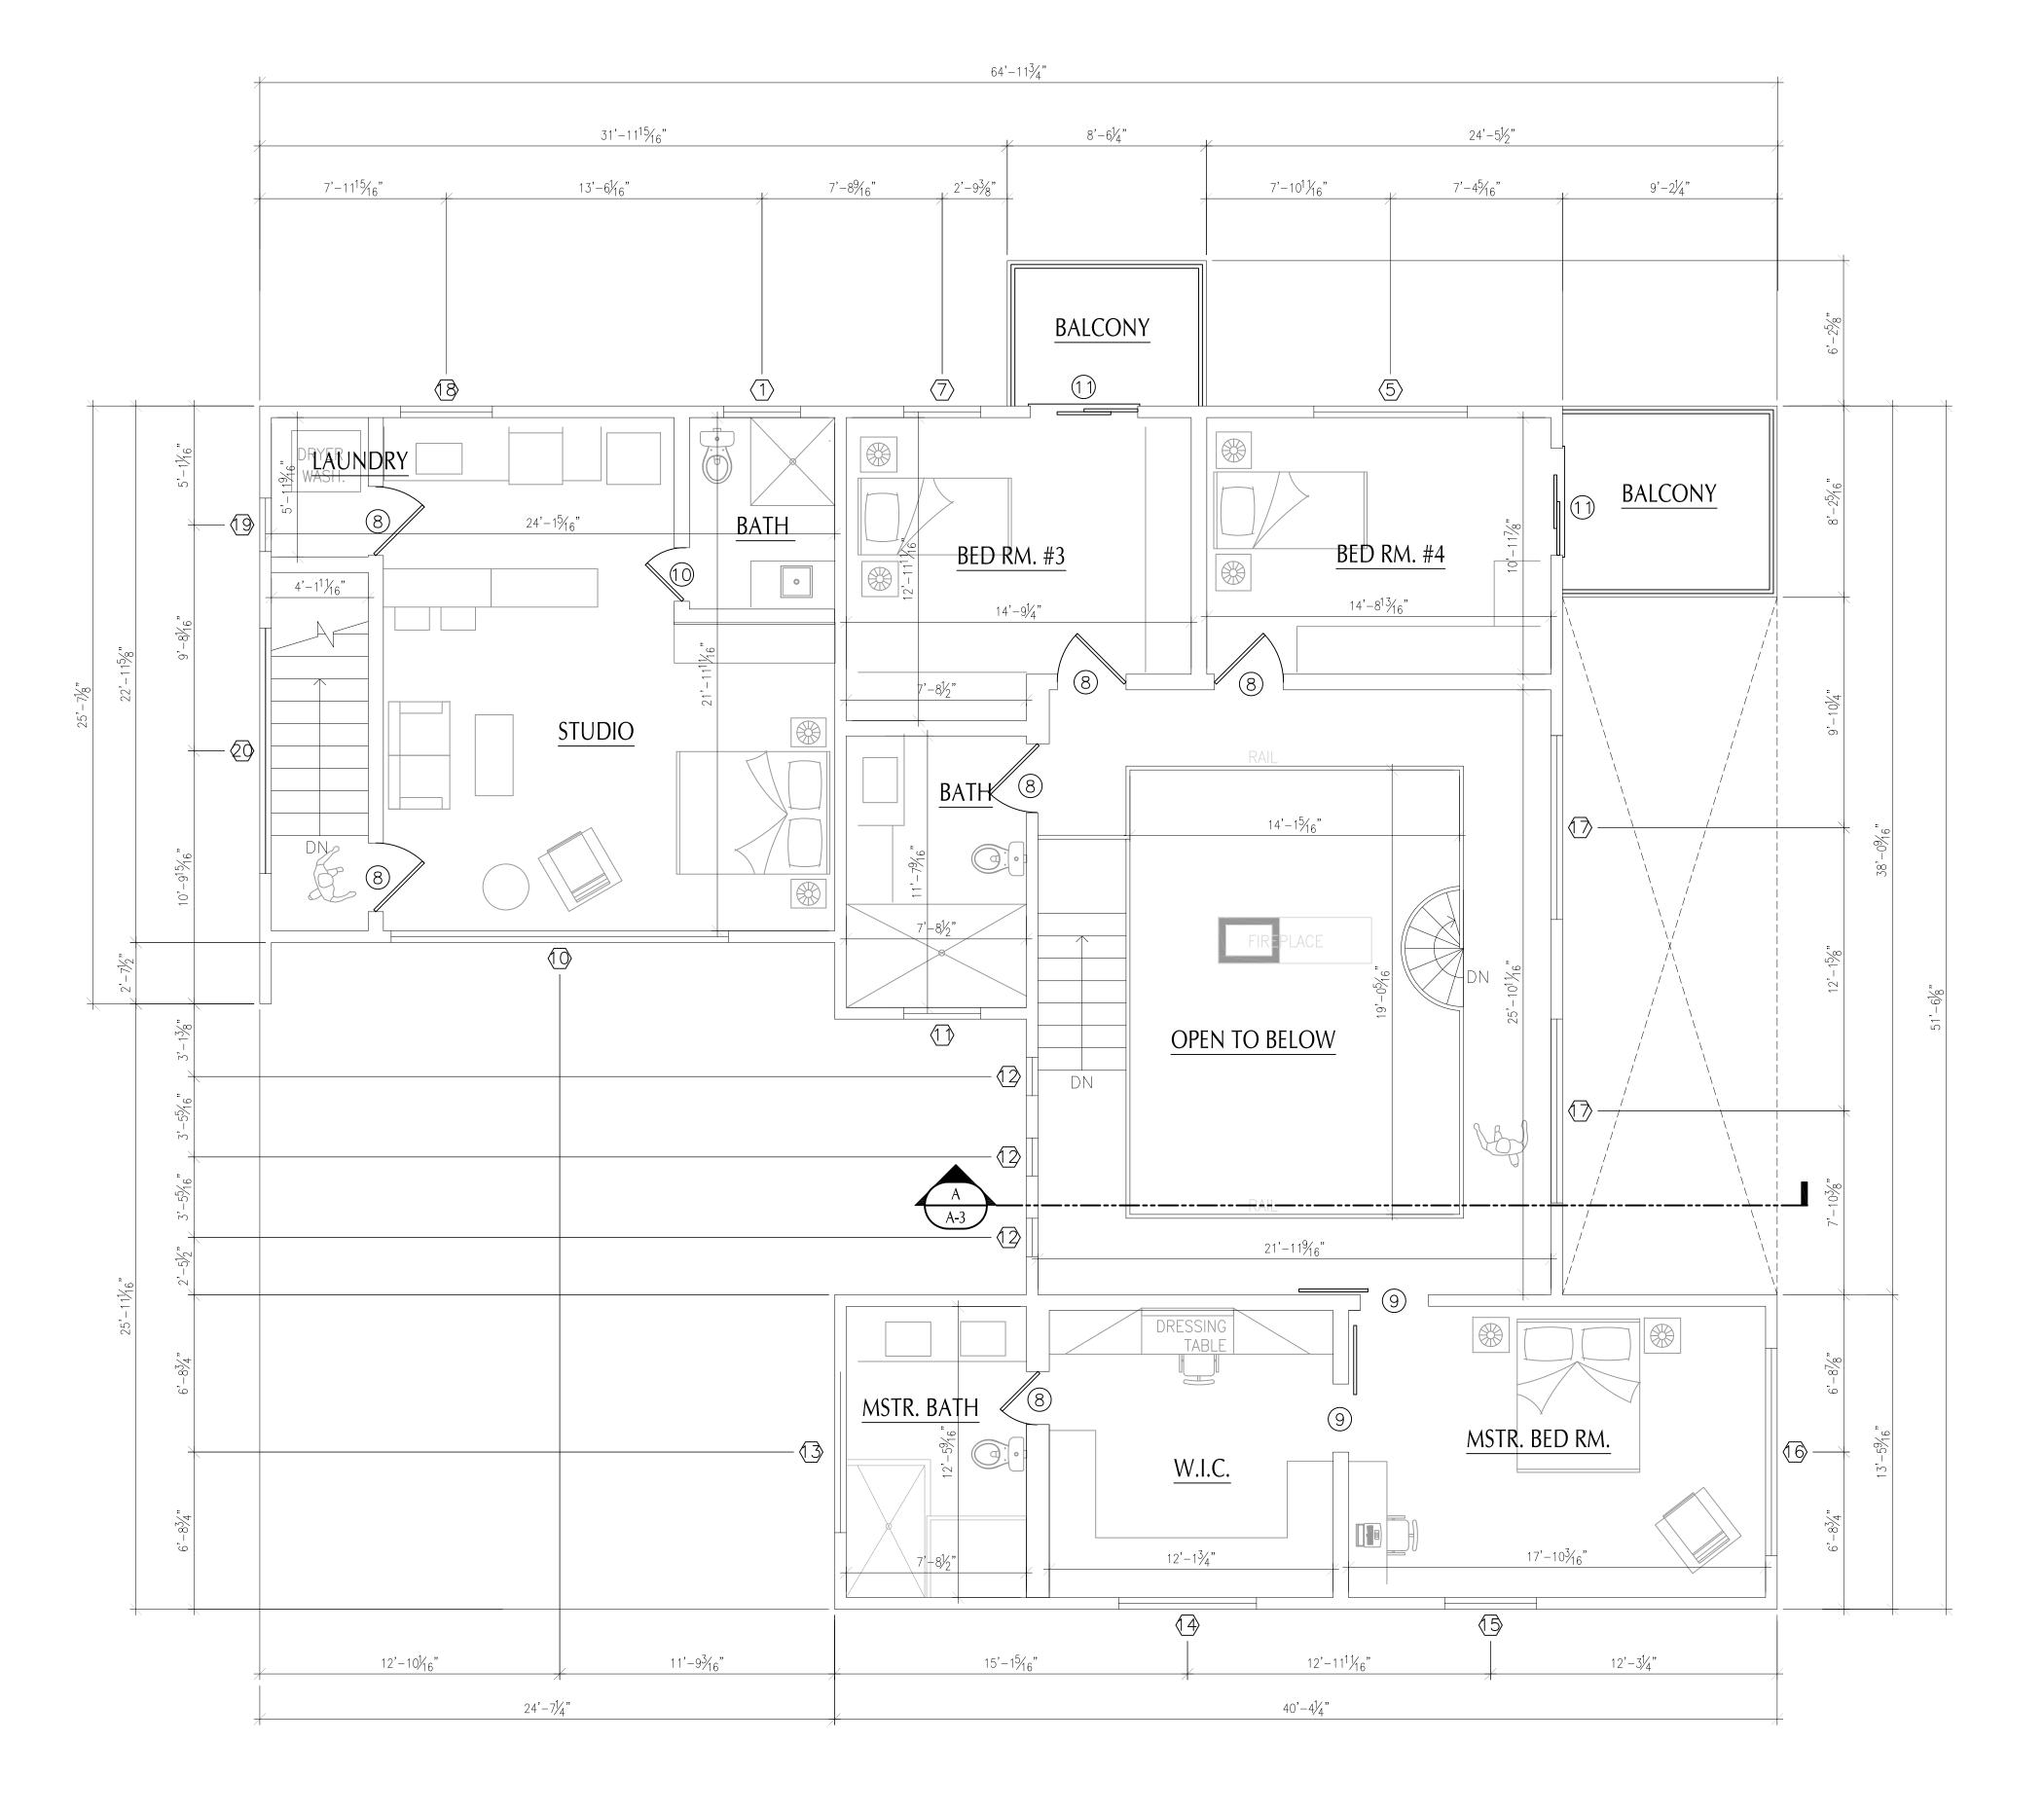

2nd FLOOR PLAN
SCALE: 1/4" = 1'-0"

THIS DRAWING IS THE PROPERTY OF THE ENGINEER. IT HAS BEEN SPECIFICALLY PREPARED FOR THE OWNER FOR THIS PROJECT AT THIS SITE AND IS NOT TO BE USED FOR ANY OTHER PURPOSE, LOCATION OR OWNER WITHOUT WRITTEN CONSENT OF THE ENGINEER.



TWO STORY SINGLE FAMILY DWELLING BALASUBRAMANI RESIDENCE 34-1 OVERIDGE LANE WILTON, CT


Job Number: 18-3456

Start Date: 8/10/18

Γ.		
	Issued For:	Date:
	APPROVAL	8/15/18
	PERMIT	8/16/18

REVISION	Date:
DIMENSIONED FOUND. PLAN	10/29/18
COORDINATED DIMS. BETWEEN FLOOR PLANS	

Drawn By: Checked By:
TJP JEQ

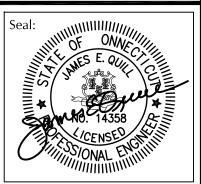


Sheet Title:

2nd FLOOR PLAN

Scale: AS NOTED

Sheet Number:

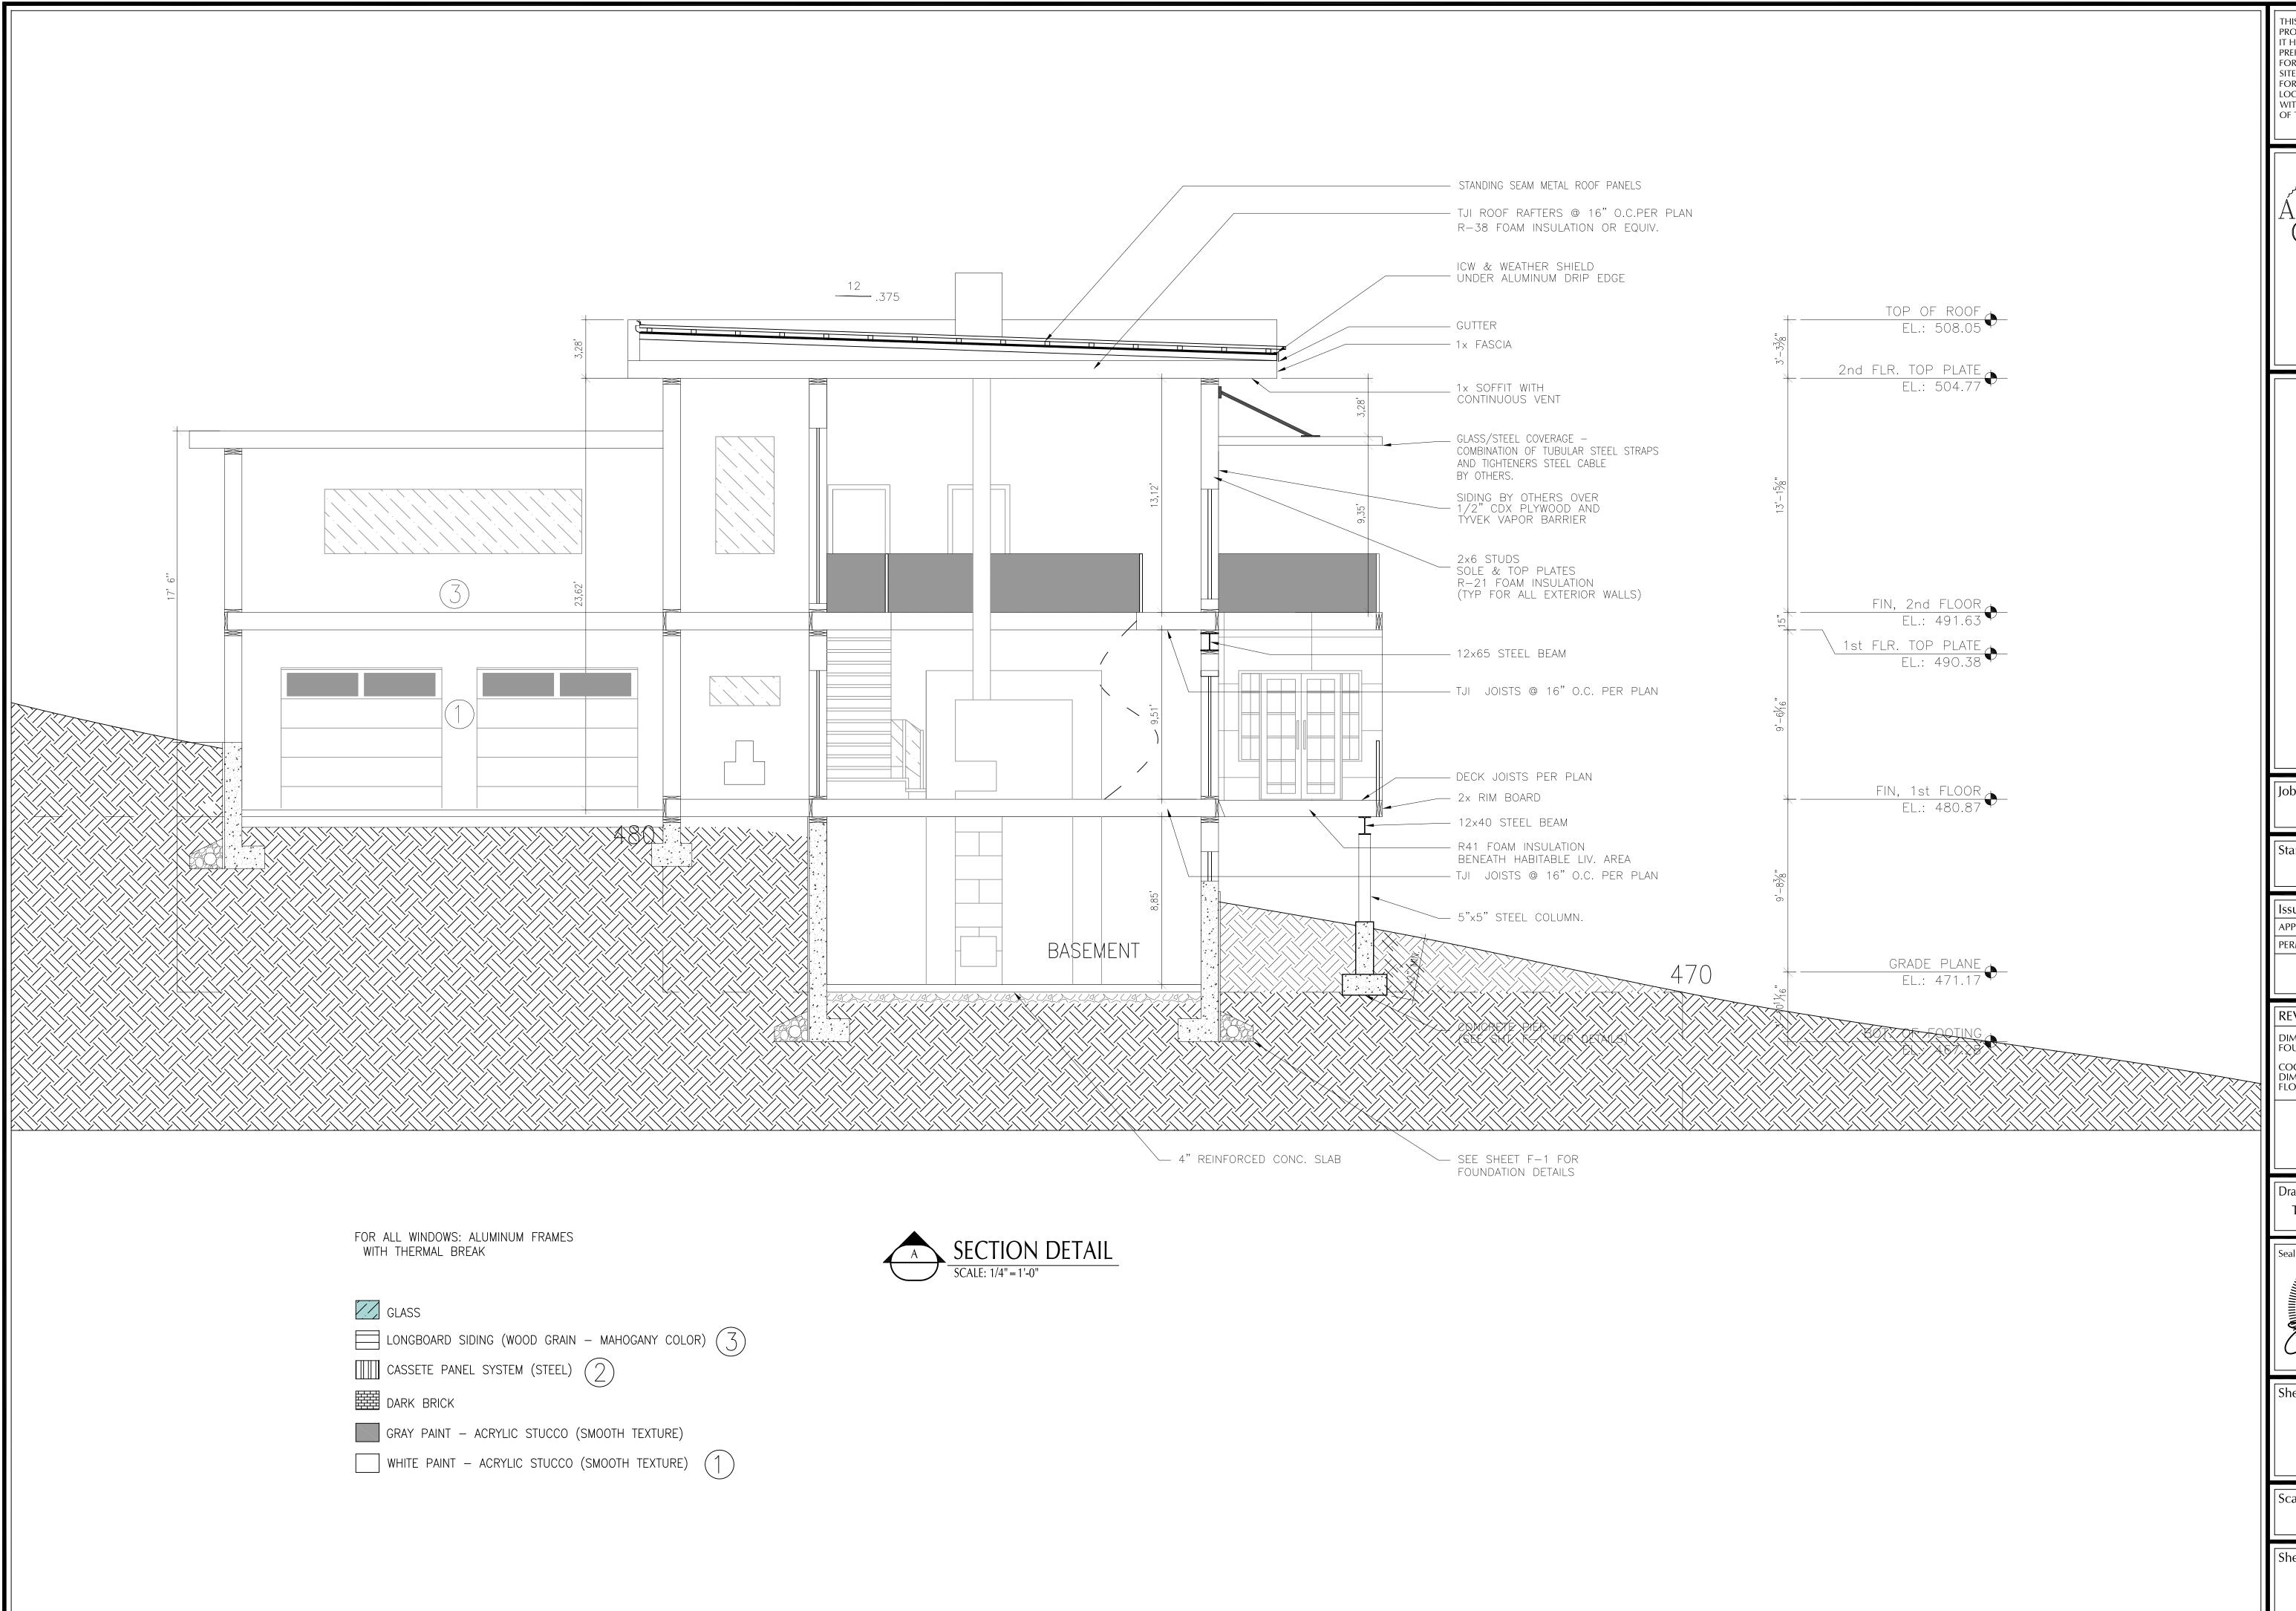

THIS DRAWING IS THE PROPERTY OF THE ENGINEER. IT HAS BEEN SPECIFICALLY PREPARED FOR THE OWNER FOR THIS PROJECT AT THIS SITE AND IS NOT TO BE USED FOR ANY OTHER PURPOSE, LOCATION OR OWNER WITHOUT WRITTEN CONSENT OF THE ENGINEER.

> TWO STORY SINGLE FAMILY DWELLING BALASUBRAMANI RESIDENCE 34-1 OVERIDGE LANE WILTON, CT


Job Number: 18-3456

Start Date: 8/10/18

- 1			
		Issued For:	Date:
	ı	APPROVAL	8/15/18
	ı	PERMIT	8/16/18
	l		

REVISION	Date:
DIMENSIONED FOUND. PLAN	10/29/18
COORDINATED DIMS. BETWEEN FLOOR PLANS	

Drawn By: Checked By: TJP JEQ

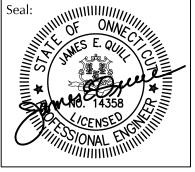



Sheet Title:

SECTION DETAILS

Scale:
AS NOTED

Sheet Number: A-3

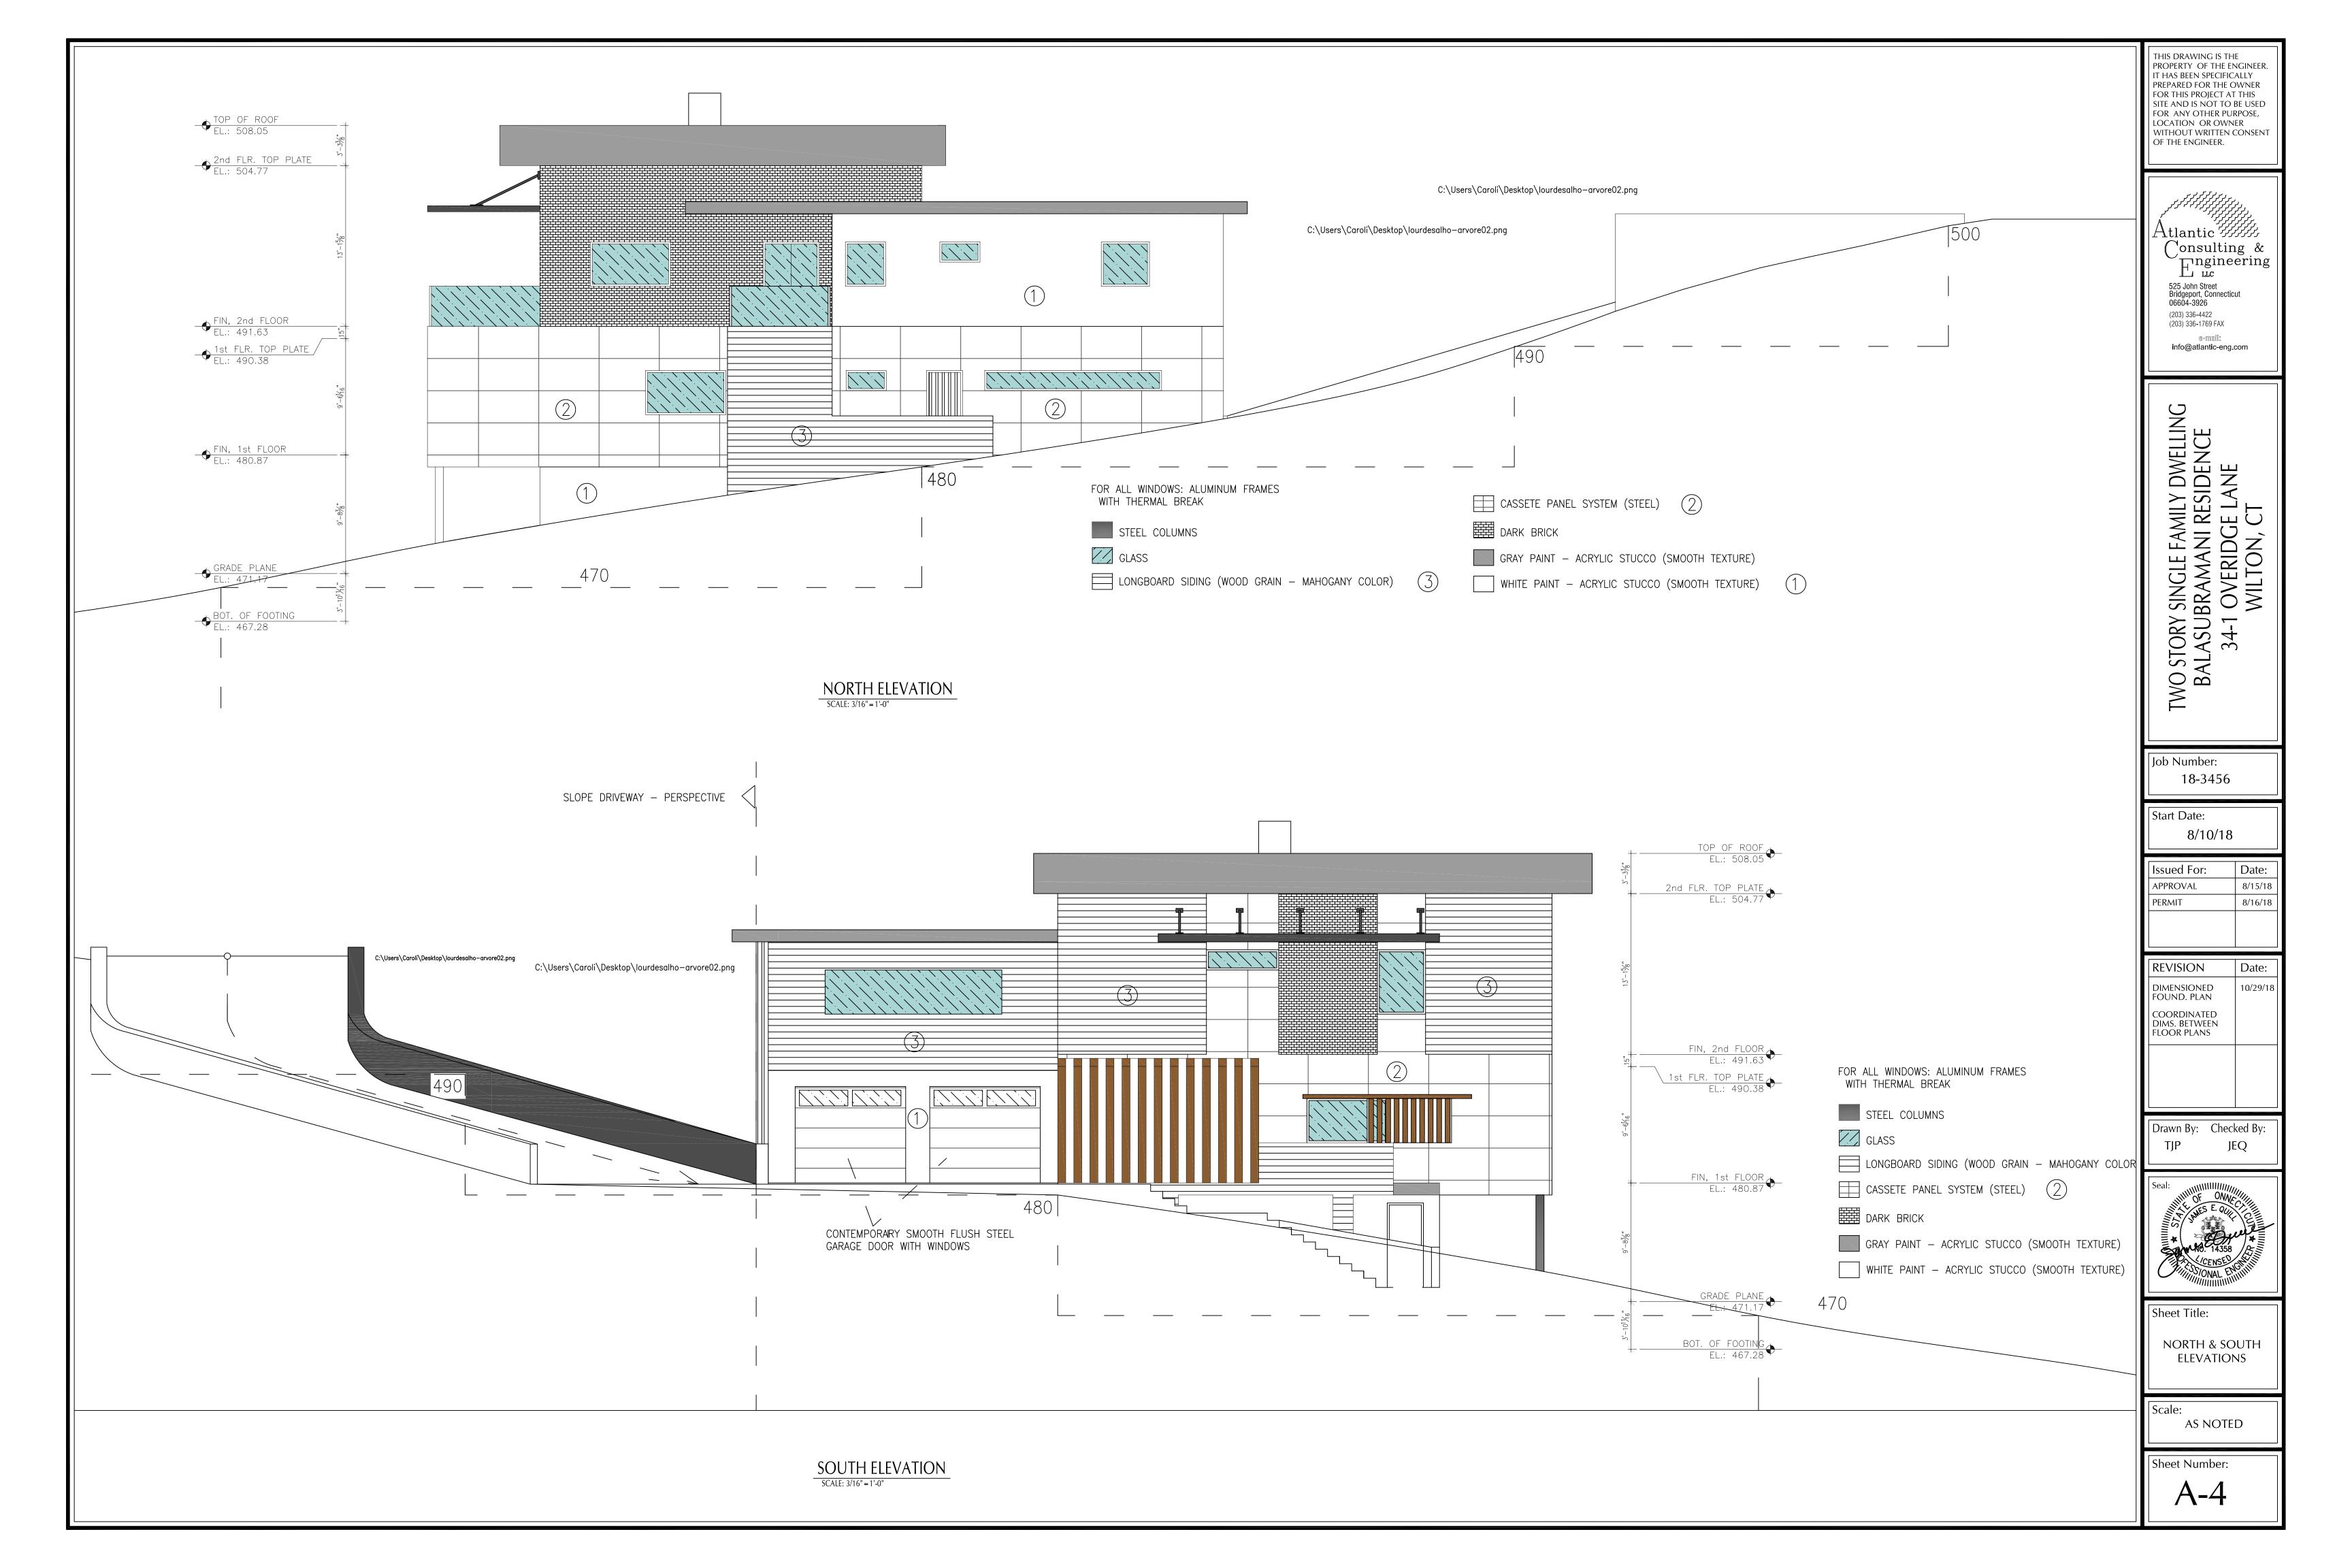

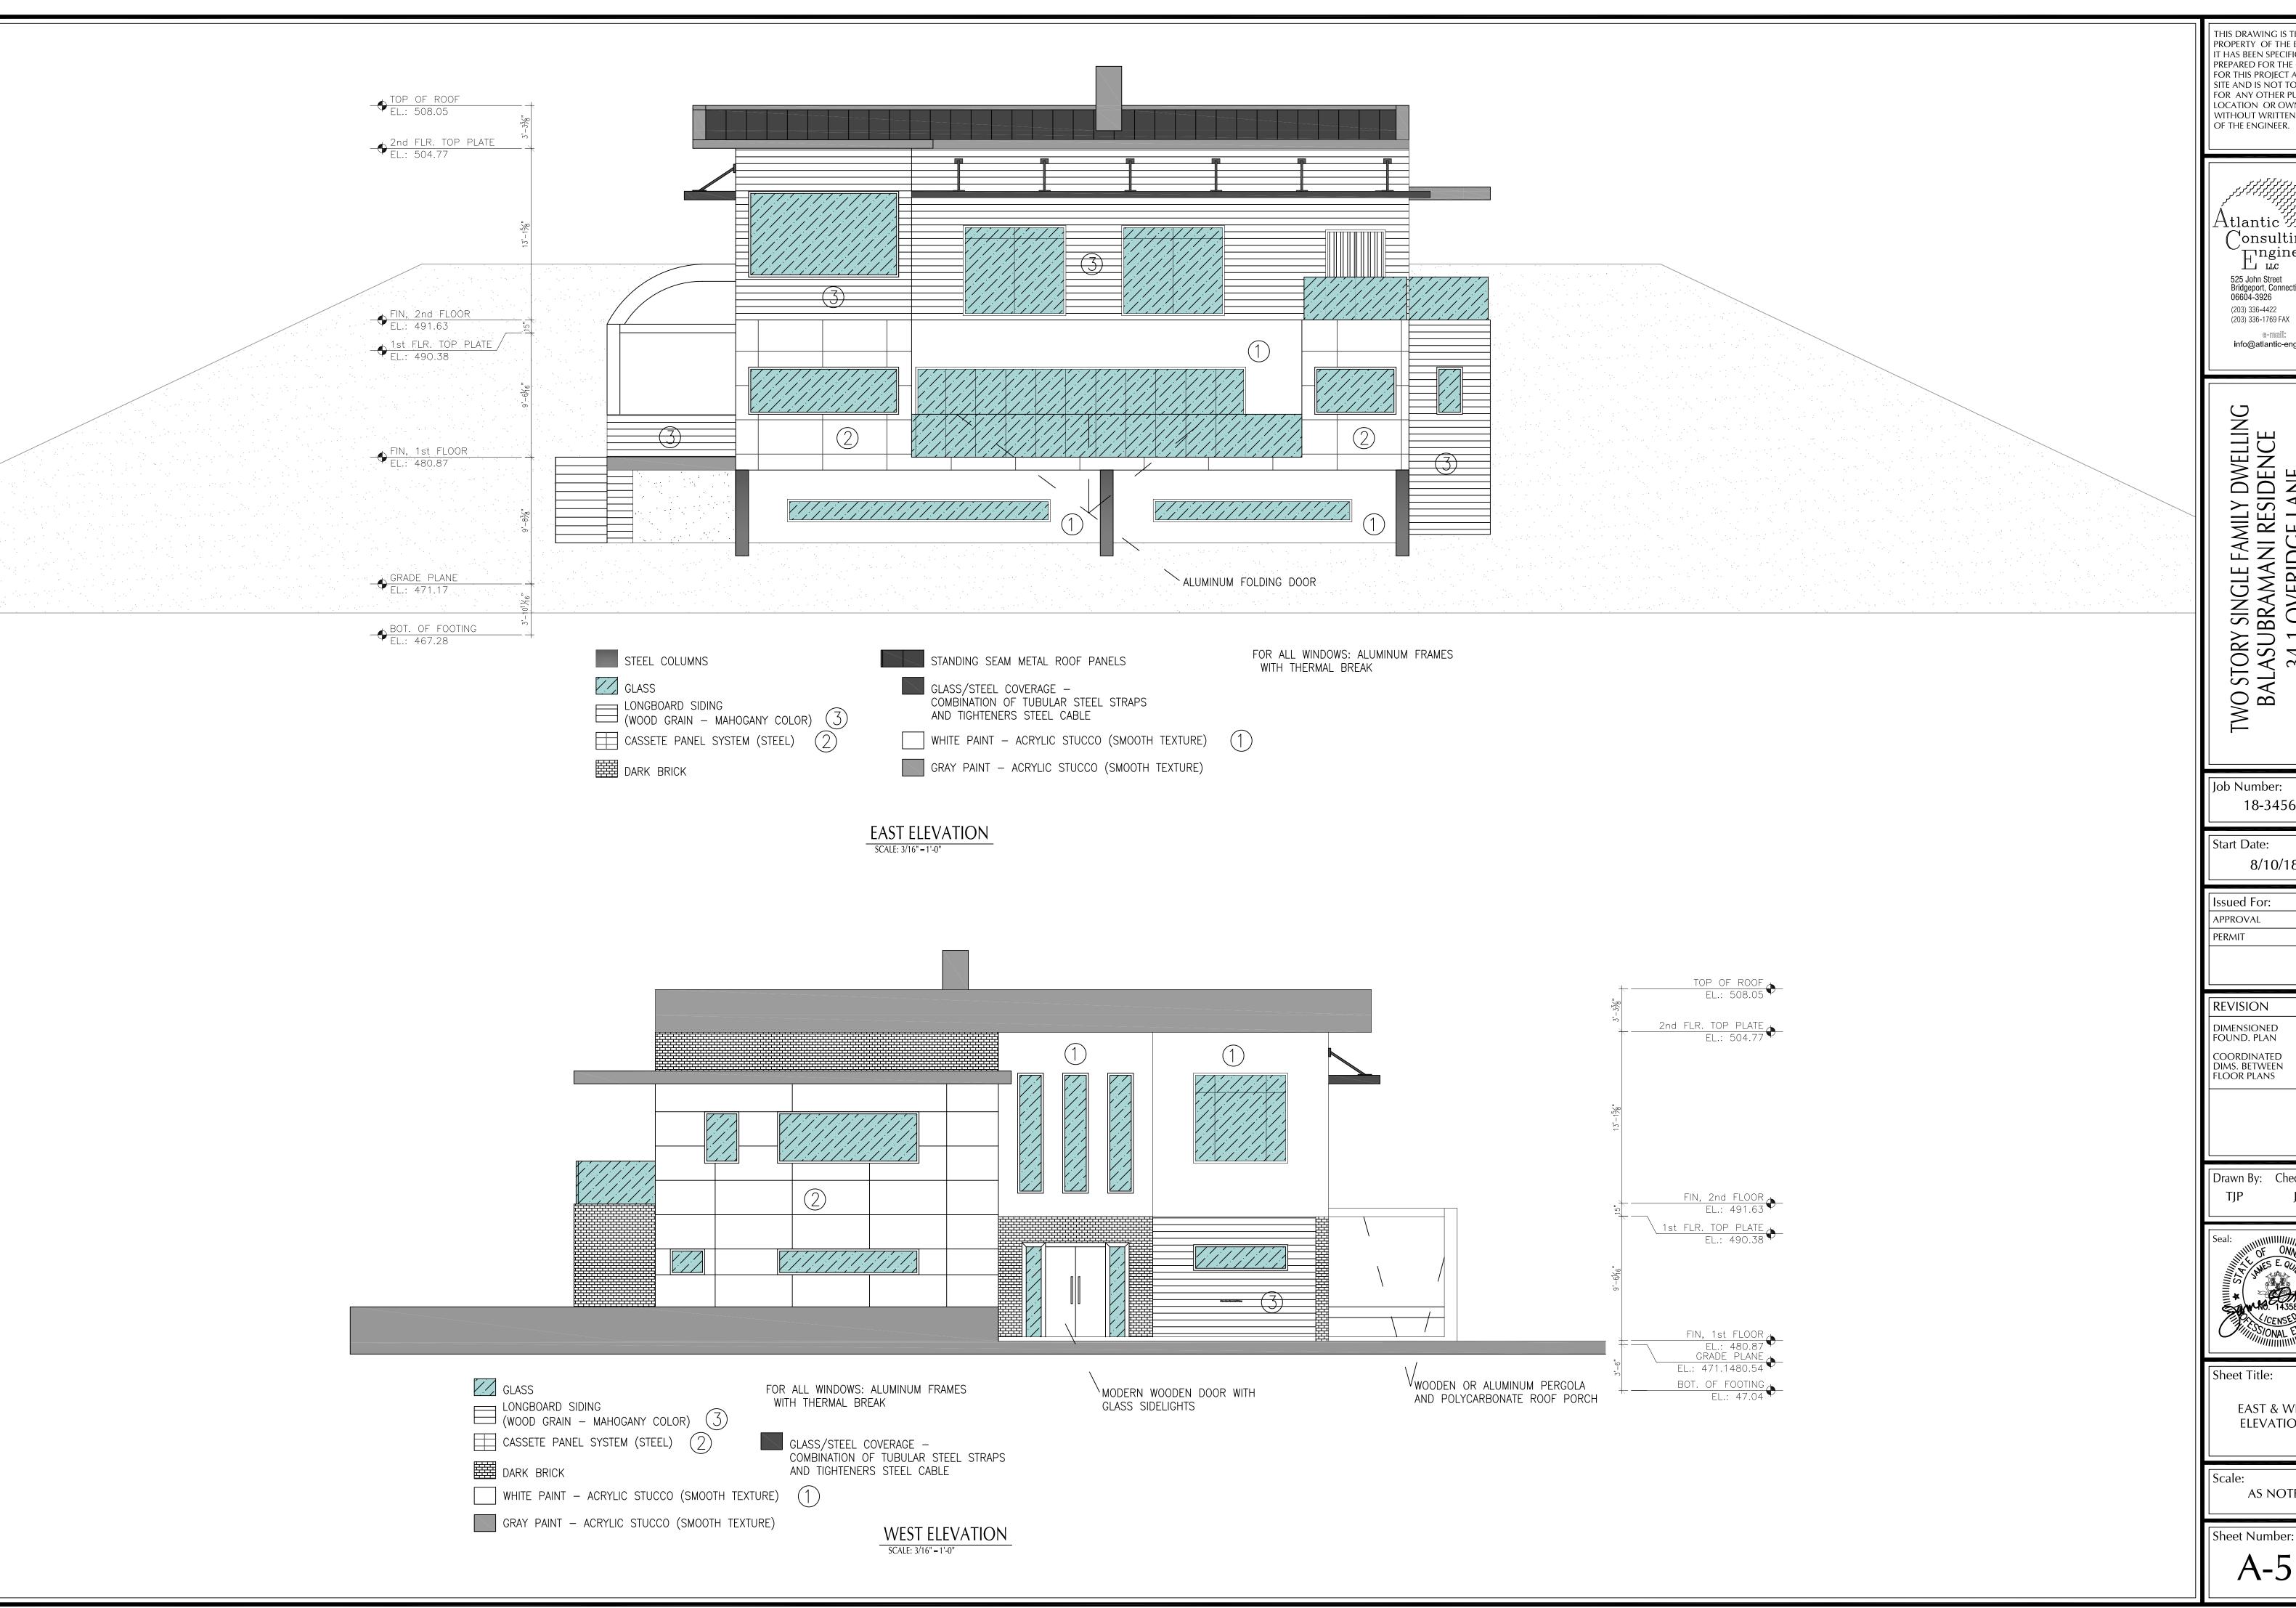

THIS DRAWING IS THE PROPERTY OF THE ENGINEER. IT HAS BEEN SPECIFICALLY PREPARED FOR THE OWNER FOR THIS PROJECT AT THIS SITE AND IS NOT TO BE USED FOR ANY OTHER PURPOSE, LOCATION OR OWNER WITHOUT WRITTEN CONSENT OF THE ENGINEER.

Atlantic &

Consulting &

Ingineering 525 John Street Bridgeport, Connecticut 06604-3926 (203) 336-4422 (203) 336-1769 FAX info@atlantic-eng.com

TWO STORY SINGLE FAMILY DWELLING BALASUBRAMANI RESIDENCE 34-1 OVERIDGE LANE WILTON, CT

Job Number: 18-3456

8/10/18

Issued For:	Date:
APPROVAL	8/15/18
PERMIT	8/16/18

Т	г		
		REVISION	Date:
		DIMENSIONED FOUND. PLAN	10/29/18
		COORDINATED DIMS. BETWEEN FLOOR PLANS	


Drawn By: Checked By:



Sheet Title:

EAST & WEST ELEVATIONS

as noted

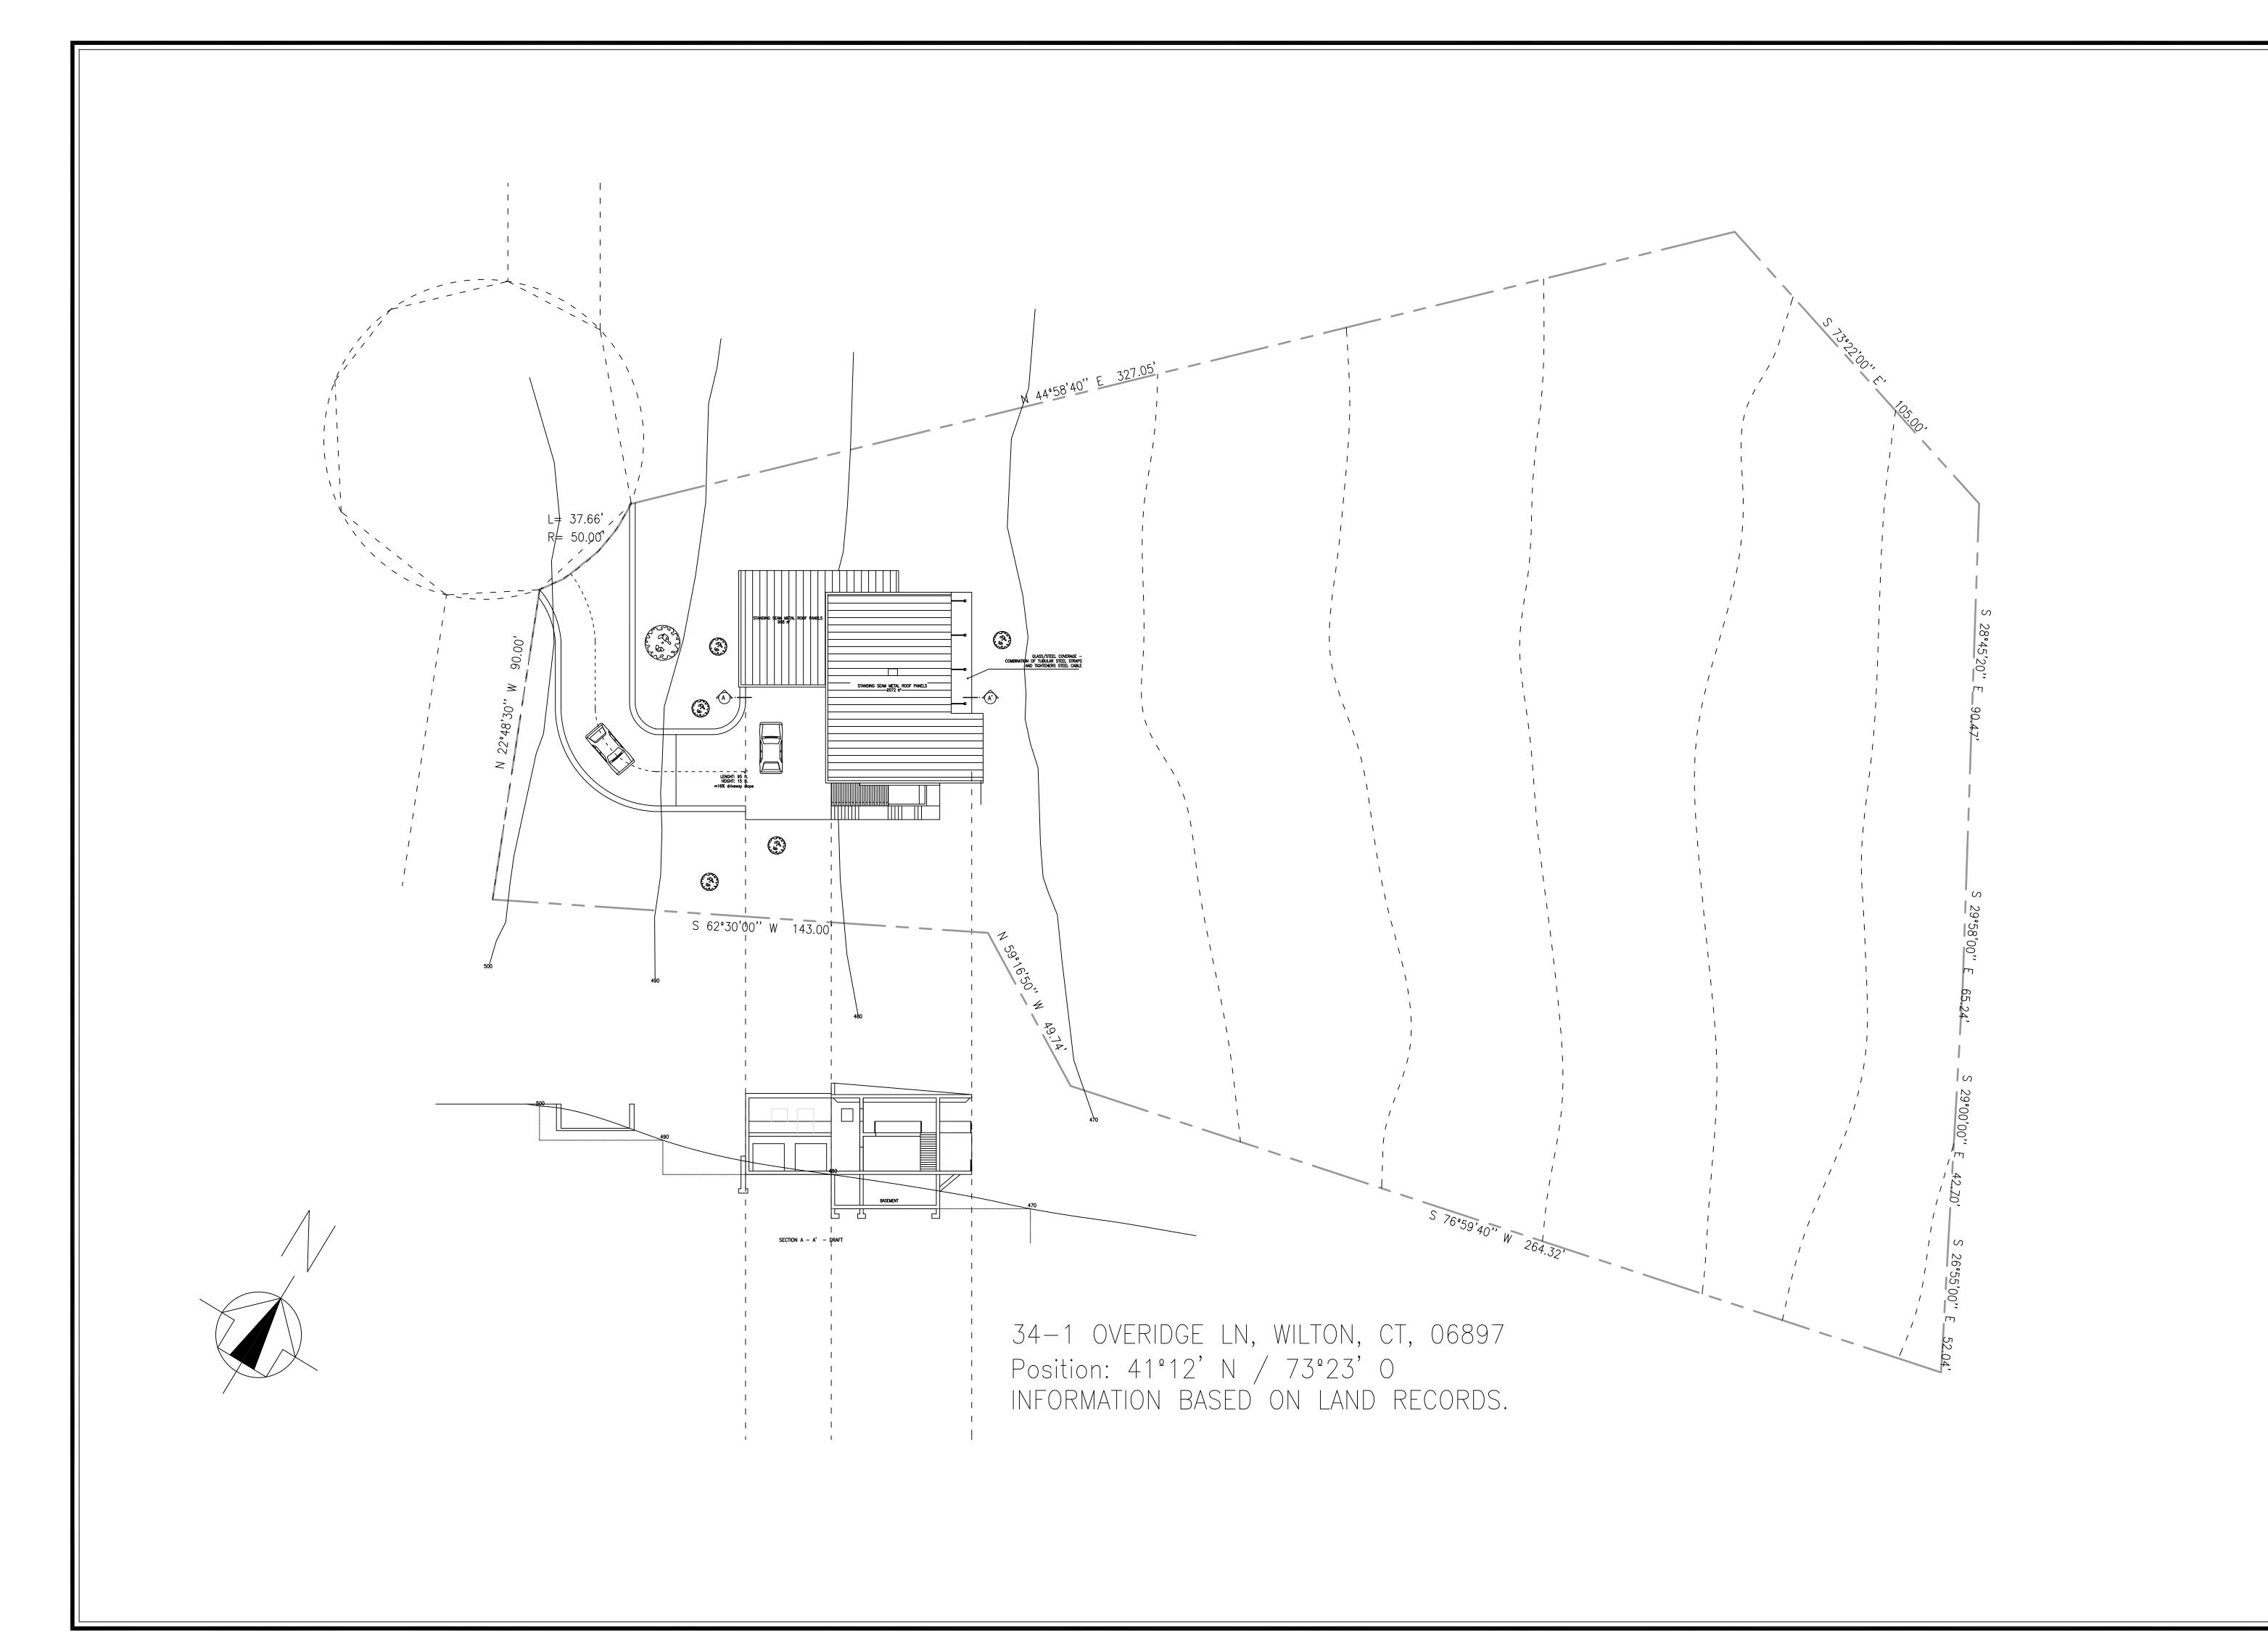

THIS DRAWING IS THE PROPERTY OF THE ENGINEER. IT HAS BEEN SPECIFICALLY PREPARED FOR THE OWNER FOR THIS PROJECT AT THIS SITE AND IS NOT TO BE USED FOR ANY OTHER PURPOSE, LOCATION OR OWNER WITHOUT WRITTEN CONSENT OF THE ENGINEER.

Atlantic \*\*

Onsulting & 
Inc

525 John Street
Bridgeport, Connecticut
06604-3926

(203) 336-4422
(203) 336-1769 FAX

(203) 336-1769 FAX e-mail: info@atlantic-eng.com

TWO STORY SINGLE FAMILY DWELLING BALASUBRAMANI RESIDENCE 34-1 OVERIDGE LANE WILTON, CT


Job Number: 18-3456

> rt Date: 8/10/18

Issued For:	Date:			
APPROVAL	8/15/18			
PERMIT	8/16/18			

REVISION	Date:
DIMENSIONED FOUND. PLAN	10/29/18
COORDINATED DIMS. BETWEEN FLOOR PLANS	

Drawn By: Checked By: TJP JEQ

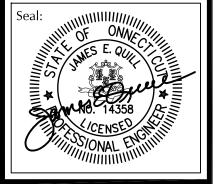


Sheet Title:

SITE PLAN


Scale:

AS NOTED

Sheet Number:

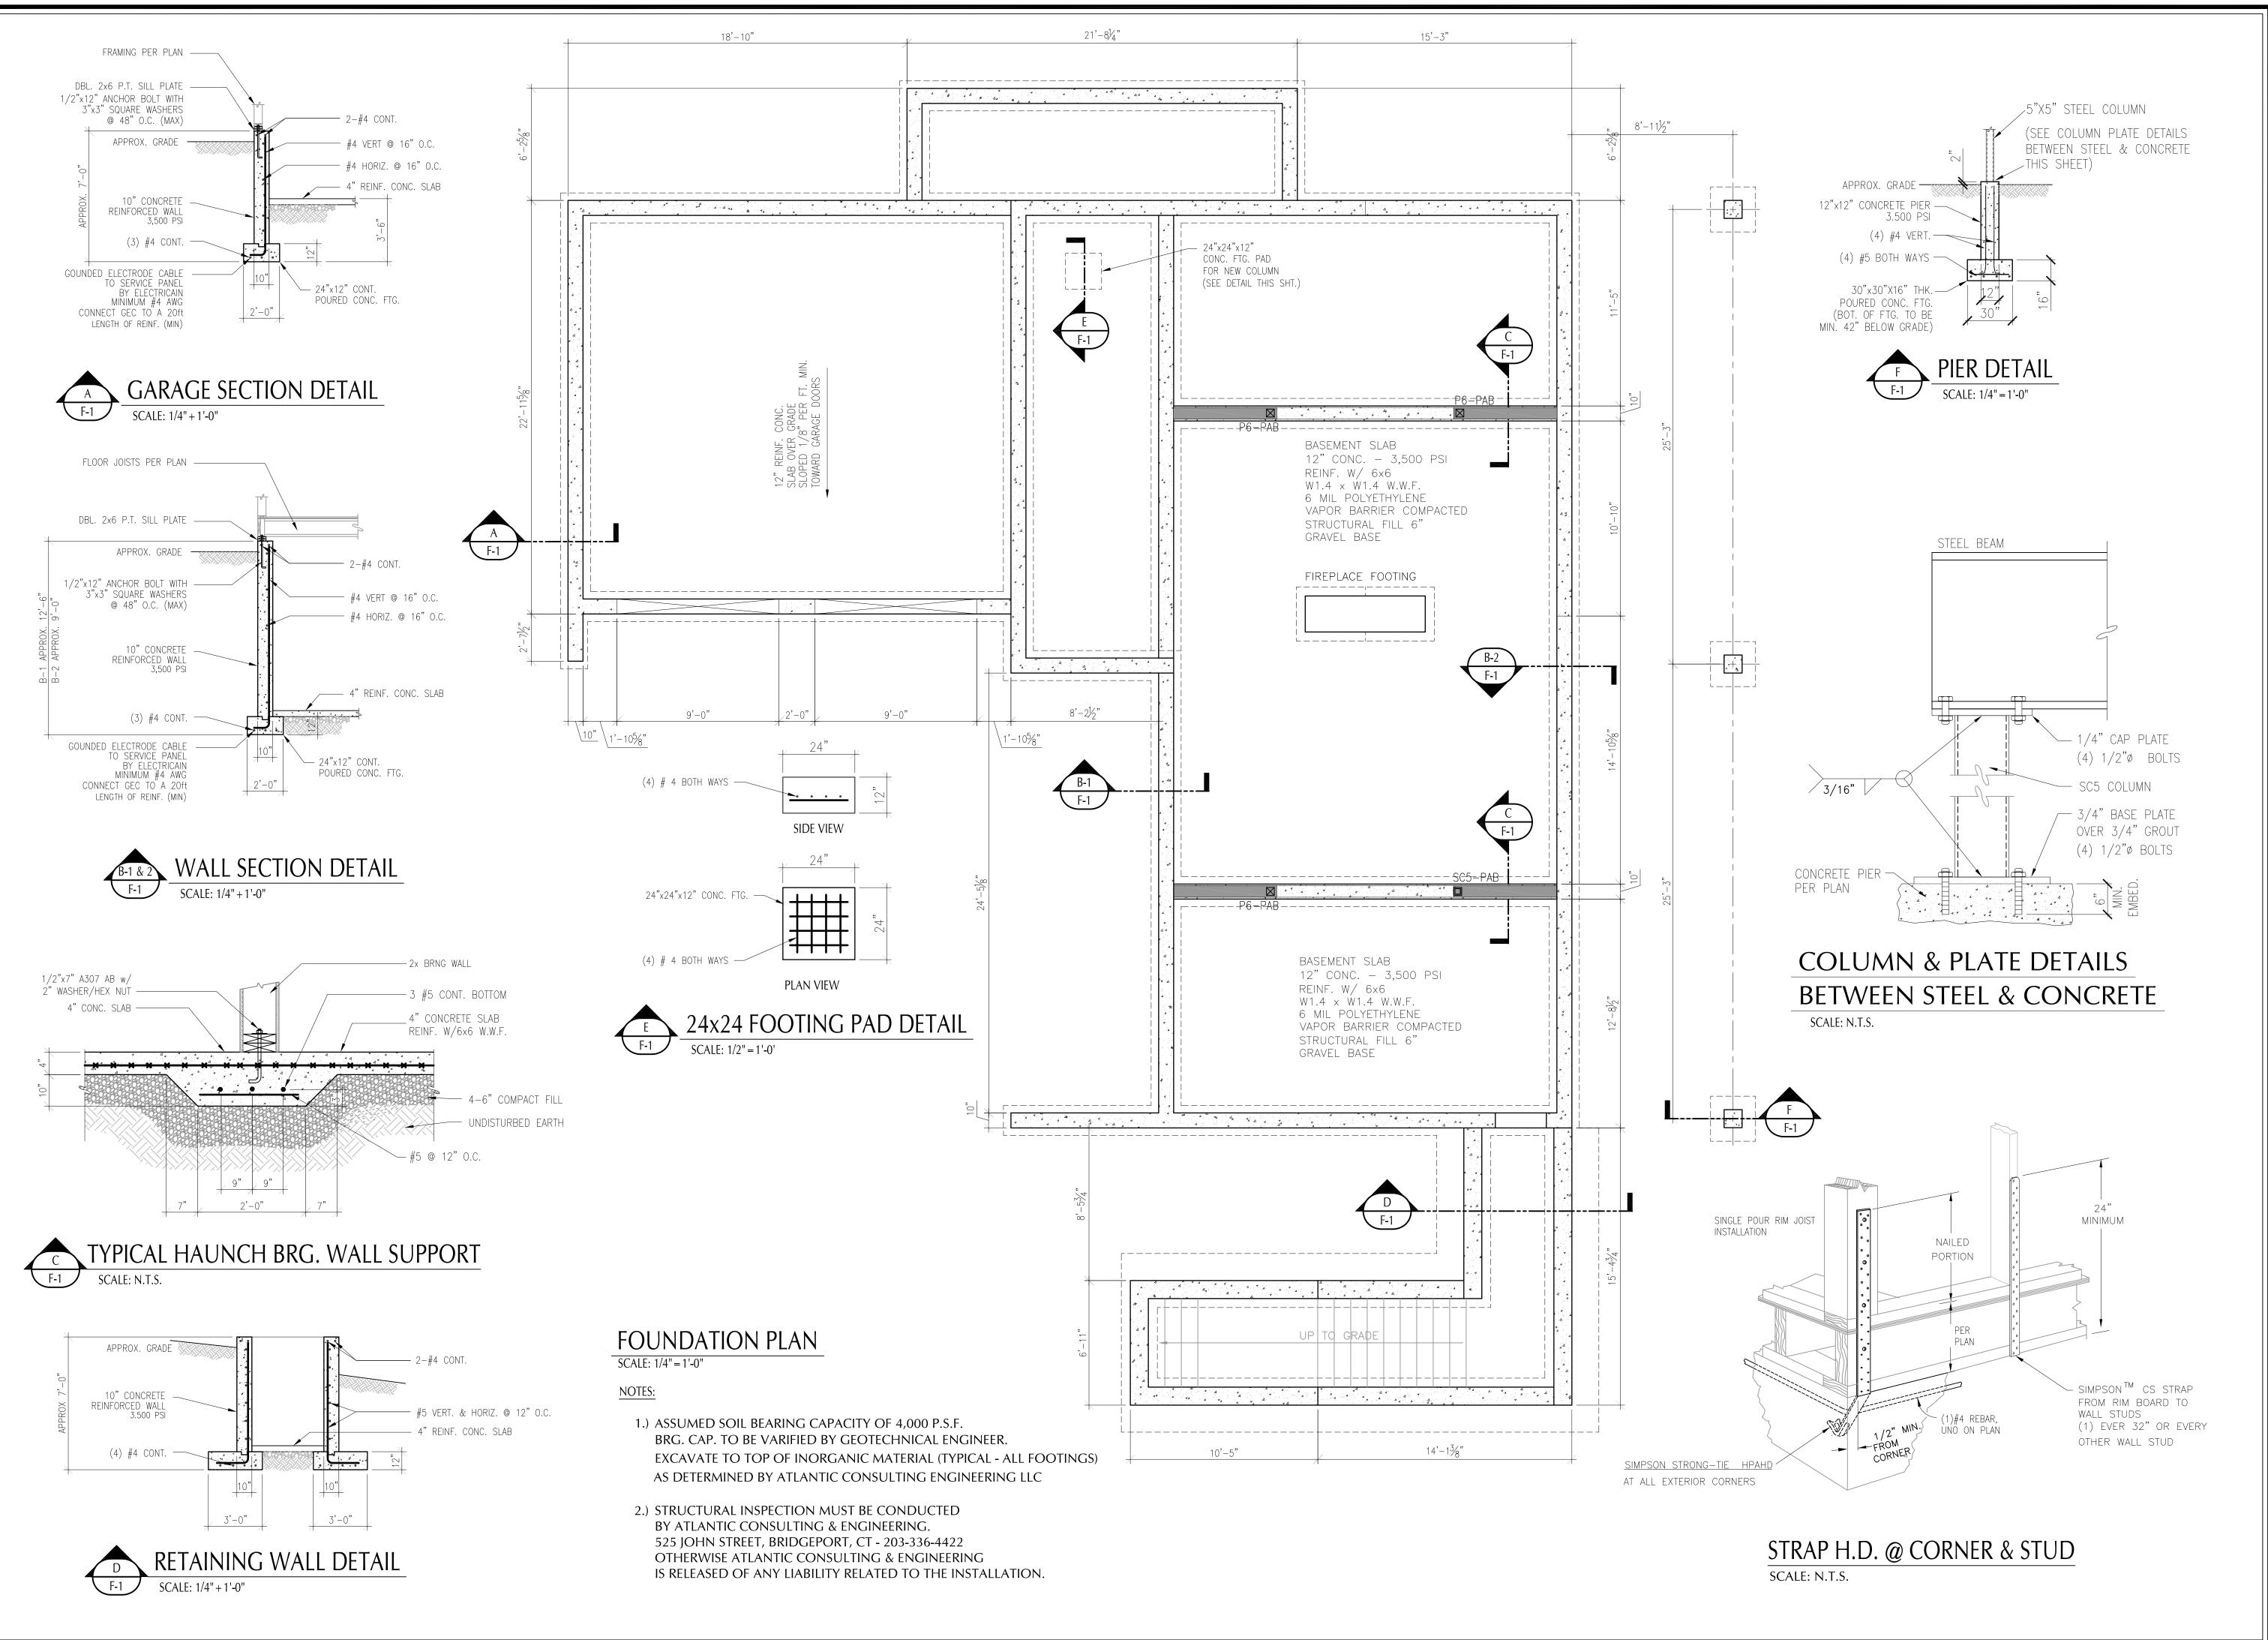

THIS DRAWING IS THE PROPERTY OF THE ENGINEER. IT HAS BEEN SPECIFICALLY PREPARED FOR THE OWNER FOR THIS PROJECT AT THIS SITE AND IS NOT TO BE USED FOR ANY OTHER PURPOSE, LOCATION OR OWNER WITHOUT WRITTEN CONSENT OF THE ENGINEER.

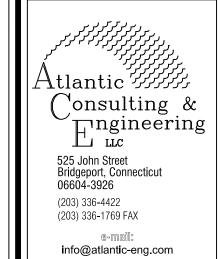

TWO STORY SINGLE FAMILY DWELLING BALASUBRAMANI RESIDENCE 34-1 OVERIDGE LANE WILTON, CT


Job Number: 18-3456

> art Date: 8/1/18

Issued For:	Date:
APPROVAL	8/15/18
PERMIT	8/16/18

REVISION	Date:
DIMENSIONED FOUND. PLAN	10/29/18
COORDINATED DIMS. BETWEEN FLOOR PLANS	

Drawn By: Checked By: TJP JEQ

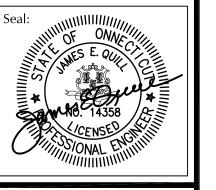

Sheet Title:
FOUNDATION
PLAN

Scale: AS NOTED

Sheet Number: F-1



*44" ABOVE SUB-FLOOR* 

ALL EXTERIOR HEADERS SHALL BE DBL 2x10 #SPF (UNO ON PLANS) SILL HEIGHTS TO BE NOT MORE THAN

ALL INTERIOR LOAD BEARING HEADERS SHALL BE AS FOLLOWS: (UNO ON PLANS)


BE AS	BE AS FULLOWS: (UNO UN PLANS)			
CLEAR SPAN	PLY	MEMBER SIZE	# OF JACK STUDS	# OF KING STUDS
0' TO 3'	2	2x6	1	1
3' TO 6'	2	2x8	1	1
6' TO 8'	2	2x10	2	1
8' OR +	1-3/4"xAS SPECIFIED LVL			/L


ALL INTERIOR NON-LOAD BEARING TO BE: 2-2x4 - OPN'GS UP TO 3'-4" 2-2x6 - OPN'GS OVER 3'-4"


LVL - 13/4" MICROLLAM 1.9E (SEE PLANS FOR SIZES) SPF - SPRUCE\_PINE\_FIR #2 (OR BETTER) TJI - 9½" OR 11½" 110, 230, 360, 560 1.8E SEE PLANS FOR SIZE AND SERIES USED

MAXIMUM DEFLECTION = L/380

LL = 40 AND DL = 15

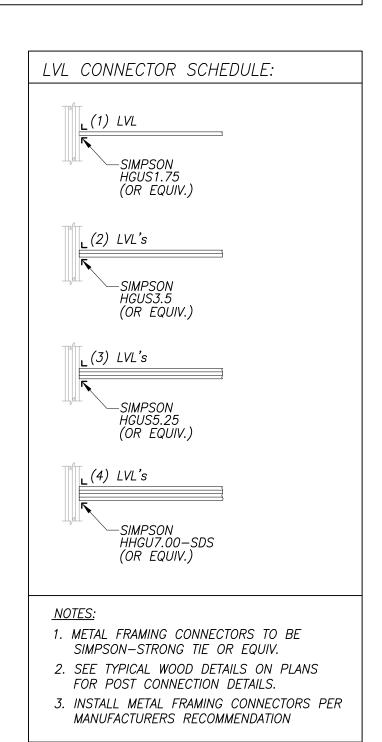

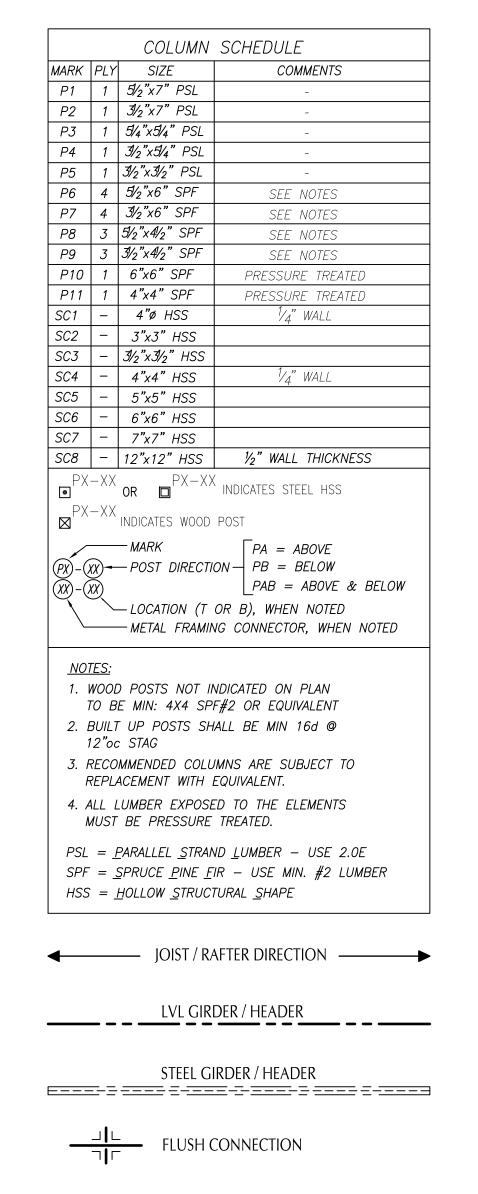

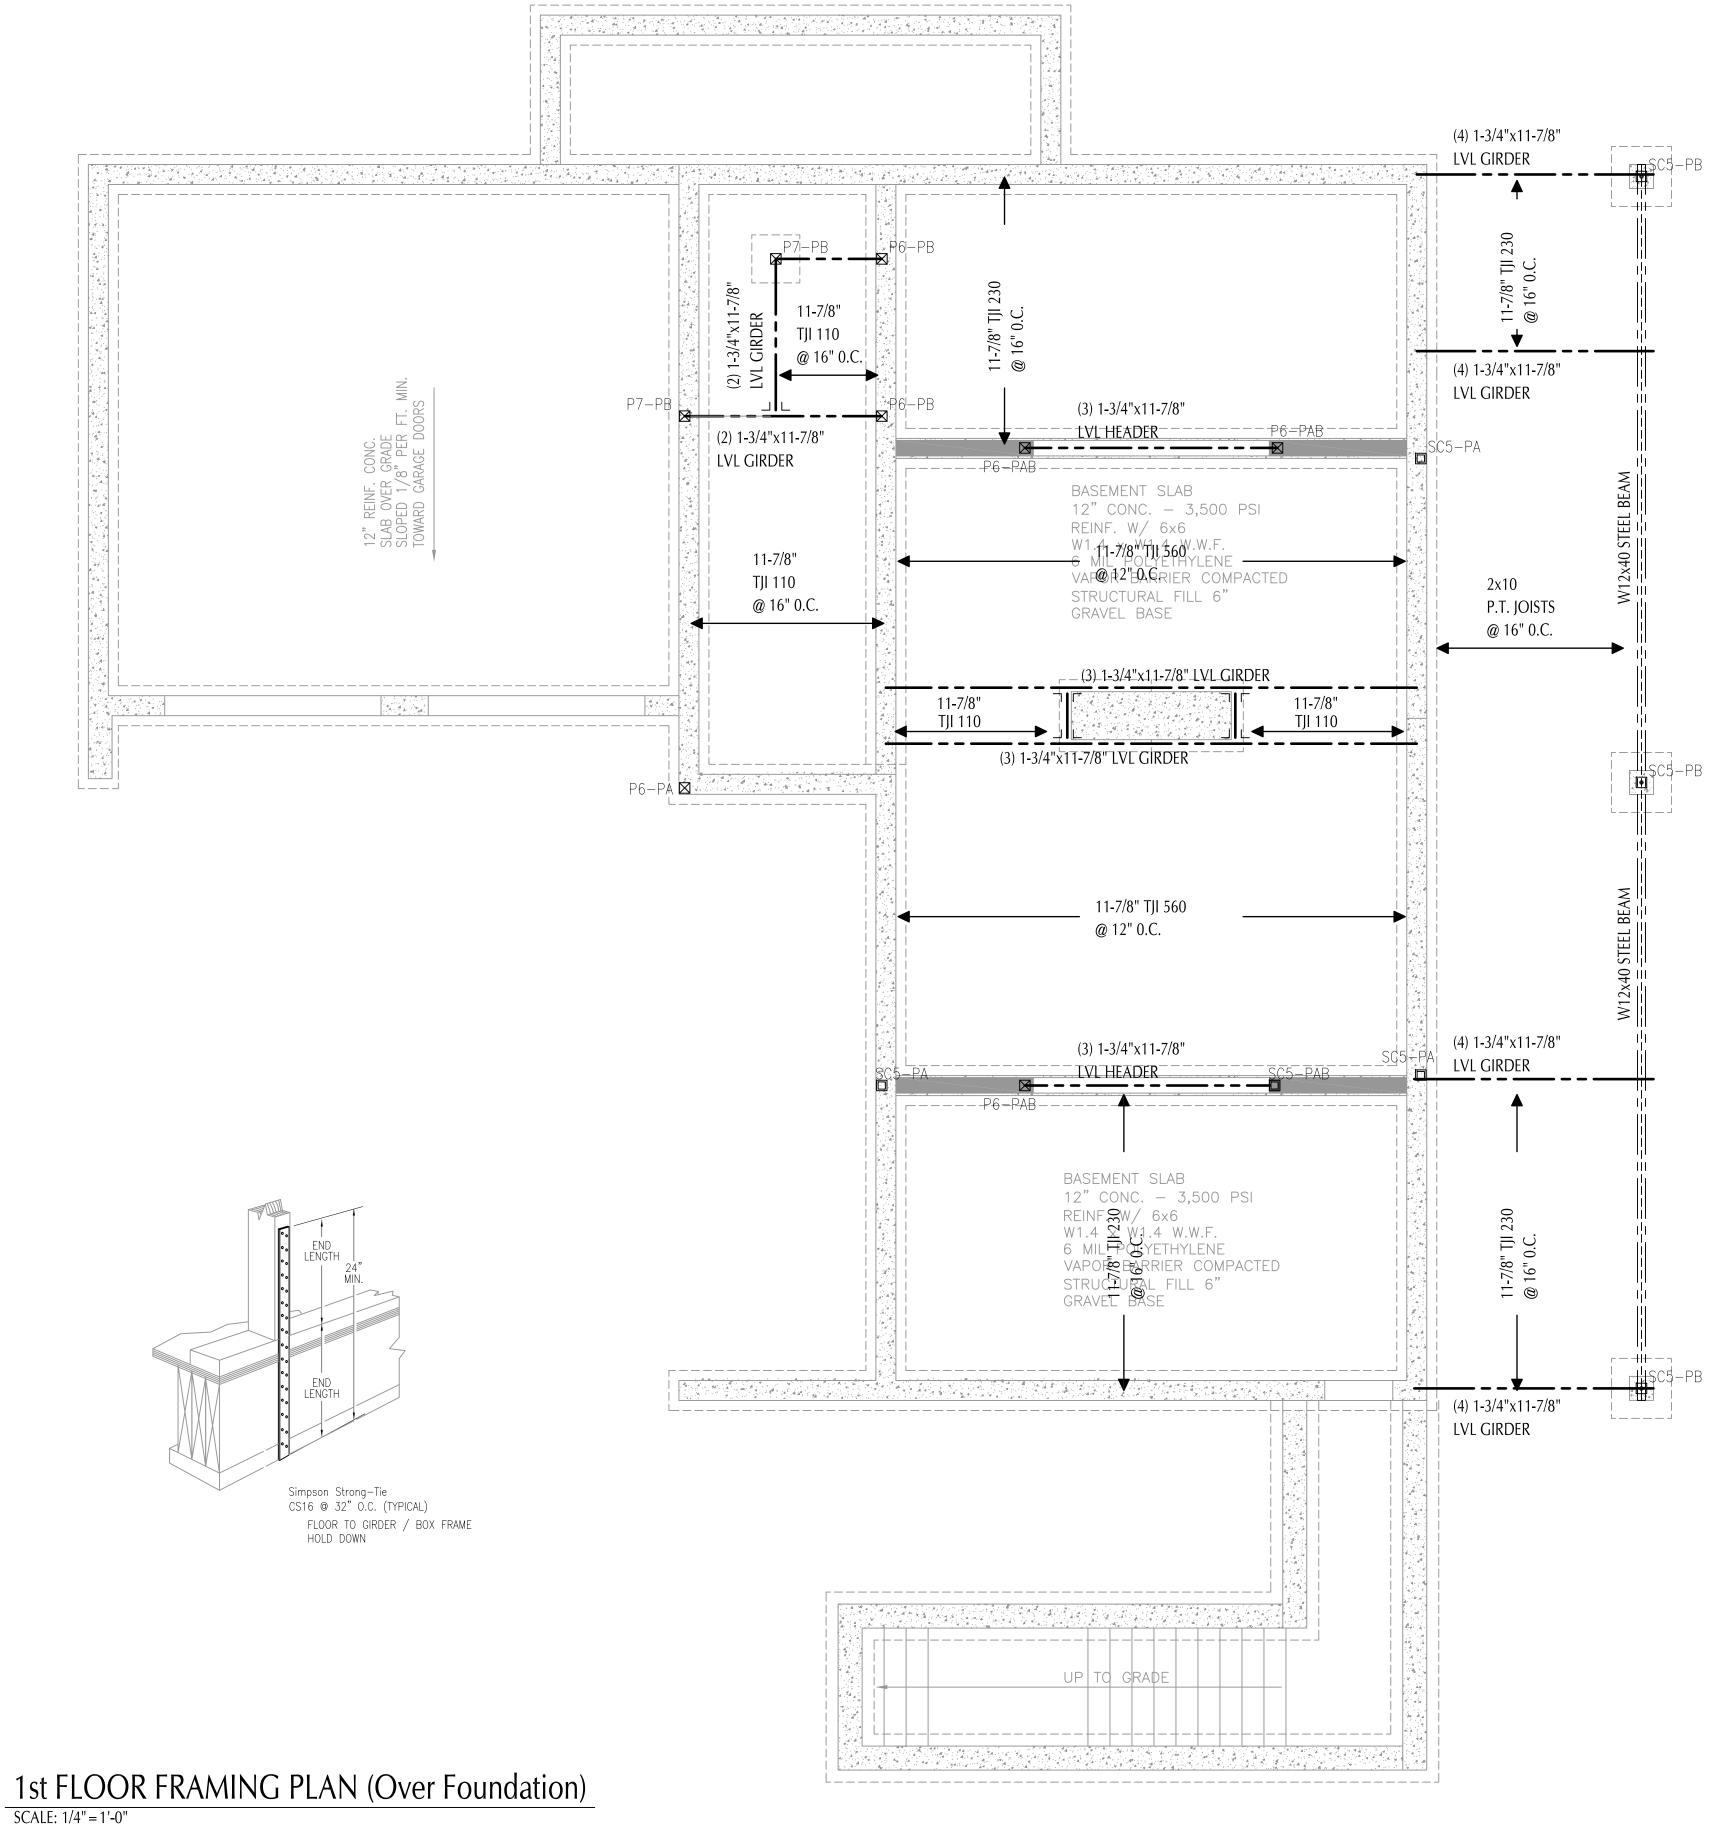

THIS DRAWING IS THE IT HAS BEEN SPECIFICALLY PREPARED FOR THE OWNER FOR THIS PROJECT AT THIS SITE AND IS NOT TO BE USED FOR ANY OTHER PURPOSE, LOCATION OR OWNER WITHOUT WRITTEN CONSENT OF THE ENGINEER.

 $A_{ ext{tlantic}}$ Consulting & Engineering Bridgeport, Connecticut (203) 336-4422 (203) 336-1769 FAX info@atlantic-eng.com

TWO STORY SINGLE FAMILY DWELLING BALASUBRAMANI RESIDENCE 34-1 OVERIDGE LANE WILTON, CT


Job Number: 18-3456

8/1/18

Issued For: Date: APPROVAL 8/15/18 PERMIT 8/16/18

REVISION Date: DIMENSIONED 10/29/18 FOUND. PLAN COORDINATED DIMS. BETWEEN FLOOR PLANS

Drawn By: Checked By:

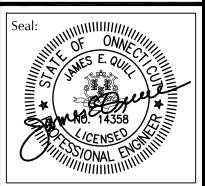

Sheet Title: 1st FLOOR FRAMING PLAN

AS NOTED

Sheet Number:

STRUCTURAL INSPECTION MUST BE CONDUCTED BY ATLANTIC CONSULTING & ENGINEERING. 525 JOHN STREET, BRIDGEPORT, CT - 203-336-4422 OTHERWISE ATLANTIC CONSULTING & ENGINEERING IS RELEASED OF ANY LIABILITY RELATED TO THE INSTALLATION.



*44" ABOVE SUB-FLOOR* 

ALL EXTERIOR HEADERS SHALL BE DBL 2x10 #SPF (UNO ON PLANS) SILL HEIGHTS TO BE NOT MORE THAN

ALL INTERIOR LOAD BEARING HEADERS SHALL BE AS FOLLOWS: (UNO ON PLANS)


DL AS TOLLOWS. (ONO ON TLANS)				
CLEAR SPAN	PLY	MEMBER SIZE	# OF JACK STUDS	# OF KING STUDS
0' TO 3'	2	2x6	1	1
3' TO 6'	2	2x8	1	1
6' TO 8'	2	2x10	2	1
8' OR +	1-3/4"xAS SPECIFIED LVL			/L


2-2x4 - OPN'GS UP TO 3'-4" 2-2x6 - OPN'GS OVER 3'-4"

ALL INTERIOR NON-LOAD BEARING TO BE:


 $LVL - 1\frac{3}{4}$ " MICROLLAM 1.9E (SEE PLANS FOR SIZES) SPF - SPRUCE\_PINE\_FIR #2 (OR BETTER) TJI - 9½" OR 11½" 110, 230, 360, 560 1.8E SEE PLÂNS FOR SIZE AND SERIES ÚSED

MAXIMUM DEFLECTION = L/380LL = 40 AND DL = 15

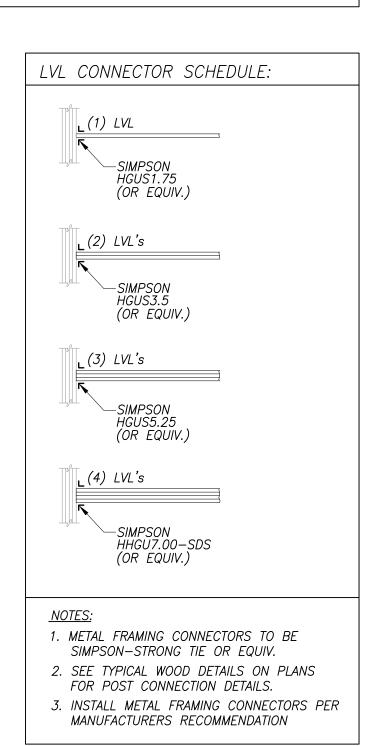

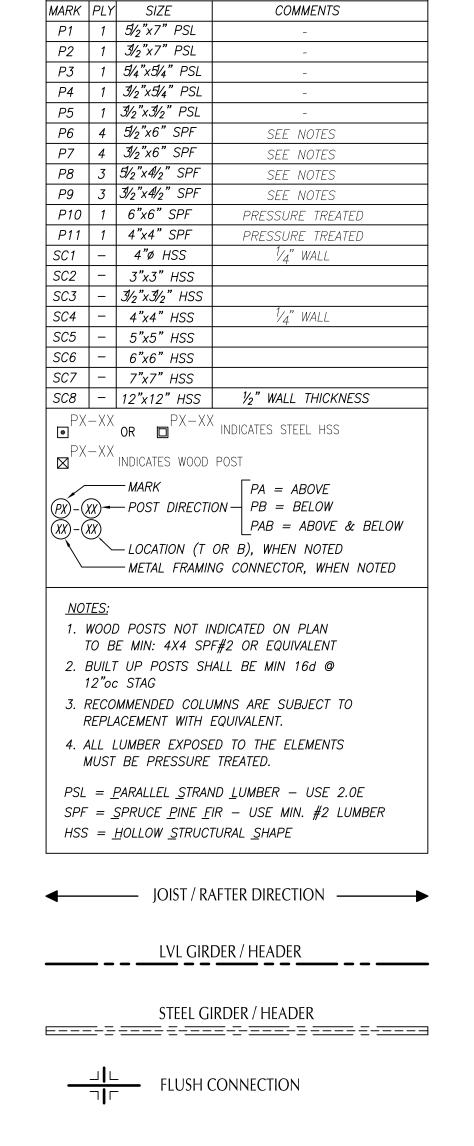


COLUMN SCHEDULE

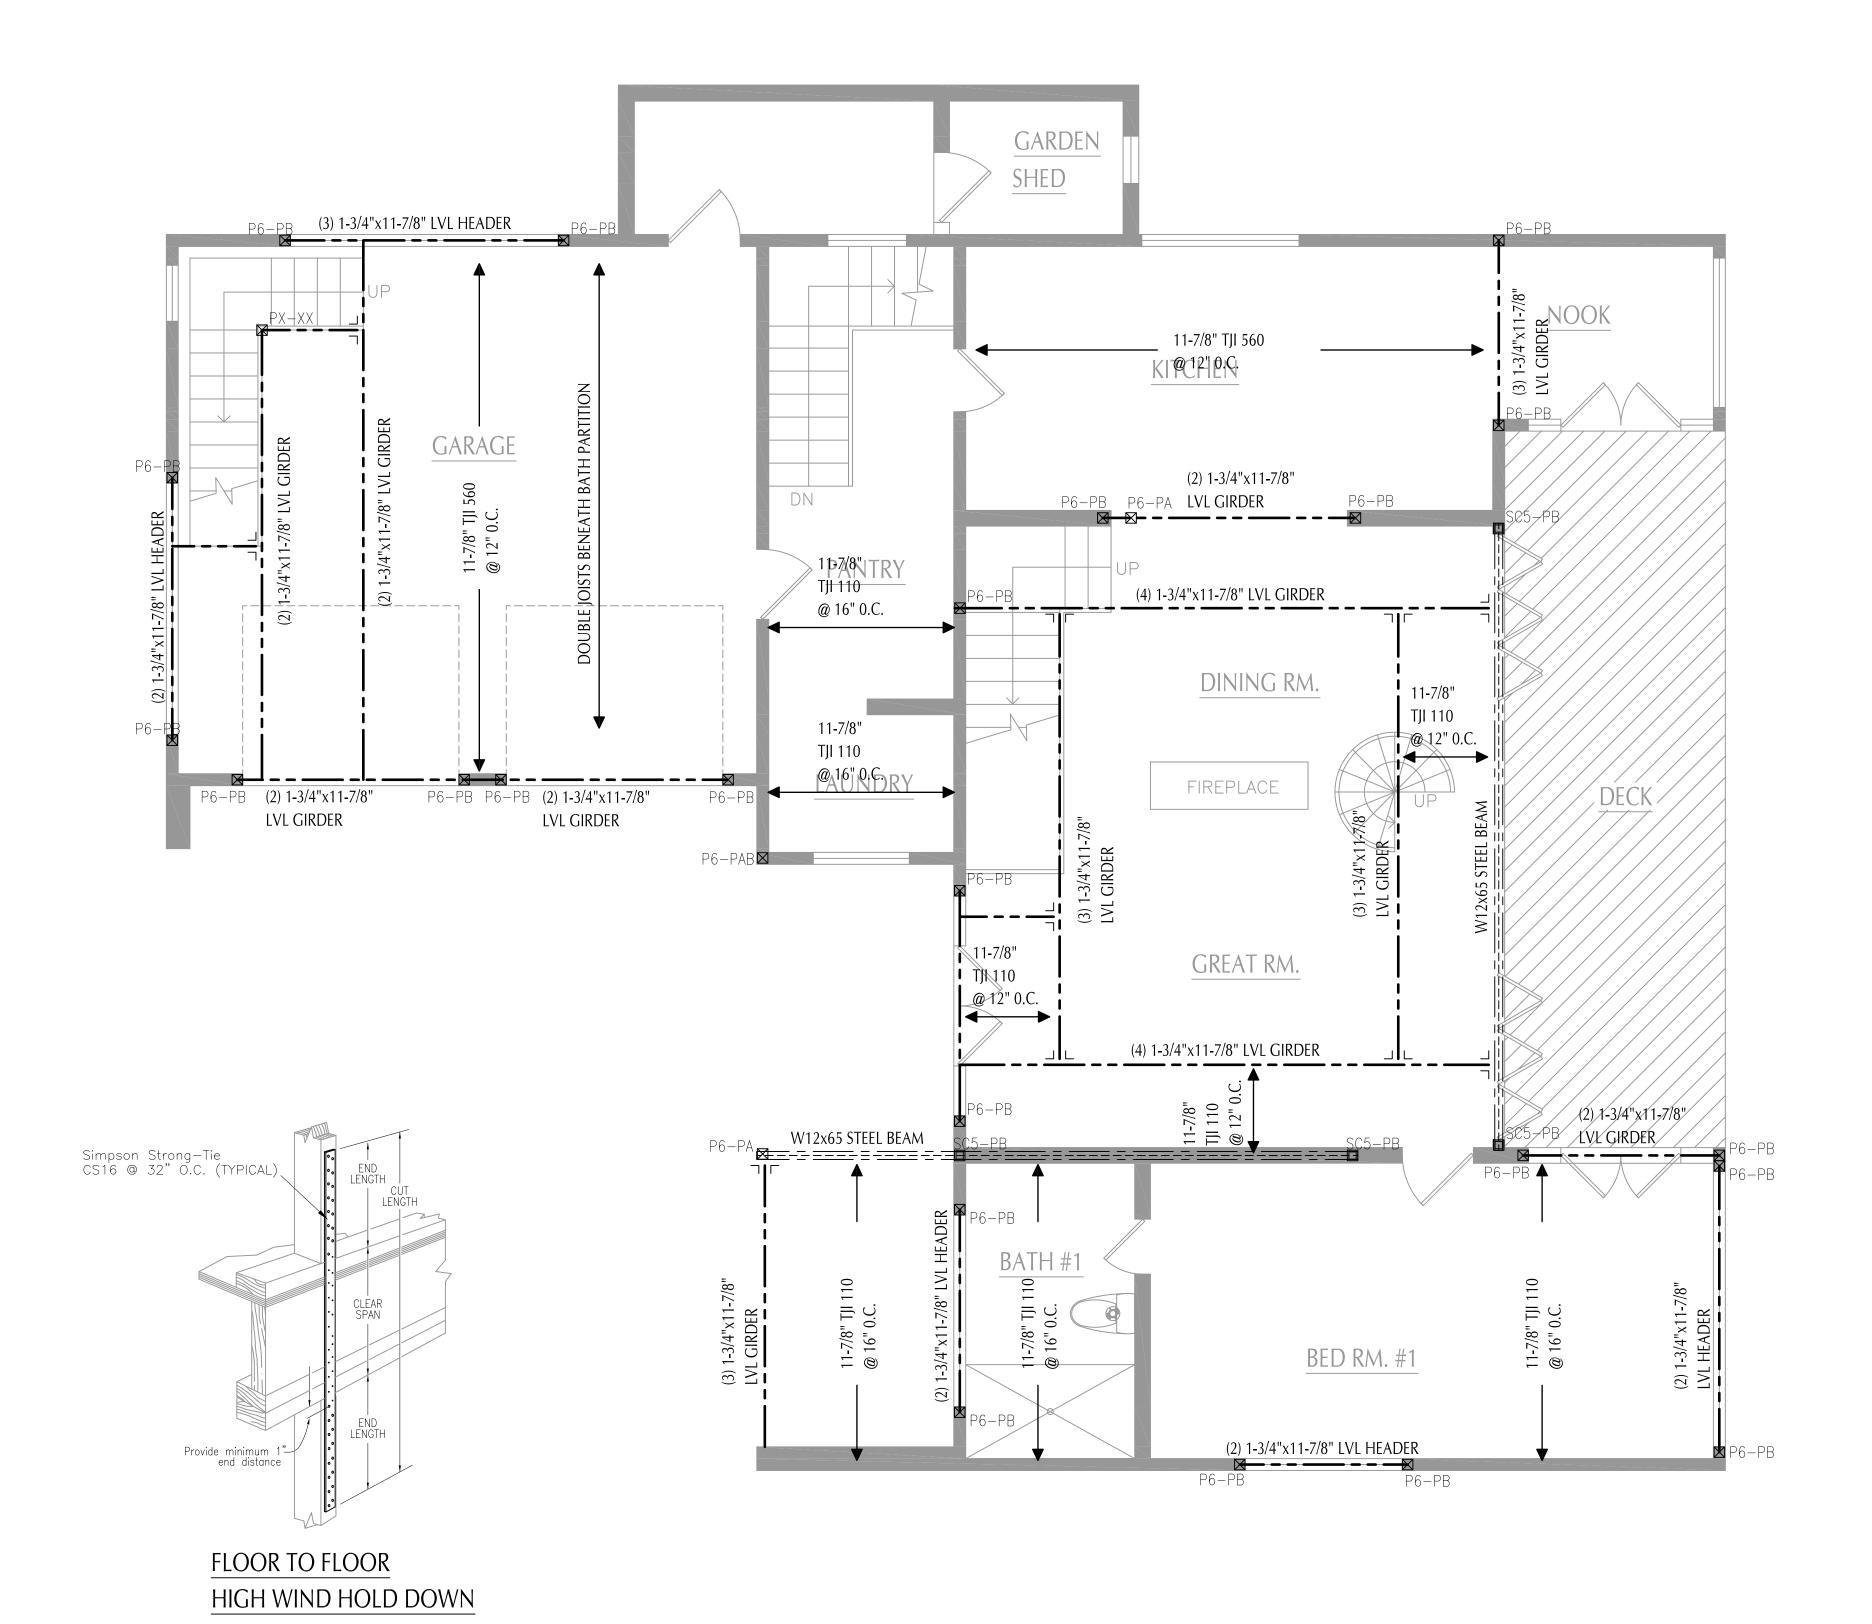

# 2nd FLOOR FRAMING PLAN (Over 1st Floor) SCALE: 1/4" = 1'-0"

STRUCTURAL INSPECTION MUST BE CONDUCTED BY ATLANTIC CONSULTING & ENGINEERING. 525 JOHN STREET, BRIDGEPORT, CT - 203-336-4422 OTHERWISE ATLANTIC CONSULTING & ENGINEERING IS RELEASED OF ANY LIABILITY RELATED TO THE INSTALLATION.

THIS DRAWING IS THE IT HAS BEEN SPECIFICALLY PREPARED FOR THE OWNER FOR THIS PROJECT AT THIS SITE AND IS NOT TO BE USED FOR ANY OTHER PURPOSE, LOCATION OR OWNER WITHOUT WRITTEN CONSENT OF THE ENGINEER.

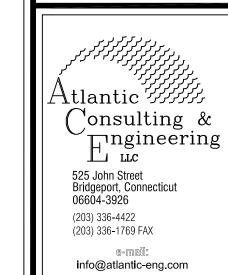

TWO STORY SINGLE FAMILY DWELLING BALASUBRAMANI RESIDENCE 34-1 OVERIDGE LANE WILTON, CT


Job Number: 18-3456

8/1/18

Г		
	Issued For:	Date:
ı	APPROVAL	8/15/18
ı	PERMIT	8/16/18

te:
9/18

Drawn By: Checked By:

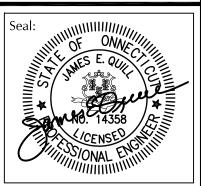

Sheet Title: 2nd FLOOR FRAMING PLAN

**AS NOTED** 

Sheet Number:



*44" ABOVE SUB-FLOOR* 

ALL EXTERIOR HEADERS SHALL BE DBL 2x10 #SPF (UNO ON PLANS) SILL HEIGHTS TO BE NOT MORE THAN

ALL INTERIOR LOAD BEARING HEADERS SHALL

	BE AS FOLLOWS: (UNO ON PLANS)				
	CLEAR SPAN	PLY	MEMBER SIZE	# OF JACK STUDS	# OF KING STUDS
	0' TO 3'	2	2x6	1	1
	3' TO 6'	2	2x8	1	1
	6' TO 8'	2	2x10	2	1
8' OR + 1-3/4"xAS SPECIFIED LVL					


2-2x4 - OPN'GS UP TO 3'-4" 2-2x6 - OPN'GS OVER 3'-4"


ALL INTERIOR NON-LOAD BEARING TO BE:

LVL - 13/4" MICROLLAM 1.9E (SEE PLANS FOR SIZES) SPF - SPRUCE\_PINE\_FIR #2 (OR BETTER) TJI - 9½" OR 11½" 110, 230, 360, 560 1.8E SEE PLÂNS FOR SIZE AND SERIES ÚSED

MAXIMUM DEFLECTION = L/380

LL = 40 AND DL = 15

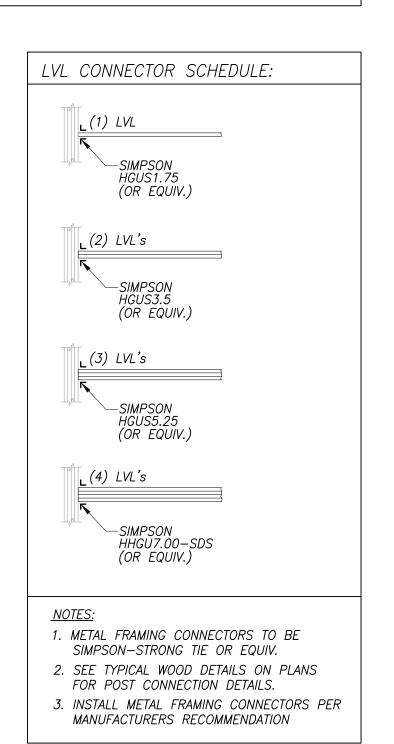

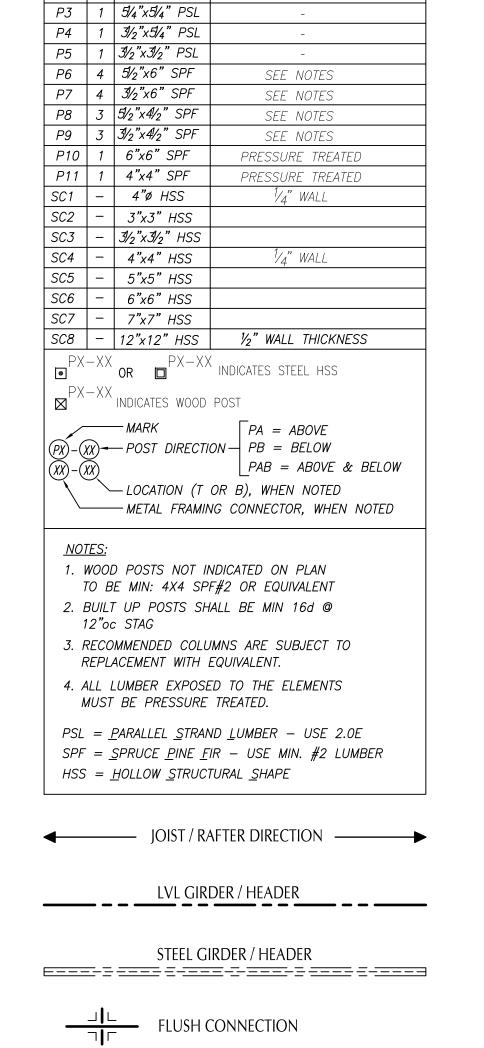


COLUMN SCHEDULE

COMMENTS

MARK PLY SIZE

P1 1 5½"x7" PSL

P2 1 3½"x7" PSL

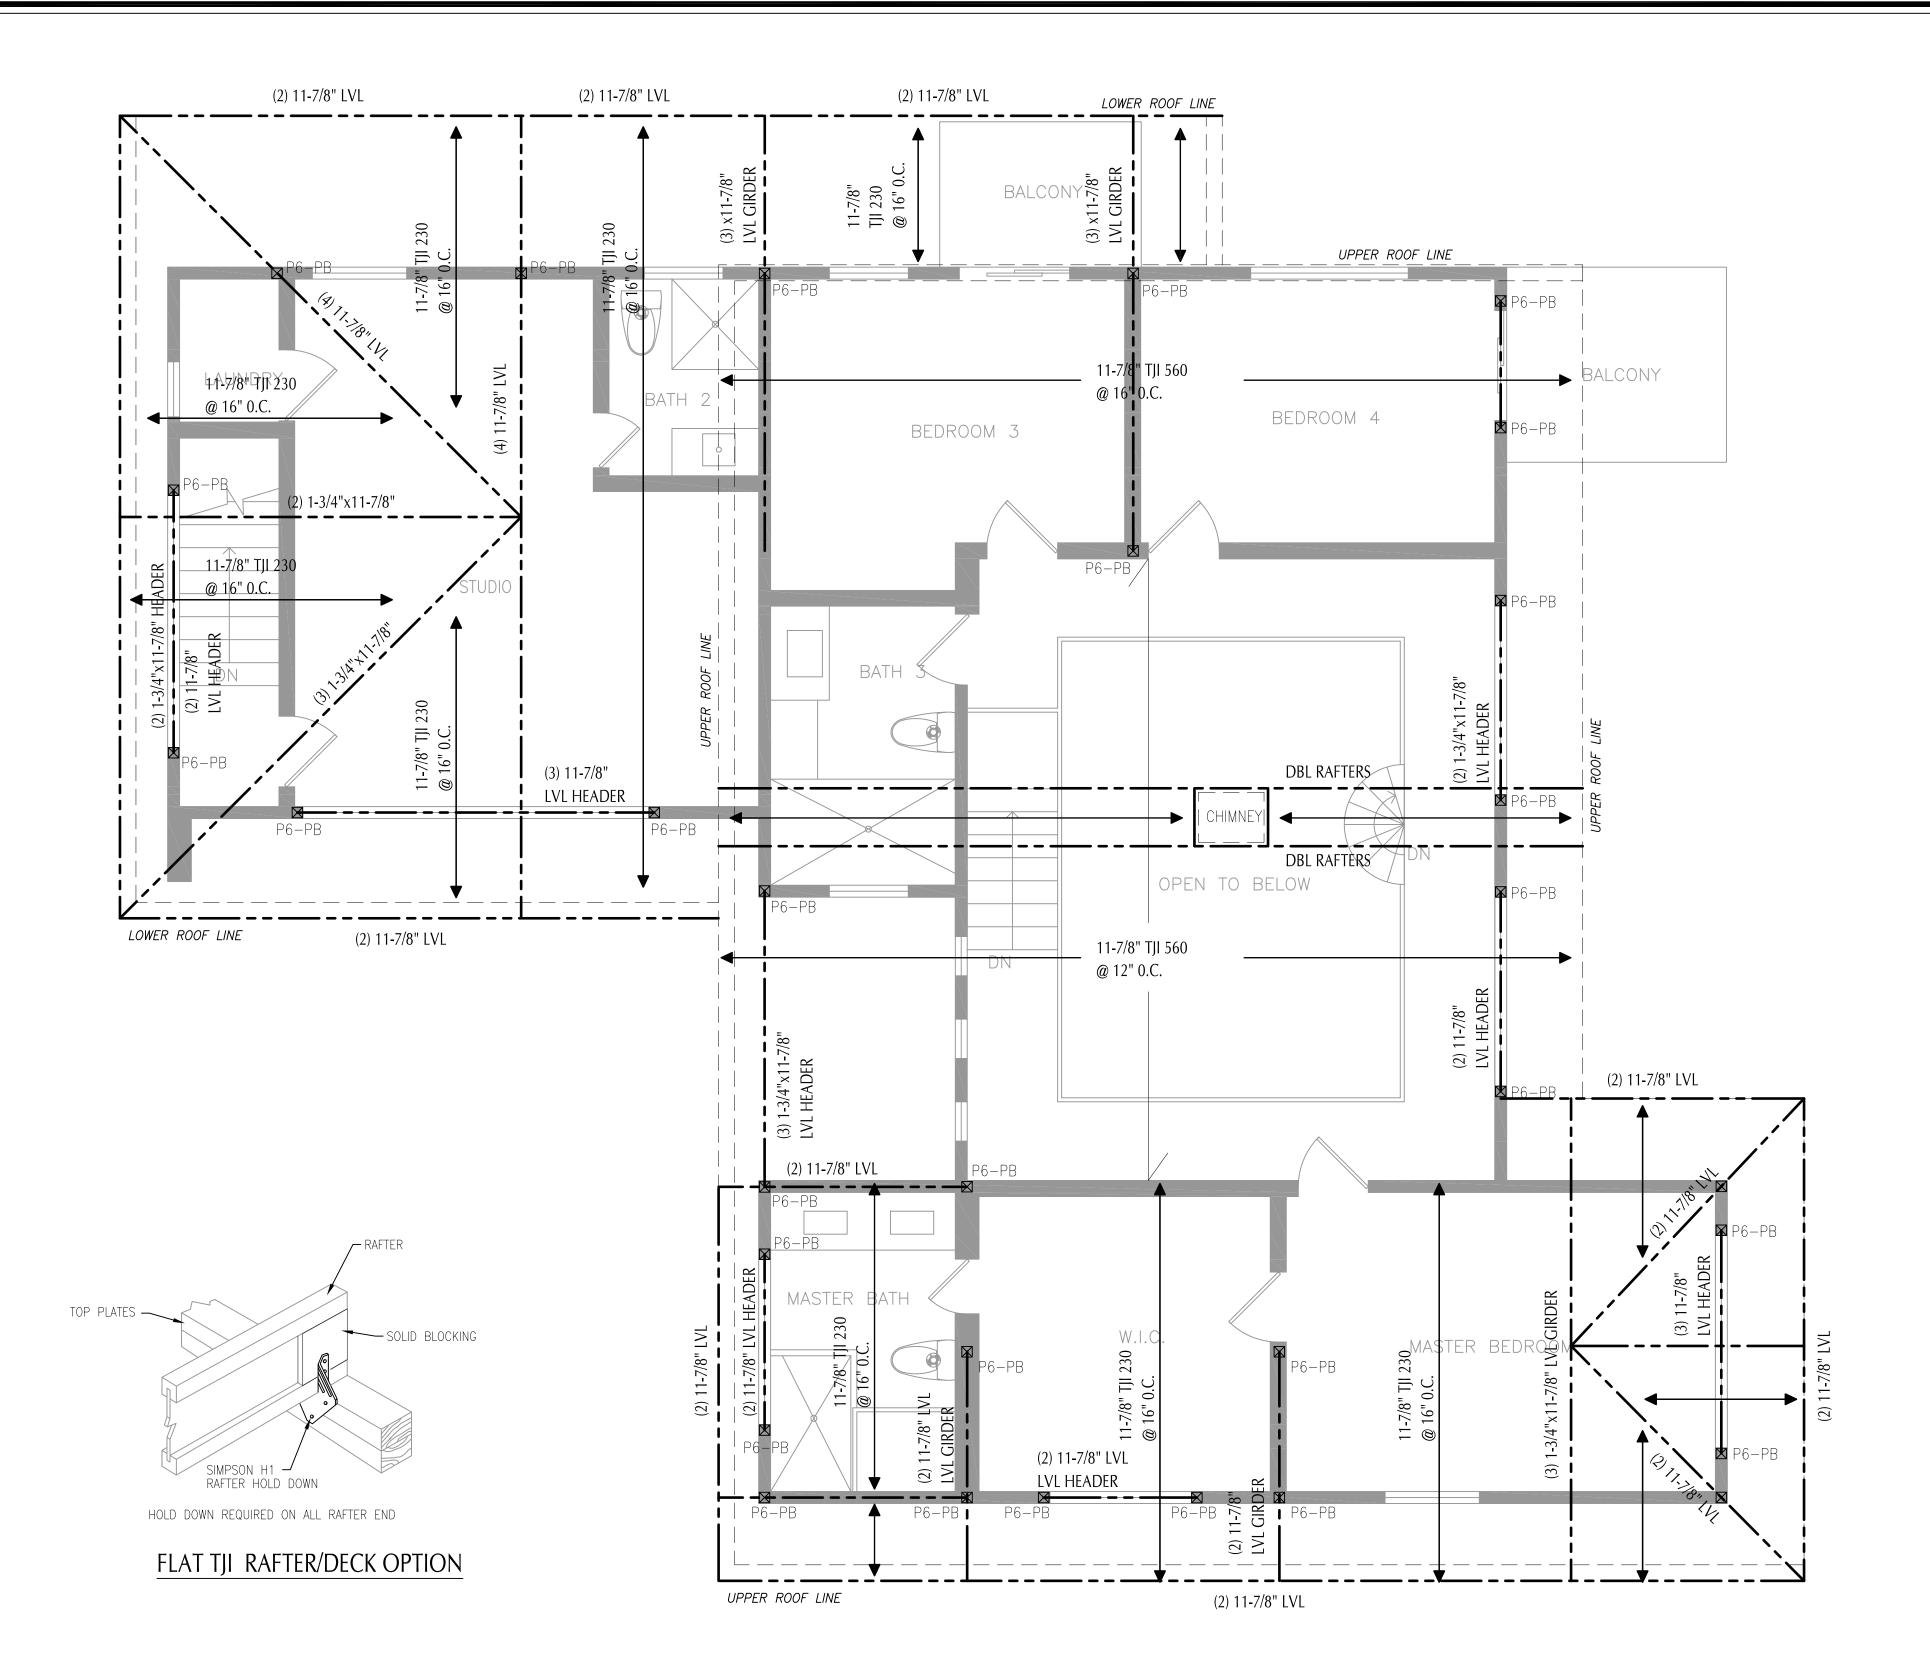

# ROOF FRAMING PLAN (Over Attic Floor) SCALE: 1/4" = 1'-0"

STRUCTURAL INSPECTION MUST BE CONDUCTED BY ATLANTIC CONSULTING & ENGINEERING. 525 JOHN STREET, BRIDGEPORT, CT - 203-336-4422 OTHERWISE ATLANTIC CONSULTING & ENGINEERING IS RELEASED OF ANY LIABILITY RELATED TO THE INSTALLATION.

THIS DRAWING IS THE IT HAS BEEN SPECIFICALLY PREPARED FOR THE OWNER FOR THIS PROJECT AT THIS SITE AND IS NOT TO BE USED FOR ANY OTHER PURPOSE, LOCATION OR OWNER WITHOUT WRITTEN CONSENT OF THE ENGINEER.



TWO STORY SINGLE FAMILY DWELLING BALASUBRAMANI RESIDENCE 34-1 OVERIDGE LANE WILTON, CT


Job Number: 18-3456

8/1/18

Issued For:	Date:
APPROVAL	8/15/18
PERMIT	8/16/18

L			
	REVISION	Date:	
	DIMENSIONED FOUND. PLAN	10/29/18	
	COORDINATED DIMS. BETWEEN FLOOR PLANS		

Drawn By: Checked By:

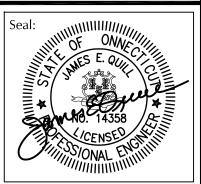

Sheet Title: **ROOF** FRAMING PLAN

**AS NOTED** 

Sheet Number:

# STRUCTURAL NOTES

- d. ALL FOUNDATIONS SHALL BE PLACED ON UNDISTURBED SOIL OR COMPACTED STRUCTURAL FILL. BEARING CAPACITY OF 3,000 LBS. IS ESTIMATED. DETERMINATION OF FINAL BEARING ELEVATIONS AND FIELD VERIFICATION OF ALLOWABLE BEARING PRESSURE SHALL BE MADE BY A QUALIFIED GEOTECHNICAL ENGINEER FROM ALTLANTIC CONSULTING ENGINEERING (203) 336-4422 PRIOR TO PLACING FOUNDATIONS.
- e. CONCRETE FOR FOUNDATIONS SHALL BE PLACED ON THE SAME DAY SUBGRADE APPROVAL IS GIVEN BY THE GEOTECHNICAL ENGINEER.
- f. ALL FOUNDATIONS SUSCEPTIBLE TO FROST SHALL BEAR A MINIMUM OF 42 INCHES BELOW GRADE. IN CASE OF CONFLICT, NOTIFY THE ARCHITECT AND STRUCTURAL ENGINEER IN ADVANCE OF ANY CONSTRUCTION TO ALLOW FOR ADJUSTMENT.
- g. UTILITY LINES SHALL NOT BE PLACED THROUGH OR BELOW FOUNDATIONS WITHOUT THE STRUCTURAL ENGINEER'S APPROVAL.
- h. THE SLOPE BETWEEN THE LOWER EDGES OF ADJACENT FOOTINGS SHALL NOT EXCEED 45 DEGREES WITH THE HORIZONTAL, UNLESS NDICATED OTHERWISE IN THE GEOTECHNICAL
- i. NEW FOOTING BEARING ELEVATIONS ARE TO MATCH ADJACENT EXISTING FOOTING BEARING ELEVATIONS WHERE APPLICABLE UNLESS INDICATED OTHERWISE ON PLANS.
- PROVIDE CONTINUOUS WATERSTOP AT ALL HORIZONTAL AND VERTICAL CONSTRUCTION JOINTS IN ALL ELEVATOR PIT AND OTHER PIT WALLS.
- k. ALL SHORING, SHEETING, AND DEWATERING SHALL BE THE TOTAL RESPONSIBILITY OF THE CONTRACTOR. SHEETING AND SHORING SHALL BE DESIGNED BY THE CONTRACTOR'S ENGINEER REGISTERED IN THE PROJECT'S JURISDICTION. ALL SUBMITTALS SHALL BEAR CONTRACTOR'S/ ENGINEERING SEAL AND SIGNATURE.
- I. THE CONTRACTOR SHALL TAKE PRECAUTIONS TO PROTECT ALL EXISTING STRUCTURES, CURBS, STREETS, ETC. FROM DAMAGE BY CONSTRUCTION EQUIPMENT.

#### BACKFILL:

- a. ALL BACKFILL SHALL BE ACCOMPLISHED USING MATERIAL CONSISTING OF BANK RUN GRAVEL, CRUSHED STONE AND/OR MATERIAL APPROVED BY THE GEOTECHNICAL ENGINEER, WITH OPTIMUM MOISTURE CONTENT FOR COMPACTING AND SHALL BE FREE OF ANY DEBRIS.
- b. WHERE THE FINAL GRADE ELEVATIONS ARE APPROXIMATELY EQUAL ON BOTH SIDES OF A WALL, BACKFILL IN LIFTS TO MAINTAIN LEVEL ELEVATIONS WITHIN 12" ON BOTH SIDES AT ANY TIME.

## 3. STRUCTURAL FILL:

REFER TO SPECIFICATIONS AND GEOTECHNICAL REPORT REQUIREMENTS FOR COMPACTED STRUCTURAL FILL. REQUIREMENTS CONTAINED IN THE GEOTECHNICAL REPORT ARE PART OF THIS WORK. INSPECTION OF THE PLACEMENT OF COMPACTED STRUCTURAL FILL SHALL BE BY SPECIAL INSPECTOR AND OR TESTING LAB.

## H. CONCRETE:

## CAST-IN-PLACE:

a. REINFORCING STEEL CLEAR COVER SHALL BE AS FOLLOWS, UNLESS NOTED OTHERWISE: CONCRETE CAST AGAINST AND PERMANENTLY EXPOSED TO EARTH..... CONCRETE EXPOSED TO EARTH OR WEATHER-#6 AND LARGER... #5 BARS AND SMALLER.. CONCRETE NOT EXPOSED TO WEATHER OR IN CONTACT WITH GROUND-SLABS, WALL, & JOISTS:

#11 BARS AND SMALLER...

- b. CORE DRILLING OF FOUNDATIONS, BEAMS, JOISTS, SLABS OR COLUMNS SHALL NOT BE PERMITTED UNLESS AUTHORIZED IN WRITING BY THE STRUCTURAL ENGINEER.
- c. NO SPLICES OF REINFORCEMENT SHALL BE PERMITTED EXCEPT AS DETAILED OR AUTHORIZED BY THE STRUCTURAL ENGINEER. MAKE BARS CONTINUOUS AROUND CORNERS. WHEN PERMITTED, SPLICES SHALL BE MADE BY CONTACT TENSION LAP SPLICES, UNLESS OTHERWISE
- d. ALL NSERTS AND SLEEVES SHALL BE CAST-IN-PLACE WHENEVER FEASIBLE. DRILLED OR POWDER DRIVEN FASTENERS WILL BE PERMITTED WHEN PROVEN TO THE SATISFACTION OF THE STRUCTURAL ENGINEER THAT THE FASTENERS WILL NOT SPALL THE CONCRETE AND HAVE THE SAME CAPACITY AS CAST-IN-PLACE INSERTS.
- e. WHEN NSTALLING EXPANSION BOLTS OR ADHESIVE ANCHORS. THE CONTRACTOR SHALL TAKE MEASURES TO AVOID DRILLING OR CUTTING OF ANY EXISTING REINFORCING AND DESTRUCTION OF CONCRETE. HOLES SHALL BE BLOWN CLEAN PRIOR TO PLACING BOLTS OR ADHESIVE ANCHORS.
- f. CHAMFER ALL EXISTING OR EXPOSED CONCRETE CORNERS ¼ x ½" x ½" MINIMUM, SMOOTH FOR SKIM FINISH UNLESS NOTED OTHERWISE ON ARCHITECTURAL DRAWINGS.
- THE CONCRETE SLABS SHALL BE FINISHED FLAT AND LEVEL WITHIN TOLERANCE, TO THE ELEVATION INDICATED ON THE DRAWINGS. CONTRACTOR SHALL PROVIDE ADDITIONAL CONCRETE REQUIRED DUE TO FORMWORK AND FRAMING DEFLECTION TO ACHIEVE THIS FINISHED TOP OF SLAB ELEVATION.
- CONSTRUCTION JOINTS FOR SLABS ON METAL DECK SHALL BE LOCATED MIDWAY BETWEEN BEAMS WHERE THE JOINT IS PARALLEL TO THE BEAM SPAN. JOINTS SHALL BE LOCATED WITHIN THE MIDDLE THIRD OF SPAN WHERE THE JOINT IS PERPENDICULAR TO THE BEAM SPAN. THE CONTRACTOR SHALL SUBMIT, (FOR APPROVAL) A SHOP DRAWING, INDICATING ALL PROPOSED JOINT LOCATIONS AND ALL REINFORCING STEEL TO BE PLACED IN THE SLAB. ANY STOP IN CONCRETE WORK MUST BE MADE WITH VERTICAL BULKHEADS, UNLESS OTHERWISE SHOWN. ALL REINFORCING IS TO BE CONTINUOUS THROUGH JOINTS. SLABS SHALL NOT HAVE JOINTS IN A HORIZONTAL PLANE UNLESS SHOWN OTHERWISE.
- WELDED WIRE FABRIC REINFORCEMENT SHALL BE SUPPLIED IN SHEETS. LAP TWO FULL MESH LENGTHS AT SPLICES AND WIRE TOGETHER. STAGGER SHEETS TO AVOID MULTIPLE LAPS @
- CONCRETE ENGINEERED REINFORCING FIBERS SHALL BE POLYPROPYLENE, COLLATED FIBRILLATED FIBERS. POLYPROPYLENE FIBERS SHALL BE USED ONLY IN STRICT ACCORDANCE WITH THE MANUFACTURER'S RECOMMENDATIONS. USE 1.5 POUND BAGS PER ONE CUBIC YARD OF CONCRETE. THE FIBER MANUFACTURER OR APPROVED DISTRIBUTOR SHALL PROVIDE THE SERVICES OF A QUALIFIED EMPLOYEE FOR A PRE JOB MEETING AND INITIAL JOB START
- k. NO WELDING OF REINFORCING SHALL BE PERMITTED UNLESS SPECIFICALLY CALLED FOR OR APPROVED BY THE STRUCTURAL ENGINEER.
- b. ALL FOUNDATIONS SHALL BE PLACED ON UNDISTURBED SOIL OR COMPACTED STRUCTURAL FILL. DETERMINATION OF FINAL BEARING ELEVATIONS AND FIELD VERIFICATION OF ALLOWABLE BEARING PRESSURE SHALL BE MADE BY ATLANTIC CONSULTING AND ENGINEERING DURING HELICAL PILE INSTALLATION.

## A. CODES AND STANDARDS:

- 1. THE FOLLOWING CODES AND STANDARDS, INCLUDING ALL SPECIFICATIONS REFERENCED WITHIN, SHALL APPLY TO THE DESIGN, CONSTRUCTION, QUALITY CONTROL AND SAFETY OF ALL WORK PERFORMED ON THE PROJECT. USE THE LATEST EDITIONS UNLESS NOTED OTHERWISE.
- a. BUILDING CODE OF THE STATE OF CONNECTICUT, RESIDENTIAL CODE OF STATE OF CONNECTICUT.
- b. "INTERNATIONAL BUILDING CODE 2003", BUILDING OFFICIALS AND CODE ADMINISTRATORS, INC. (w/ 2005 CT AMENDMENTS)
- c. "MINIMUM DESIGN LOADS FOR BUILDINGS AND OTHER STRUCTURES": (ANSI/ASCE 7-02), AMERICAN SOCIETY OF CIVIL ENGINEERS.
- d. "BUILDING CODE REQUIREMENTS FOR REINFORCED CONCRETE, ACI 318-02", AMERICAN CONCRETE INSTITUTE.
- e. "MANUAL OF STANDARD PRACTICE", CONCRETE REINFORCING STEEL INSTITUTE.
- f. "MANUAL OF STEEL CONSTRUCTION ALLOWABLE STRESS DESIGN", NINTH EDITION 1989, AMERICAN INSTITUTE OF STEEL CONSTRUCTION (INCLUDING SPECIFICATIONS FOR STRUCTURAL STEEL A325 OR A490 BOLTS, AND AISC CODE OF STANDARD PRACTICE WITH EXCEPTION, IF ANY. AS INDICATED IN THE SPECIFICATIONS).
- g. "STRUCTURAL WELDING CODE ANSI/AWS D1.1-02", AMERICAN WELDING SOCIETY.
- h. "STANDARD SPECIFICATIONS LOAD TABLES AND WEIGHT TABLES FOR STEEL JOISTS AND JOIST GIRDERS", STEEL JOIST INSTITUTE (1994)
- i. "DESIGN MANUAL FOR FLOOR DECKS AND ROOF DECKS", STEEL DECK INSTITUTE.
- "BUILDING CODE REQUIREMENTS FOR MASONRY STRUCTURES (ACI530-02) & SPECIFICATIONS FOR MASONRY STRUCTURES (ACI 530.1-02)

#### B. DESIGN DATA:

```
1. GRAVITY - DESIGN LIVE LOADS
                                                              <u>PSF</u>
    a. LIVING AREA AND DECKS.
        GARAGE...
        ATTIC WITHOUT STORAGE.
    d. GROUND SNOW LOAD...
                                                    ...(Pg) = 60
```

(1) BASIC WIND SPEED: 100 MPH EXPOSURE: C

- 30+ DRIFTING SNOW AS APPLICABLE 1.0 e. LIVE ROOF..... ...MIN. 30 (REDUCIBLE) f. LIVE LOAD AT ALL OTHER AREAS .
- 2. LATERAL LOADS WIND a. MAIN WIND-FORCE RESISTING SYSTEM:
  - (2) IMPORTANCE FACTOR (I): 1.0
- b. COMPONENTS & CLADDING TO BE DESIGNED IN
- ACCORDANCE WITH ANSI/ASCE 7-02.
- c. NET WIND UPLIFT: 22± PSF
- d. LATERAL EQUIVALENT FLUID PRESSURE 30 PSF/FT (1) ACTIVE CONDITION

### C. FOUNDATIONS/GEOTECHNICAL REPORT:

- 1. FOUNDATIONS HAVE BEEN DESIGNED WITH AN ESTIMATED SOIL BEARING PRESSURE OF 4000PSF. GEOTECHNICAL TO BE REPORT PREPARED BY FULLER ENGINEERING UPON REQUEST
- 2. FOUNDATIONS PLACED ON UNDISTURBED SOIL AT ELEVATIONS INDICATED HAVE BEEN DESIGNED FOR AN ALLOWABLE NET BEARING PRESSURE OF 3000 PSF.

## D. MATERIALS:

- 1. PARALLEL STRAND LUMBER (PSL) BEAMS REQUIRED FOR COASTAL CONSTRUCTION. ALL PSL BEAMS EXPOSED TO THE WEATHER AND LOCATED ON THE COAST SHOULD BE PARALLAM PLUS MEMBERS. ALL EXPOSED PSL MEMBERS ARE TO BE FINISHED (WRAPPED) ALWITH AZEK OR EQUIVELANT TRIM BOARDS.
- 2. THE FOLLOWING ASTM STANDARDS AND DESIGN STRENGTH SHALL BE USED FOR THE APPROPRIATE MATERIALS USED IN THE CONSTRUCTION OF THIS PROJECT.
- 3. CEMENT: ASTM C150; TYPE I OR III
- 4. AGGREGATES: ASTM C33 (NORMAL WEIGHT)
- ASTM C330 (STRUCTURAL LIGHTWEIGHT)
- ALL CONCRETE SHALL BE AIR-ENTRAINED 5-7% 1/2% BY VOLUME, AIR-ENTRAINING ADMIXTURE TO COMPLY WITH ASTM C260.

APPLICATION	FC@28 DAYS	WT(PCF)	W/C(MAX
a. SLABS ON GRADE	E 3500	145	0.47
b. GARAGE	3500	145	0.47
c. LIVING	3500	145	0.47
d. FOOTINGS	3500	145	0.47
e. WALLS & PIERS	3500	145	0.47
DEINICODOCIMENT.			

6. REIN	NFORCEMENT:	
a.	DEFORMED RIENFORCINIG BARS	ASTM A615, GRADE 60
b.	WELDABLE DEFORMED REINF. BARS	ASTM A706
C.	WELDED WIRE FABRIC (WWF)	ASTM A185
d.	ADHESIVE REINF. DOWELING SYSTEM	HILTI HIT HY150 SYS. OR EQUAL

## 7. STEEL:

STRUCTURAL PLATES	ASTM A36
HI-STRENGTH STRUCT. STEEL	ASTM A992, GRADE 50
STRUCTURAL PIPE	ASTM A53, GRADE B, FY=35KSI OR
ASTM A501, FY=46KSI	
STRUCTURAL TUBING	ASTM A500, GRADE B, FY=46KSI
HIGH STRENGTH BOLTS	ASTM A325-N
ANCHOR BOLTS	ASTM A307 OR A325 AS NOTED
SMOOTH & THREADED ROD	ASTM A36
WELDING ELECTRODES	AWS A5.1 RO A5.5, E70XX
EXPANSION BOLTS	ITW RAMSET/ REDHEAD, TRU-BOLT,
	WEDGE ANCHOR, HILTI KWIK-BOLT I
ADHESIVE ANCHORING SYSTEM	ITW RAMSET/REDHEAD, EPCON
	SYSTEM, HILTI HVA SYSTEM OR

k. PAINTED METAL FLOOR DECK

I. PAINTED METAL ROOF DECK

- a. LOAD BEARING CONCRETE ASTM C90, TYPE I, GRADE N.
- HOLLOW MASONRY UNITS MIN. COMPRESSIVE STRENGTH ON NET AREA = 3000PSI.
- b. MORTAR ASTM C270-TYPE S c. GROUT ASTM C476-MIN. COMPRESSIVE STRENGTH @ 28 DAYS= 3000PSI. d. HORIZONTAL JOINT ASTM A82; 9 GAUGE TRUSS-TYPE REINFORCING GALV.
- e. PRISM STRENGTH Fm = 2000PSI. PER ACI 530/ASCE 5, UNIT STRENGTH METHOD, INSPECTION

APPROVED EQUAL

ASTM A446

ASTM446

NOTE: SEE DETAILS FOR VERTICAL REINFORCEMENT

#### E. CONSTRUCTION:

### GENERAL:

- REPRODUCTION OF ANY PORTION OF THE STRUCTURAL CONTRACT DRAWINGS FOR RESUBMITTAL AS SHOP DRAWINGS IS PROHIBITED. SHOP DRAWINGS PRODUCED IN SUCH A MANNER WILL BE REJECTED AND RETURNED.
- b. SHOP DRAWINGS SUBMITTED FOR STRUCTURAL REVIEW SHALL CONSIST OF TWO SETS OF PRINTS AND ONE SET OF SEPIAS. ONLY ONE MARKED UP SET OF SEPIAS WITH THE STRUCTURAL ENGINEER'S COMMENTS WILL BE RETURNED TO THE CONTRACTOR.
- c. SUBMIT SHOP DRAWINGS AT LEAST 15 DAYS BEFORE DATE REVIEWED SUBMITTALS WILL BE NEEDED. SHOP DRAWINGS SHALL BEAR THE CONTRACTOR'S STAMP OF APPROVAL WHICH SHALL CONSTITUTE CERTIFICATION THAT HE HAS VERIFIED ALL FIELD MEASUREMENTS, CONSTRUCTION CRITERIA. MATERIALS AND SIMILAR DATA AND HAS CHECKED EACH DRAWING FOR COMPLETENESS, COORDINATION AND COMPLIANCE WITH THE CONTRACT DOCUMENTS.
- d. THESE DRAWINGS REPRESENT THE COMPLETED PROJECT WHICH HAS BEEN DESIGNED FOR THE WEIGHTS OF THE MATERIALS INDICATED ON THE DRAWINGS AND FOR THE SUPERIMPOSED LOADS INDICATED IN THE DESIGN DATA. IT IS THE CONTRACTOR'S RESPONSIBILITY TO DETERMINE ALLOWABLE CONSTRUCTION LOADS AND TO PROVIDE PROPER DESIGN AND CONSTRUCTION OF FALSEWORK, FORMWORK, STAGINGS, BRACING, SHEETING AND SHORING,
- e. IMPLEMENTING JOB SITE SAFETY AND CONSTRUCTION PROCEDURES, TEMPORARY SHORING, AND BRACING OF EXISTING CONSTRUCTION ARE THE SOLE RESPONSIBILITY OF THE CONTRACTOR.
- f. ALL COSTS OF INVESTIGATION AND/OR REDESIGN, DUE TO CONTRACTOR MISLOCATION OF STRUCTURAL ELEMENTS OR OTHER LACK OF CONFORMANCE WITH THE PROJECT DOCUMENTS, SHALL BE AT THE CONTRACTOR'S EXPENSE.
- CONTRACTOR SHALL REFER TO ARCHITECTURAL, MECHANICAL PLUMBING, ELECTRICAL, AND FOOD SERVICE DRAWINGS FOR SIZE AND LOCATIONS OF OPENINGS, SLEEVES, CONCRETE HOUSEKEEPING PADS, INSERTS, AND DEPRESSIONS.
- h. SEE ARCHITECTURAL DRAWINGS AND SPECIFICATIONS FOR DETAILED INFORMATION REGARDING FINISHES, FIREPROOFING, ETC.
- i. SEE ARCHITECTURAL DRAWINGS FOR LOCATIONS OF MASONRY AND DRYWALL NON-LOAD BEARING PARTITIONS. PROVIDE SLIP CONNECTIONS THAT ALLOW VERTICAL MOVEMENT AT THE HEADS OF ALL SUCH PARTITIONS. CONNECTIONS ARE DESIGNED TO SUPPORT THE TOP OF THE WALLS LATERALLY FOR THE CODE-REQUIRED LATERAL LOAD. PROVIDE COMPRESSIBLE FIRESAFING AT TOP OF WALL AS REQUIRED BY ARCHITECTURAL DRAWINGS.
- THE CONTRACTOR SHALL SUBMIT, FOR REVIEW, DRAWINGS AND CALCULATIONS FOR ALL OF THE FOLLOWING ASSEMBLIES. THE DESIGN OF THESE ASSEMBLIES IS THE RESPONSIBILITY OF THE CONTRACTOR'S ENGINEER REGISTERED IN THE PROJECT'S JURISDICTION. ALL SUBMITTALS SHALL BEAR THIS ENGINEER'S SEAL & SIGNATURE. REVIEW SHALL BE FOR GENERAL CONFORMANCE WITH THE PROJECT PARAMETERS AS INDICATED ON THE DRAWINGS AND IN THE
- (1) METAL STAIRS AND METAL RAILINGS: DESIGNS SHALL TAKE INTO ACCOUNT ALL VERTICAL AND LATERAL LOADS REQUIRED BY APPLICABLE BUILDING CODES. WHERE HEADERS OR OTHER TYPES OF STRUCTURAL MEMBERS HAVE BEEN DESIGNATED BY THE STRUCTURAL ENGINEER OF RECORD TO SUPPORT THE STAIRS, THE CONNECTIONS FROM THE STAIRS SHALL BE DESIGNED SO THAT NO ECCENTRIC OR TORSIONAL FORCES ARE INDUCED IN THESE STRUCTURAL MEMBERS. THE CONTRACTOR SHALL BE RESPONSIBLE FOR FURNISHING AND INSTALLING EMBEDS AND HARDWARE AS REQUIRED BY THE STAIR DESIGNER
- k. IN CASE OF CONFLICT BETWEEN THE GENERAL NOTES, DETAILS AND SPECIFICATIONS, THE MOST RIGID REQUIREMENTS SHALL GOVERN.
- I. CONTRACTOR SHALL FURNISH DIMENSIONED SHOP DRAWINGS AT ALL LEVELS LOCATING FLOOR AND ROOF EDGES FOR REVIEW BY THE ARCHITECT AND STRUCTURAL ENGINEER.
- m. CONTRACTOR SHALL FURNISH DIMENSIONED COORDINATED SHOP DRAWINGS AT ALL LEVELS SHOWING THE LOCATIONS OF ALL SLEEVES AND OPENINGS REQUIRED BY ALL TRADES.

## F. INSPECTION AND TESTING:

## 1. GENERAL:

a. THE CONTRACTOR WILL NOTIFY FAIRFIELD TESTING LABORATORIES @ 203-336-5900 &/ OR ATLANTIC CONSULTING (SPECIAL INSPECTORS) TO PROVIDE SERVICES AS INDICATED BELOW. THE OWNER SHALL BEAR ALL EXPENSES OF THIS WORK.

## b. CAST-IN-PLACE CONCRETE:

- (1) THE SPECIAL INSPECTOR SHALL INSPECT THE FORMWORK AND REINFORCING STEEL PLACEMENT FOR COMPLIANCE WITH THE CONTRACT DOCUMENTS AND SHOP DRAWINGS. THE SPECIAL INSPECTOR SHALL MONITOR ALL STRUCTURAL CONCRETE PLACEMENT FOR CONFORMANCE WITH APPLICABLE ACI REQUIREMENTS.
- ESTING AGENCY SHALL SAMPLE FRESH CONCRETE IN ACCORDANCE WITH ASTM C172. MOLD TEST CYLINDERS IN ACCORDANCE WITH ASTM C31. MEASURE AIR ENTRAINMENT IN ACCORDANCE WITH ASTM C231 AND PERFORM SLUMP TESTS IN ACCORDANCE WITH

RESULTS INDICATE SPECIFIED CONCRETE STRENGTHS HAVE NOT BEEN ATTAINED.

COMPRESSION TESTS SHALL BE MADE IN ACCORDANCE WITH ASTM C39. (4) THE AGENCY WILL MAKE ADDITIONAL TESTS OF IN-PLACE CONCRETE AT THE CONTRACTOR'S EXPENSE, AS DIRECTED BY THE STRUCTURAL ENGINEER, WHEN TEST

# c. MASONRY:

- (1) THE SPECIAL INSPECTOR SHALL MONITOR THE PROPORTIONING, MIXING AND CONSISTENCY OF MORTAR AND GROUT; THE PLACEMENT OF MORTAR, GROUT AND MASONRY UNITS; AND THE PLACEMENT OF REINFORCING STEEL FOR COMPLIANCE WITH THE CONTRACT DOCUMENTS.
- TESTING AGENCY SHALL PERFORM COMPRESSION TEST MASONRY PRISMS FOR EACH TYPE OF WALL CONSTRUCTION IN ACCORDANCE WITH ASTM E447,
- THE CONTRACTOR SHALL PREPARE ONE SET OF PRISMS FOR TESTING AT 7 DAYS AND ONE SET FOR TESTING AT 28 DAYS. TESTS ARE TO BE CONDUCTED BY THE AGENCY FOR EACH 3000 SQUARE FEET OF WALL INSTALLED, BUT NOT LESS THAN 2

## d. STRUCTURAL STEEL:

- (1) SPECIAL INSPECTOR SHALL VISUALLY INSPECT ALL FILLET WELDS, BOLTED CONNECTIONS AND SHEAR STUDS.
- (2) THE TESTING AGENCY SHALL MONITOR THE INSTALLATION OF BOLTS REQUIRING
- PRETENSIONING FOR CONFORMANCE WITH SPECIFIC PRE-CALIBRATED TIGHTENING
- (3) EACH FULL PENETRATION BUTT OR GROOVE WELD AND FIFTY PERCENT OF PARTIAL PENETRATION WELDS SHALL BE TESTED BY THE ULTRASONIC METHOD. AND MULTI-PASS WELDS SHALL BE TESTED BY THE MAGNETIC PARTICLE METHOD.
- 10% OF ALL FIELD FILLET WELDS IN PRIMARY CONNECTIONS (5) TEST ANY WELD FOR WHICH VISUAL EXAMINATION INDICATES AN UNUSUAL CONDITION
- AND/OR POOR QUALITY. WELDING INSPECTION AND TESTING PROCEDURES SHALL BE IN ACCORDANCE WITH THE AWS CODE.

### G. FOUNDATIONS & STRUCTURAL EARTHWORK:

## GENERAL:

F-"X"

- SEE THE SPECIFICATIONS AND GEOTECHNICAL REPORT REQUIREMENTS FOR EXCAVATION AND PREPARATION OF THE FOUNDATION AND SLAB-ON-GRADE SUBGRADE, INCLUDING COMPACTION PROCEDURES. REQUIREMENTS CONTAINED IN THE GEOTECHNICAL REPORT ARE PART OF THIS
- b. CONTRACTOR SHALL VERIFY ALL EXISTING FIELD CONDITIONS THAT MAY AFFECT THE INSTALLATION OF THE FOUNDATION SYSTEM AS SHOWN PRIOR TO STARTING WORK.
- c. EXISTING UTILITIES KNOWN TO BE IN THE CONSTRUCTION AREA HAVE BEEN INDICATED. THE SIZE, LOCATION AND DEPTH OF THE UTILITIES ARE NOT KNOWN EXACTLY AND MAY VARY SIGNIFICANTLY FROM THAT INDICATED. OTHER UNKNOWN UTILITIES NOT INDICATED MAY ALSO BE PRESENT. THE CONTRACTOR SHALL BE RESPONSIBLE FOR LOCATING AND PROTECTING ALL EXISTING UTILITIES, WHETHER INDICATED OR NOT, WHICH MAY BE AFFECTED BY THE CONSTRUCTION PROCESS.

## **ABBREVIATIONS**

TOW	INDICATES TOP OF WALL ELEVATION
TOS	INDICATES TOP OF STEEL OR TOP OF SHELF ELEVATION
BOF	INDICATES BOTTOM FOOTING ELEVATION


INDICATES FOOTING STEP. SEE TYPICAL DETAIL

INDICATES CONCRETE FOOTING.

CJ INDICATES CONTROL OR CONSTRUCTION JOINT. SEE TYPICAL DETAIL

PROPERTY OF THE ENGINEER. IT HAS BEEN SPECIFICALLY PREPARED FOR THE OWNER FOR THIS PROJECT AT THIS SITE AND IS NOT TO BE USED FOR ANY OTHER PURPOSE, LOCATION OR OWNER WITHOUT WRITTEN CONSENT OF THE ENGINEER.

THIS DRAWING IS THE

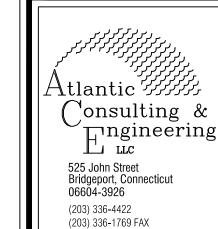

DWELLIN IDENCE NNE FAMILY [
NI RESIL
DGE LA!
N, CT / SINGLE I JBRAMAI I OVERIE WILTON

info@atlantic-eng.com


TORY LASUI 34-1 0/2 Job Number:

18-3456 art Date: 8/1/18

Date:
8/15/18
8/16/18

REVISION	Date:
DIMENSIONED FOUND. PLAN	10/29/1
COORDINATED DIMS. BETWEEN FLOOR PLANS	

Drawn By: Checked By:

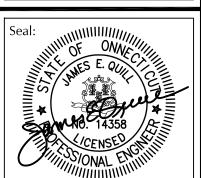

Sheet Title: STRUCTURAL

NOTES

AS NOTED

Sheet Number: